

Janice M. Winfrey
City Clerk

City of Detroit
OFFICE OF THE CITY CLERK

Andre P. Gilbert II
Deputy City Clerk

DEPARTMENT PETITION REFERENCE COMMUNICATION

To: The Department or Commission Listed Below

From: Janice M Winfrey, Detroit City Clerk

The following petition is herewith referred to you for report and recommendation to the City Council.

In accordance with that body's directive, kindly return the same with your report in duplicate within four (4) weeks.

Petition No.	2026-082
Name of Petitioner	Greektown Neighborhood Partnership
Description of Petition	Petition to request for multiple encroachments within the Monroe St., 50 ft. wide, right-of-way, from Randolph St. east to the I-375 Service Drive for non-standard items.
Type of Petition	Alley Vacation/Encroachment/Utility Vacation
Submission Date	04/30/26
Concerned Departments	Media Services, Building & Safety Engineering, Police Department, Fire Department, Municipal Parking Department, Transportation Department, Health Department, General Services Department
Petitioner Contact	Greektown Neighborhood Partnership 400 Monroe Detroit, MI. 48226



**CITY OF DETROIT
DEPARTMENT OF PUBLIC WORKS
CITY ENGINEERING DIVISION**

**COLEMAN A. YOUNG MUNICIPAL CENTER
2 WOODWARD AVE. SUITE 601
DETROIT, MICHIGAN 48226
PHONE: (313) 224-3949 TTY: 711
WWW.DETROITMI.GOV**

To: Clerk's Office
From: The Department of Public Works
City Engineering Division
MapsandRecordsBureau@DetroitMI.Gov
(313) 224-3970

Petitioner:
Greektown Neighborhood Partnership
400 Monroe
Detroit, MI 48226

On behalf of the above-mentioned petitioner the Department of Public Works: City Engineering Division is submitting a petition request for the below mentioned action. The petitioner has received a project consultation from the Department of Public Works: City Engineering Division and has been advised the following:

Type of action recommended:
Greektown Neighborhood Partnership, request for multiple encroachments within the Monroe St., 50 ft. wide, right-of-way, from Randolph St. east to the I-375 Service Drive for non-standard items.

Georgine Gersdorff
Manager II
Department of Public Works
City Engineering Division
313-224-3985

February 25, 2025

Detroit City Council
1340 Coleman A. Young Municipal Center
2 Woodward Ave
Detroit, MI 48226

Re PETITION – Monroe Streetscape Encroachment of Right of Way

Hello,

This is a petition for your approval to encroach into the Public Right of Way in Greektown with streetscape items that are not City standard. The Monroe Streetscape project includes a curbless street design with high quality materials and an emphasis on making the street safer for pedestrians. The Greektown Neighborhood Partnership (GNP) has continuously coordinated with the City on the project for several years, including community engagement, planning, design, and pre-construction, and it is understood by the GNP that we will maintain these non-standard items within the right of way. The GNP will enter into a maintenance agreement with the City of Detroit for the below items long-term maintenance.

The only item listed below that will not be maintained directly by the GNP is fencing. The GNP has executed a Memorandum of Understanding with the property owner at 1250 Brush Street and at 1201 St Antoine stating the property owner will provide long-term maintenance of the fencing that is within the Right of Way and adjacent to their property lines.

The following items are not City standard and encroaching into the City Right of Way:

- Granite Paving
 - Granite Pavers, Pedestrian
 - Granite Pavers, Vehicular
 - Tile Type 1, Guideway
 - Tile Type 2, Detectable Warning
 - Tile Type 3, Contrast Strip
- Stone Planter Curb and Plantings
- Bollard
 - Bollard, Fixed
 - Bollard, Removable
 - Bollard, Removable Receptacle
- Fencing
 - Fence, Type 1
- Light Poles and attachments

- Tree Grates and Trees
- Soil Cell System
- Irrigation System
- Bike Racks
- Event Power (E Series plan set)
 - Handholes, Ground boxes, conduit, and wire for the non-PLA electrical system

Regards,



Athina Papas
Board Chair and President
Greektown Neighborhood Partnership

**GREKTOWN
CORRIDOR
DEVELOPMENT**
400 MONROE ST, STE 340
DETROIT, MI 48226


Owner:
**GREKTOWN
NEIGHBORHOOD
PARTNERSHIP**

SMITHGROUP
201 DEPOT STREET
ANN ARBOR, MI 48104
734.652.2627
www.smithgroup.com

fishbeck
fishbeck engineering architects
100 Woodward Ave, 20th Fl
ANN ARBOR, MI 48106
734.232.3200

REINFORCEMENT CONTRACTOR
2000 Seward Rd
Ann Arbor, MI 48106
734.964.1010

NO.	DATE	DESCRIPTION
1	10/15/14	ISSUED FOR PERMIT
2	11/10/14	ISSUED FOR PERMIT
3	11/10/14	ISSUED FOR PERMIT
4	11/10/14	ISSUED FOR PERMIT
5	11/10/14	ISSUED FOR PERMIT
6	11/10/14	ISSUED FOR PERMIT
7	11/10/14	ISSUED FOR PERMIT
8	11/10/14	ISSUED FOR PERMIT

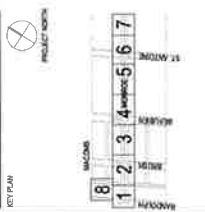

DRAWING TITLE
SITE LAYOUT PLAN - AREA
06

SCALE
SCALE: 1"=10' FEET

PROJECT NUMBER
18228.001

DRAWING NUMBER
CS106

SHEET NOTES



1. MANHOLE LOCATIONS SHOWN AT BACK SIDE OF THE COVER.
2. CURB STATIONING SHOWN AT BACK OF CURB.
3. CURB STATIONING AND MANHOLE STATIONING SHOWN AT CENTER POINT.
4. SEE MATERIAL PLANS FOR IMPAVMENT TYPES.

KEYED NOTES

(A) TILE SEE ON SHEET FOR TYPE
(B) BOLLARD, REMOVABLE
(C) PARKING COORFINO
(D) SIGNAL CURB NET

LEGEND

- PROJECT LIMITS
- POINT OF BEGINNING
- STONE PAVEMENT CURB
- CONCRETE CURB, DETAIL CALL MONROE
- CURB AND GUTTER, CONC
- LIGHT POLE, USE ELECTRICAL PLANS
- BOLLARD, FIXED
- BOLLARD, REMOVABLE
- BOLLARD, REMOVABLE RECEPTACLE
- TREE GRAVE AND FRAME, 4 FT X 6 FT
- FENCE
- BIKE RACK
- FENCE TOPPER
- TILE TYPE I, GUIDE WAY
- TILE TYPE I, DETECTABLE WARNING

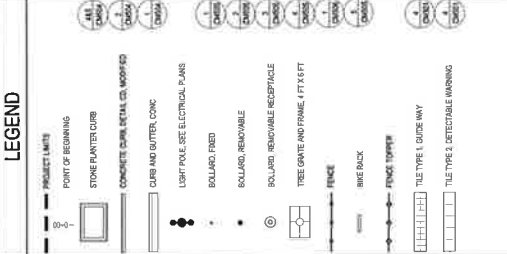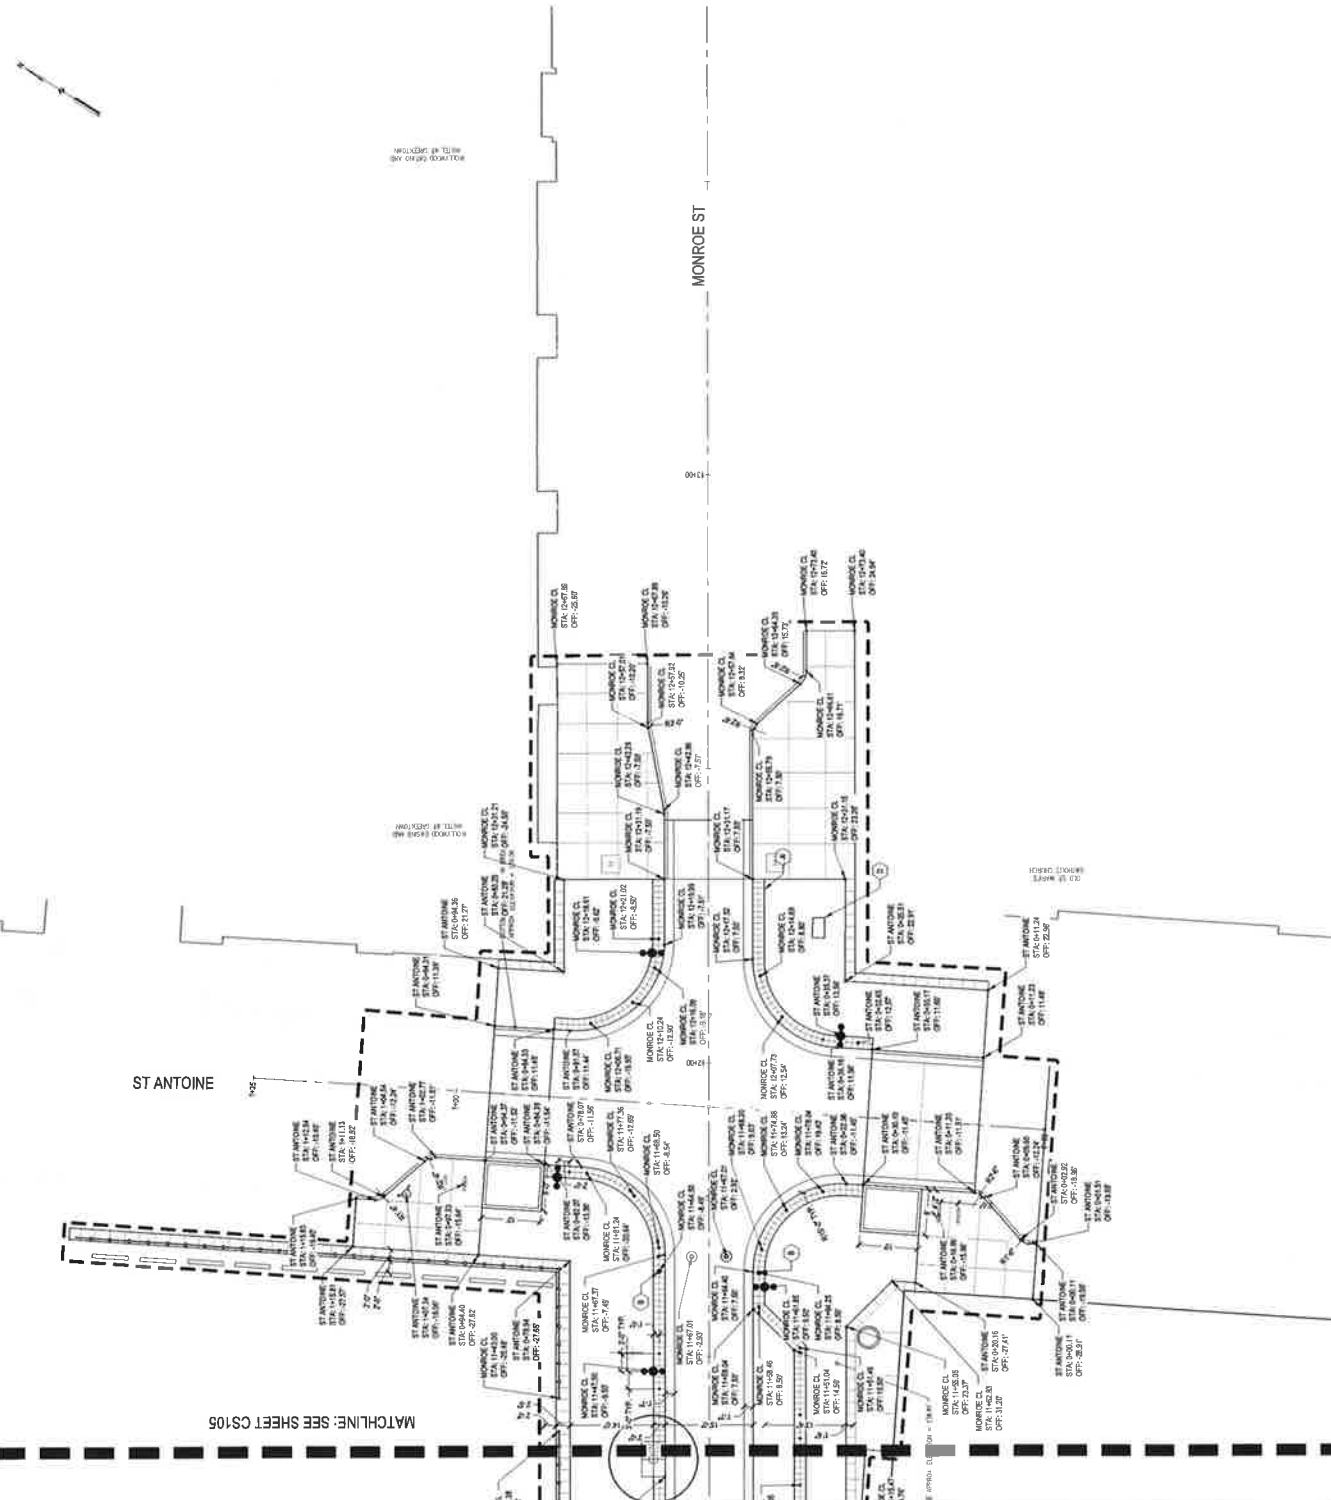MATCHLINE: SEE SHEET CS105

**GREETTOWN
CORRIDOR
DEVELOPMENT**
400 MONROE ST, STE 340
DETROIT, MI 48226

OWNER:
**GREETTOWN
NEIGHBORHOOD
PARTNERSHIP**

SMITHGROUP

201 DEPOUT STREET
ANN ARBOR, MI 48104
734.769.7000
www.smithgroup.com




100 Woodward Ave. 28th Fl.
Detroit, MI 48226
313.224.3322

WITH ADDITIONAL DUTIES:
3000 So. Woodward
Livonia, Michigan 48150
Tel: 313.487.1000

PROJECT NO. 15022002
REV. CD 07
07/26/2024
REV. CD 27
07/26/2024
REV. CD 28
07/26/2024


DATE PLOTTED: 07/26/2024

SCALE: AS SHOWN

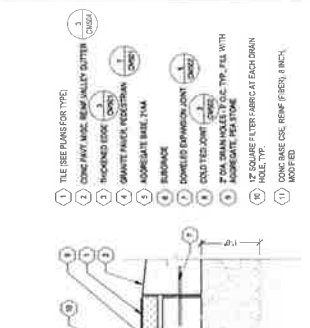


- 1 TILE (SEE PLANS FOR TYPE)
- 2 CONC BASE MISC. NONREINF. 6 INCH, MODIFIED
- 3 THICKENED EDGE (DEPTH LABEL)
- 4 GRANITE PAVERS, PEDESTRIAN
- 5 CONC PAVT. MISC. NONREINF. 6 INCH, MODIFIED
- 6 CONC BASE MISC. NONREINF. 6 INCH, MODIFIED
- 7 1" SAND SETTING BED
- 8 2" DIA. DRAIN HOLES - 5 O.C. TYP. FILL WITH AGGREGATE, P.O.A. STONE
- 9 1" SQUARE FILTER FABRIC AT EACH DRAIN HOLE, TYP.
- 10 7" SAND JOINTS
- 11 CONC BASE MISC. NONREINF. 6 INCH, MODIFIED
- 12 AGGREGATE BASE, 2 1/4" COMPACTED SUBGRADE

SCALE: 1" = 1'-0"

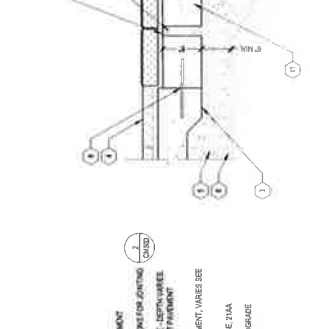


- 1 CONCRETE PAVEMENT
- 2 REFER TO SECTION FOR JOINTING
- 3 THICKENED EDGE (DEPTH LABEL)
- 4 GRANITE PAVERS, PEDESTRIAN
- 5 CONC PAVT. MISC. NONREINF. 6 INCH, MODIFIED
- 6 CONC BASE MISC. NONREINF. 6 INCH, MODIFIED
- 7 COMPACTED SUBGRADE

SCALE: 1" = 1'-0"

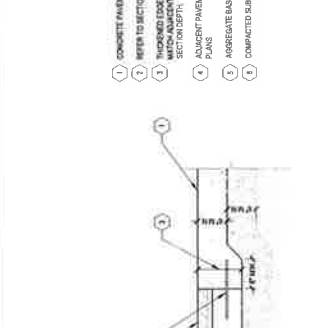


- 1 CONCRETE PAVEMENT
- 2 CONC PAVT. MISC. NONREINF. 6 INCH, MODIFIED
- 3 THICKENED EDGE (DEPTH LABEL)
- 4 GRANITE PAVERS, PEDESTRIAN
- 5 CONC PAVT. MISC. NONREINF. 6 INCH, MODIFIED
- 6 CONC BASE MISC. NONREINF. 6 INCH, MODIFIED
- 7 COMPACTED SUBGRADE

SCALE: 1" = 1'-0"

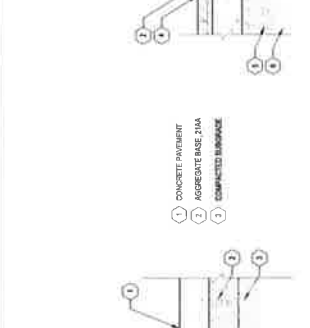


- 1 CONCRETE PAVEMENT
- 2 CONC PAVT. MISC. NONREINF. 6 INCH, MODIFIED
- 3 THICKENED EDGE (DEPTH LABEL)
- 4 GRANITE PAVERS, PEDESTRIAN
- 5 CONC PAVT. MISC. NONREINF. 6 INCH, MODIFIED
- 6 CONC BASE MISC. NONREINF. 6 INCH, MODIFIED
- 7 COMPACTED SUBGRADE

SCALE: 1" = 1'-0"

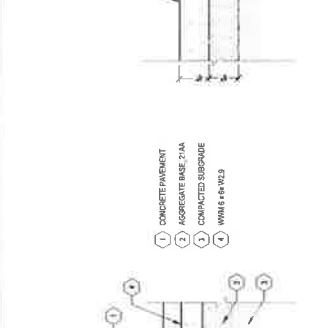

- 1 CONCRETE PAVEMENT
- 2 CONC PAVT. MISC. NONREINF. 6 INCH, MODIFIED
- 3 THICKENED EDGE (DEPTH LABEL)
- 4 GRANITE PAVERS, PEDESTRIAN
- 5 CONC PAVT. MISC. NONREINF. 6 INCH, MODIFIED
- 6 CONC BASE MISC. NONREINF. 6 INCH, MODIFIED
- 7 COMPACTED SUBGRADE

SCALE: 1" = 1'-0"

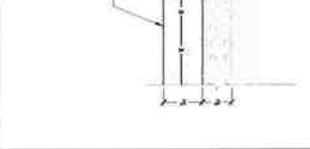


- 1 CONCRETE PAVEMENT
- 2 CONC PAVT. MISC. NONREINF. 6 INCH, MODIFIED
- 3 THICKENED EDGE (DEPTH LABEL)
- 4 GRANITE PAVERS, PEDESTRIAN
- 5 CONC PAVT. MISC. NONREINF. 6 INCH, MODIFIED
- 6 CONC BASE MISC. NONREINF. 6 INCH, MODIFIED
- 7 COMPACTED SUBGRADE

SCALE: 1" = 1'-0"




- 1 GRANITE PAVERS, PEDESTRIAN
- 2 SAND SETTING BED
- 3 2" DIA. DRAIN HOLES - 5 O.C. TYP. FILL WITH AGGREGATE, P.O.A. STONE
- 4 1" SQUARE FILTER FABRIC AT EACH DRAIN HOLE, TYP.
- 5 7" SAND JOINTS
- 6 CONC BASE MISC. NONREINF. 6 INCH, MODIFIED
- 7 AGGREGATE BASE, 2 1/4" COMPACTED SUBGRADE

SCALE: 1" = 1'-0"

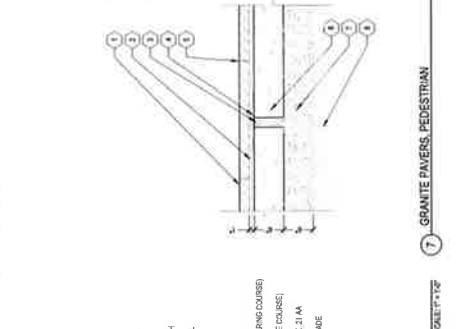


- 1 GRANITE PAVERS, PEDESTRIAN
- 2 SAND SETTING BED
- 3 2" DIA. DRAIN HOLES - 5 O.C. TYP. FILL WITH AGGREGATE, P.O.A. STONE
- 4 1" SQUARE FILTER FABRIC AT EACH DRAIN HOLE, TYP.
- 5 7" SAND JOINTS
- 6 CONC BASE MISC. NONREINF. 6 INCH, MODIFIED
- 7 AGGREGATE BASE, 2 1/4" COMPACTED SUBGRADE

SCALE: 1" = 1'-0"

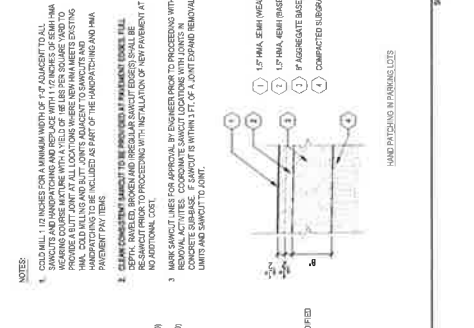


- 1 GRANITE PAVERS, PEDESTRIAN
- 2 SAND SETTING BED
- 3 2" DIA. DRAIN HOLES - 5 O.C. TYP. FILL WITH AGGREGATE, P.O.A. STONE
- 4 1" SQUARE FILTER FABRIC AT EACH DRAIN HOLE, TYP.
- 5 7" SAND JOINTS
- 6 CONC BASE MISC. NONREINF. 6 INCH, MODIFIED
- 7 AGGREGATE BASE, 2 1/4" COMPACTED SUBGRADE

SCALE: 1" = 1'-0"

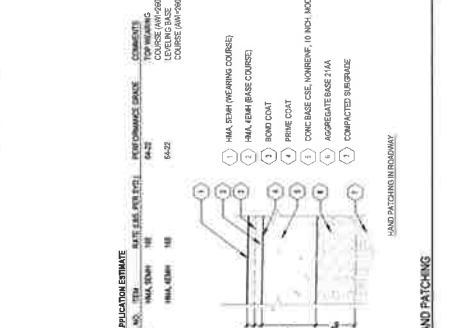


- 1 GRANITE PAVERS, PEDESTRIAN
- 2 SAND SETTING BED
- 3 2" DIA. DRAIN HOLES - 5 O.C. TYP. FILL WITH AGGREGATE, P.O.A. STONE
- 4 1" SQUARE FILTER FABRIC AT EACH DRAIN HOLE, TYP.
- 5 7" SAND JOINTS
- 6 CONC BASE MISC. NONREINF. 6 INCH, MODIFIED
- 7 AGGREGATE BASE, 2 1/4" COMPACTED SUBGRADE

SCALE: 1" = 1'-0"

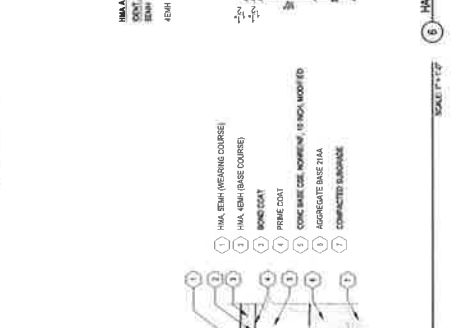


- 1 GRANITE PAVERS, PEDESTRIAN
- 2 SAND SETTING BED
- 3 2" DIA. DRAIN HOLES - 5 O.C. TYP. FILL WITH AGGREGATE, P.O.A. STONE
- 4 1" SQUARE FILTER FABRIC AT EACH DRAIN HOLE, TYP.
- 5 7" SAND JOINTS
- 6 CONC BASE MISC. NONREINF. 6 INCH, MODIFIED
- 7 AGGREGATE BASE, 2 1/4" COMPACTED SUBGRADE

SCALE: 1" = 1'-0"

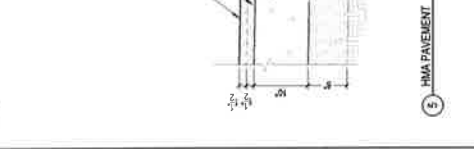


- 1 GRANITE PAVERS, PEDESTRIAN
- 2 SAND SETTING BED
- 3 2" DIA. DRAIN HOLES - 5 O.C. TYP. FILL WITH AGGREGATE, P.O.A. STONE
- 4 1" SQUARE FILTER FABRIC AT EACH DRAIN HOLE, TYP.
- 5 7" SAND JOINTS
- 6 CONC BASE MISC. NONREINF. 6 INCH, MODIFIED
- 7 AGGREGATE BASE, 2 1/4" COMPACTED SUBGRADE

SCALE: 1" = 1'-0"

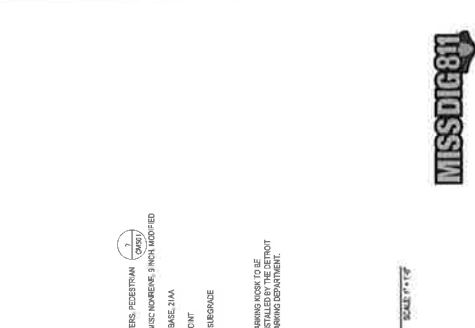


- 1 GRANITE PAVERS, PEDESTRIAN
- 2 SAND SETTING BED
- 3 2" DIA. DRAIN HOLES - 5 O.C. TYP. FILL WITH AGGREGATE, P.O.A. STONE
- 4 1" SQUARE FILTER FABRIC AT EACH DRAIN HOLE, TYP.
- 5 7" SAND JOINTS
- 6 CONC BASE MISC. NONREINF. 6 INCH, MODIFIED
- 7 AGGREGATE BASE, 2 1/4" COMPACTED SUBGRADE

SCALE: 1" = 1'-0"

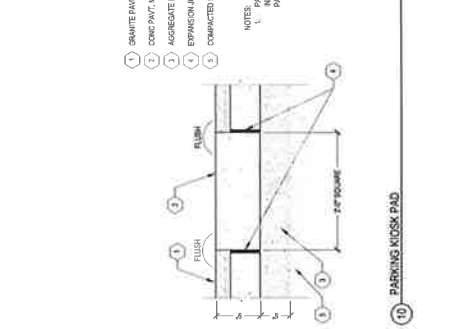


- 1 GRANITE PAVERS, PEDESTRIAN
- 2 SAND SETTING BED
- 3 2" DIA. DRAIN HOLES - 5 O.C. TYP. FILL WITH AGGREGATE, P.O.A. STONE
- 4 1" SQUARE FILTER FABRIC AT EACH DRAIN HOLE, TYP.
- 5 7" SAND JOINTS
- 6 CONC BASE MISC. NONREINF. 6 INCH, MODIFIED
- 7 AGGREGATE BASE, 2 1/4" COMPACTED SUBGRADE

SCALE: 1" = 1'-0"

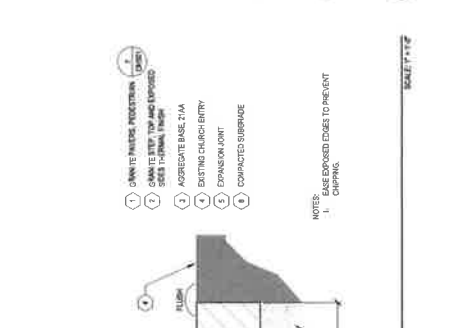


- 1 GRANITE PAVERS, PEDESTRIAN
- 2 SAND SETTING BED
- 3 2" DIA. DRAIN HOLES - 5 O.C. TYP. FILL WITH AGGREGATE, P.O.A. STONE
- 4 1" SQUARE FILTER FABRIC AT EACH DRAIN HOLE, TYP.
- 5 7" SAND JOINTS
- 6 CONC BASE MISC. NONREINF. 6 INCH, MODIFIED
- 7 AGGREGATE BASE, 2 1/4" COMPACTED SUBGRADE

SCALE: 1" = 1'-0"

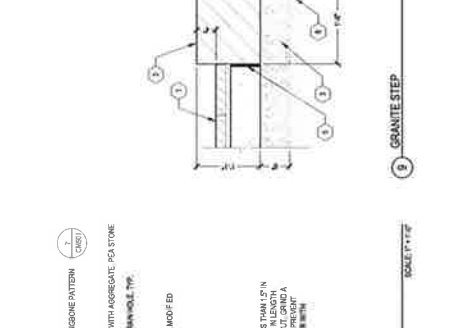


- 1 GRANITE PAVERS, PEDESTRIAN
- 2 SAND SETTING BED
- 3 2" DIA. DRAIN HOLES - 5 O.C. TYP. FILL WITH AGGREGATE, P.O.A. STONE
- 4 1" SQUARE FILTER FABRIC AT EACH DRAIN HOLE, TYP.
- 5 7" SAND JOINTS
- 6 CONC BASE MISC. NONREINF. 6 INCH, MODIFIED
- 7 AGGREGATE BASE, 2 1/4" COMPACTED SUBGRADE

SCALE: 1" = 1'-0"

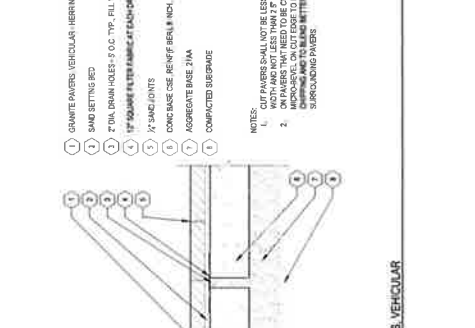

- 1 GRANITE PAVERS, PEDESTRIAN
- 2 SAND SETTING BED
- 3 2" DIA. DRAIN HOLES - 5 O.C. TYP. FILL WITH AGGREGATE, P.O.A. STONE
- 4 1" SQUARE FILTER FABRIC AT EACH DRAIN HOLE, TYP.
- 5 7" SAND JOINTS
- 6 CONC BASE MISC. NONREINF. 6 INCH, MODIFIED
- 7 AGGREGATE BASE, 2 1/4" COMPACTED SUBGRADE

SCALE: 1" = 1'-0"

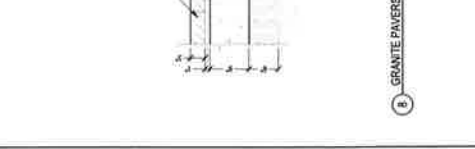

- 1 GRANITE PAVERS, PEDESTRIAN
- 2 SAND SETTING BED
- 3 2" DIA. DRAIN HOLES - 5 O.C. TYP. FILL WITH AGGREGATE, P.O.A. STONE
- 4 1" SQUARE FILTER FABRIC AT EACH DRAIN HOLE, TYP.
- 5 7" SAND JOINTS
- 6 CONC BASE MISC. NONREINF. 6 INCH, MODIFIED
- 7 AGGREGATE BASE, 2 1/4" COMPACTED SUBGRADE

SCALE: 1" = 1'-0"

**GREEKTOWN
CORRIDOR
DEVELOPMENT**
400 MONROE ST., STE 340
DETROIT, MI 48226

Owner:

**GREEKTOWN
NEIGHBORHOOD
PARTNERSHIP**

SMITHGROUP

201 DEPOT STREET
SECOND FLOOR
ANN ARBOR, MI 48104
www.smithgroup.com



fishbeck
1000 Woodward Ave. Ste. 600
Detroit, Michigan 48226
313.963.8000



MISS DIG 811
ELECTRICAL AND LIGHTING
LAYOUT, MICHIGAN 811/2
1-800-487-4877

REVISION	DATE
1	1/15/2014
2	1/15/2014
3	1/15/2014
100	1/15/2014

SCALE: AS NOTED


NO.	DESCRIPTION	DATE
1	CONCRETE CURB	1/15/2014
2	CONCRETE GUTTER	1/15/2014
3	CONCRETE CURB, DETAIL CD, MODIFIED	1/15/2014
4	CONCRETE CURB, DETAIL CD, MODIFIED	1/15/2014
5	CONCRETE CURB, DETAIL CD, MODIFIED	1/15/2014
100	CONCRETE CURB, DETAIL CD, MODIFIED	1/15/2014

SCALE: AS NOTED
PROJECT NUMBER: CM504
DRAWING NUMBER


- NOTES:
1. CONCRETE PAVEMENT
 2. AGGREGATE BASE 2" MIN
 3. 4" REINFORCED CONCRETE, SINGLE WALL BUTTERED LONGITUDINAL JOINTS
 4. 12" MIN REBAR, ENJOY COATED, CONTROL Joints
 5. MIN CLEARANCE FROM EDGE OF CONDA

NOTES:

1. FINISHES IN ALL CASES LOCATIONS VALLEY AND CROSS-SLOPED CONDITIONS

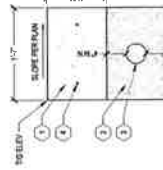

CROSS-SLOPED CONDITION

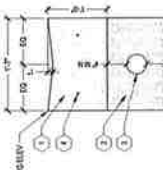

VALLEY CONDITION


3 CONCRETE PAVT, MISC. REINF. VALLEY GUTTER

- NOTES:
1. ADJUSTED FINISH ELEVATIONS REFER TO
 2. WHEN LAYOUT OF CURB IS NOT ADJACENT TO
 3. PAVED DRIVEWAY, FINISH TO
 4. TOP OF CURB IS FINISHED TO GRADING
 5. FINISH ELEVATION NOTED ON GRADING PLAN
 6. 4" MIN ENJOY COURSE, COMPACTED
 7. 12" MIN ENJOY COURSE, COMPACTED
 8. 12" MIN ENJOY COURSE, COMPACTED
 9. 12" MIN ENJOY COURSE, COMPACTED
 10. 12" MIN ENJOY COURSE, COMPACTED
 11. 12" MIN ENJOY COURSE, COMPACTED
 12. 12" MIN ENJOY COURSE, COMPACTED
 13. 12" MIN ENJOY COURSE, COMPACTED
 14. 12" MIN ENJOY COURSE, COMPACTED
 15. 12" MIN ENJOY COURSE, COMPACTED
 16. 12" MIN ENJOY COURSE, COMPACTED
 17. 12" MIN ENJOY COURSE, COMPACTED
 18. 12" MIN ENJOY COURSE, COMPACTED
 19. 12" MIN ENJOY COURSE, COMPACTED
 20. 12" MIN ENJOY COURSE, COMPACTED




2 CONCRETE CURB, DETAIL CD, MODIFIED


- NOTES:
1. FINISH ELEVATIONS REFER TO
 2. WHEN LAYOUT OF CURB IS NOT ADJACENT TO
 3. PAVED DRIVEWAY, FINISH TO
 4. TOP OF CURB IS FINISHED TO GRADING
 5. FINISH ELEVATION NOTED ON GRADING PLAN
 6. 4" MIN ENJOY COURSE, COMPACTED
 7. 12" MIN ENJOY COURSE, COMPACTED
 8. 12" MIN ENJOY COURSE, COMPACTED
 9. 12" MIN ENJOY COURSE, COMPACTED
 10. 12" MIN ENJOY COURSE, COMPACTED
 11. 12" MIN ENJOY COURSE, COMPACTED
 12. 12" MIN ENJOY COURSE, COMPACTED
 13. 12" MIN ENJOY COURSE, COMPACTED
 14. 12" MIN ENJOY COURSE, COMPACTED
 15. 12" MIN ENJOY COURSE, COMPACTED
 16. 12" MIN ENJOY COURSE, COMPACTED
 17. 12" MIN ENJOY COURSE, COMPACTED
 18. 12" MIN ENJOY COURSE, COMPACTED
 19. 12" MIN ENJOY COURSE, COMPACTED
 20. 12" MIN ENJOY COURSE, COMPACTED

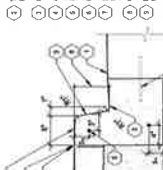

1 CURB AND GUTTER CONC

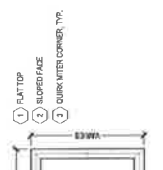


TYPE 2

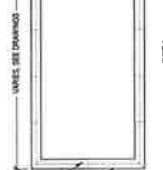

TYPE 1


4 STONE PLANTER

- NOTES:
1. GRANITE PAVT. - CURB
 2. 4" BAR CONT.
 3. FINISH MANUFACTURER'S RECOMMENDATIONS
 4. EXPANSION JOINT
 5. FINISH ELEVATION NOTED ON GRADING PLAN
 6. 4" MIN ENJOY COURSE, COMPACTED
 7. 12" MIN ENJOY COURSE, COMPACTED
 8. 12" MIN ENJOY COURSE, COMPACTED
 9. 12" MIN ENJOY COURSE, COMPACTED
 10. 12" MIN ENJOY COURSE, COMPACTED
 11. 12" MIN ENJOY COURSE, COMPACTED
 12. 12" MIN ENJOY COURSE, COMPACTED
 13. 12" MIN ENJOY COURSE, COMPACTED
 14. 12" MIN ENJOY COURSE, COMPACTED
 15. 12" MIN ENJOY COURSE, COMPACTED
 16. 12" MIN ENJOY COURSE, COMPACTED
 17. 12" MIN ENJOY COURSE, COMPACTED
 18. 12" MIN ENJOY COURSE, COMPACTED
 19. 12" MIN ENJOY COURSE, COMPACTED
 20. 12" MIN ENJOY COURSE, COMPACTED

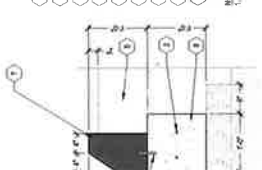

STONE PLANTER CURB ADJACENT TO PAVED

- NOTES:
1. GRANITE PAVT. - CURB
 2. 4" BAR CONT.
 3. FINISH MANUFACTURER'S RECOMMENDATIONS
 4. EXPANSION JOINT
 5. FINISH ELEVATION NOTED ON GRADING PLAN
 6. 4" MIN ENJOY COURSE, COMPACTED
 7. 12" MIN ENJOY COURSE, COMPACTED
 8. 12" MIN ENJOY COURSE, COMPACTED
 9. 12" MIN ENJOY COURSE, COMPACTED
 10. 12" MIN ENJOY COURSE, COMPACTED
 11. 12" MIN ENJOY COURSE, COMPACTED
 12. 12" MIN ENJOY COURSE, COMPACTED
 13. 12" MIN ENJOY COURSE, COMPACTED
 14. 12" MIN ENJOY COURSE, COMPACTED
 15. 12" MIN ENJOY COURSE, COMPACTED
 16. 12" MIN ENJOY COURSE, COMPACTED
 17. 12" MIN ENJOY COURSE, COMPACTED
 18. 12" MIN ENJOY COURSE, COMPACTED
 19. 12" MIN ENJOY COURSE, COMPACTED
 20. 12" MIN ENJOY COURSE, COMPACTED

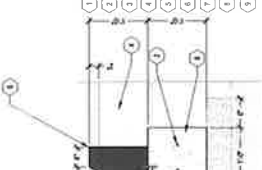

STONE PLANTER CURB ADJACENT TO VALLEY GUTTER

5 STONE PLANTER CURB



**GREKTOWN
CORRIDOR
DEVELOPMENT**
400 MONROE ST., STE 340
DETROIT, MI 48226

OWNER:

**GREKTOWN
NEIGHBORHOOD
PARTNERSHIP**

SMITHGROUP

201 DEPOUT STREET
SECOND FLOOR
ANN ARBOR, MI 48104
313.763.4000
www.smithgroup.com





100 Woodward Ave. 8th Fl.
Detroit, MI 48226
313.224.3333



ELECTRICAL AND LIGHTING
LIVING & WORK AREAS
DETROIT, MI 48226

NO.	DATE
1	1/23/2025
2	1/23/2025
3	1/23/2025
4	1/23/2025
5	1/23/2025
6	1/23/2025
7	1/23/2025
8	1/23/2025

SCALE: AS NOTED
PROJECT NUMBER: 15026 001
DRAWING NUMBER: CM507

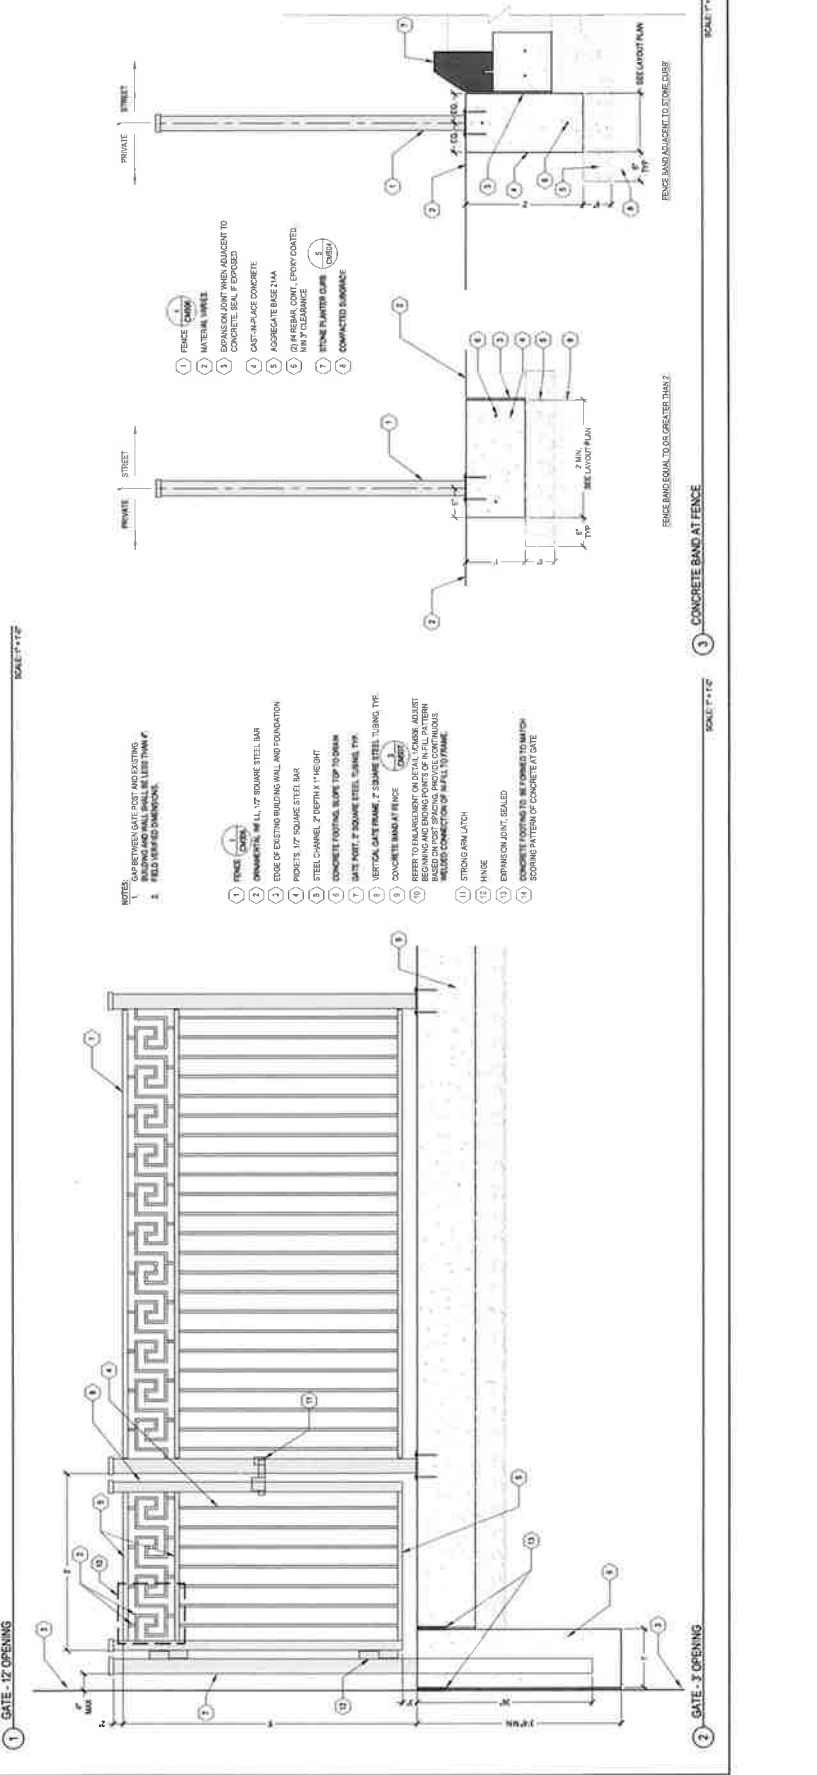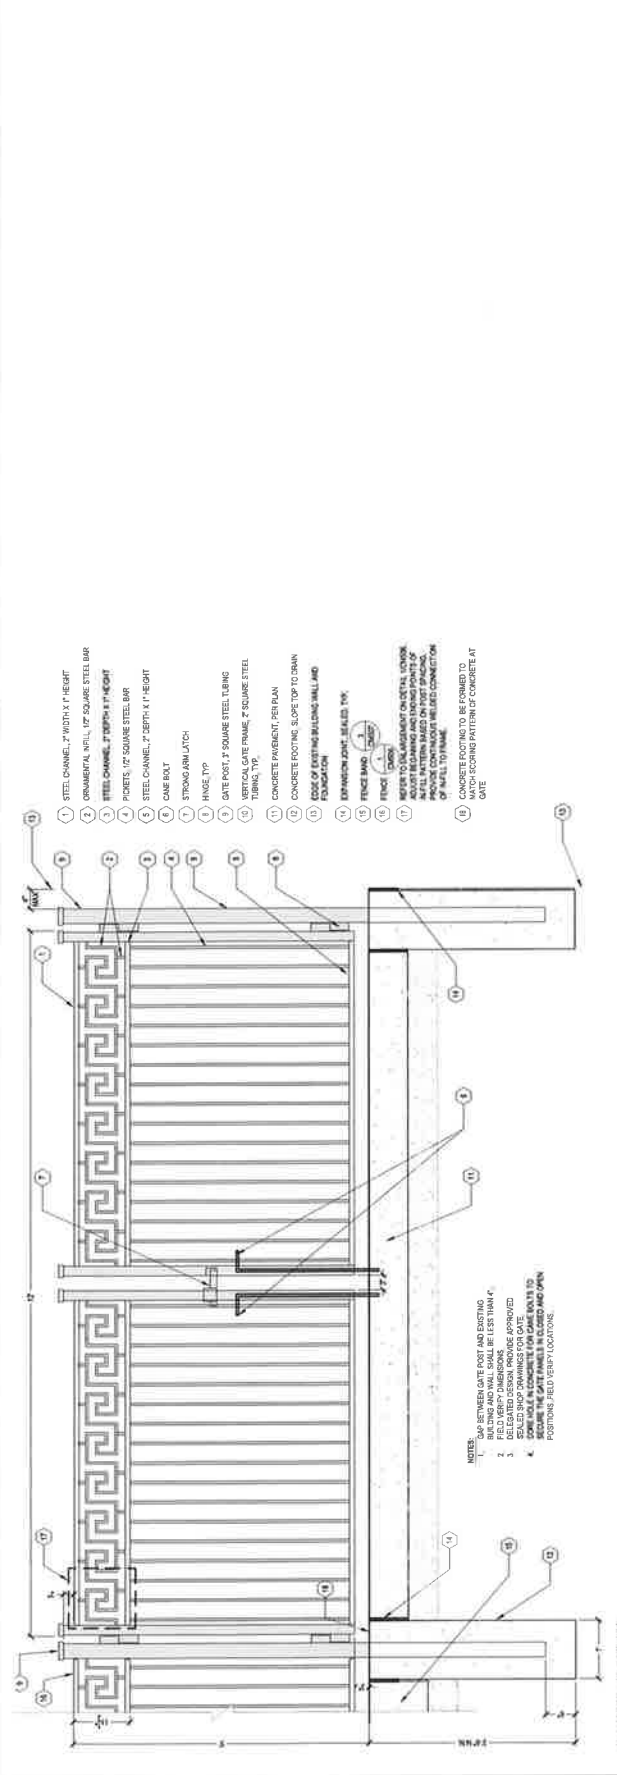

SCALE: AS NOTED
PROJECT NUMBER: 15026 001
DRAWING NUMBER: CM507

SCALE: 1/4" = 1'-0"

SCALE: 1/4" = 1'-0"

MAP-25-19

AREA 6B

MACOMB ST. 50 FT. WD.

BEAUBIEN ST. 60 FT. WD.

ST. ANTOINE ST. 50 FT. WD.

MONROE ST. 50 FT. WD.

LAFAYETTE AVE. 50 FT. WD.

S. I-375 SERVICE DRIVE

- REQUEST ENCROACHMENT (FOR TILE TYPE 1, GUIDE WAY)
- REQUEST ENCROACHMENT (FOR TILE TYPE 2, DETECTABLE WARNING)
- REQUEST ENCROACHMENT (FOR CONCRETE PAVEMENT, MISC. NONREINF. 6 INCH, MODIFIED)
- REQUEST ENCROACHMENT (FOR GRANITE PAVER, PEDESTRIAN)
- REQUEST ENCROACHMENT (FOR CURB AND GUTTER, CONC)
- REQUEST ENCROACHMENT (FOR CONC PAVT, MISC, REINF. 8 INCH)
- REQUEST ENCROACHMENT (FOR CONC PAVT, MISC, REINF, VALLEY GUTTER)
- REQUEST ENCROACHMENT (FOR GRANITE PAVER, VEHICULAR)



(FOR OFFICE USE ONLY)

CARTO 28 A

CITY OF DETROIT CITY ENGINEERING DIVISION MAPS & RECORDS BUREAU	
JOB NO.	25-19
DRWG. NO.	25-19_06B

**REQUEST ENCROACHMENT INTO
MONROE STREET FROM RANDOLPH ST. TO I-75
(GREEKTOWN CORRIDOR)**

DRAWN BY	LC
DATE	12-18-2025
CHECKED	AP/TS
APPROVED	GE

MAP-25-19

MACOMB ST. 50 FT. WD.

PUBLIC ALLEY 20 FT. WD.


RANDOLPH ST. 39.48 FT. WD.

AREA 1A





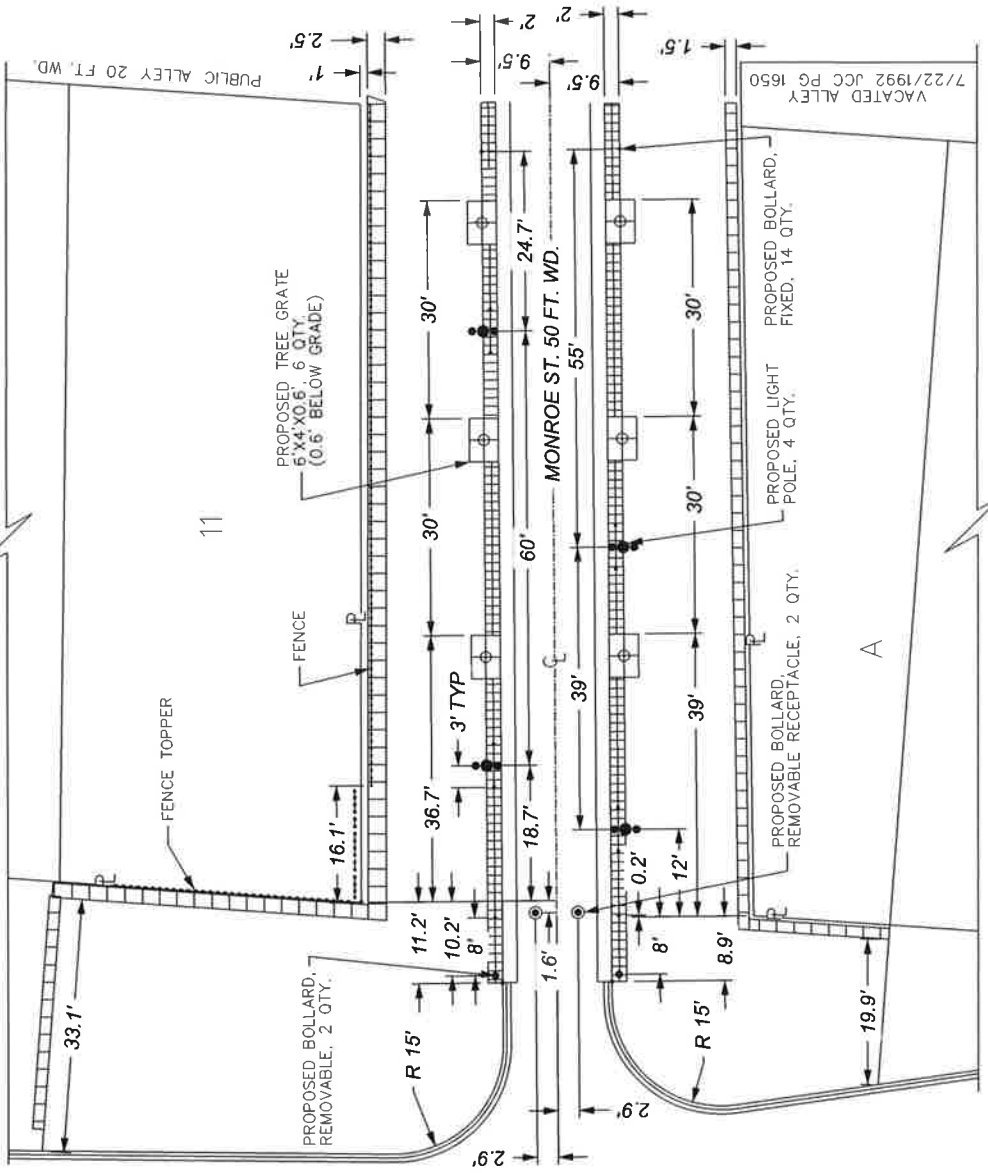


11

MONROE ST. 50 FT. WD.

VACATED ALLEY PG 1650



CARTO 28A

-  - REQUEST ENCROACHMENT (TREE GRATE)
-  - REQUEST ENCROACHMENT (FOR LIGHT POLE)
-  - REQUEST ENCROACHMENT (FOR BOLLARD, REMOVABLE RECEPTACLE)
-  - REQUEST ENCROACHMENT (FOR FENCE)
-  - REQUEST ENCROACHMENT (FOR FENCE TOPPER)
-  - REQUEST ENCROACHMENT (REMOVABLE BOLLARD)
-  - REQUEST ENCROACHMENT (FIXED BOLLARD)

(FOR OFFICE USE ONLY)

CITY OF DETROIT
 CITY ENGINEERING DIVISION
 MAPS & RECORDS BUREAU

JOB NO. 25-19
 DRWG. NO. 25-19_01A

**REQUEST ENCROACHMENT INTO
 MONROE STREET FROM RANDOLPH ST. TO I-75
 (GREEKTOWN CORRIDOR)**

DRAWN BY	LC
DATE	12-18-2025
CHECKED	AP/TS
APPROVED	GE



MAP-25-19

AREA 4A

PUBLIC ALLEY 20 FT. WD.

BEAUBIEN ST. 60 FT. WD.

ST. ANTOINE ST. 50 FT. WD.

MONROE ST. 50 FT. WD.

LAFAYETTE AVE. 50 FT. WD.


(FOR OFFICE USE ONLY)

CARTO 28 A

CITY OF DETROIT
 CITY ENGINEERING DIVISION
 MAPS & RECORDS BUREAU

JOB NO. 25-19
 DRWG. NO. 25-19_04A

**REQUEST ENCROACHMENT INTO
 MONROE STREET FROM RANDOLPH ST. TO I-75
 (GREEKTOWN CORRIDOR)**

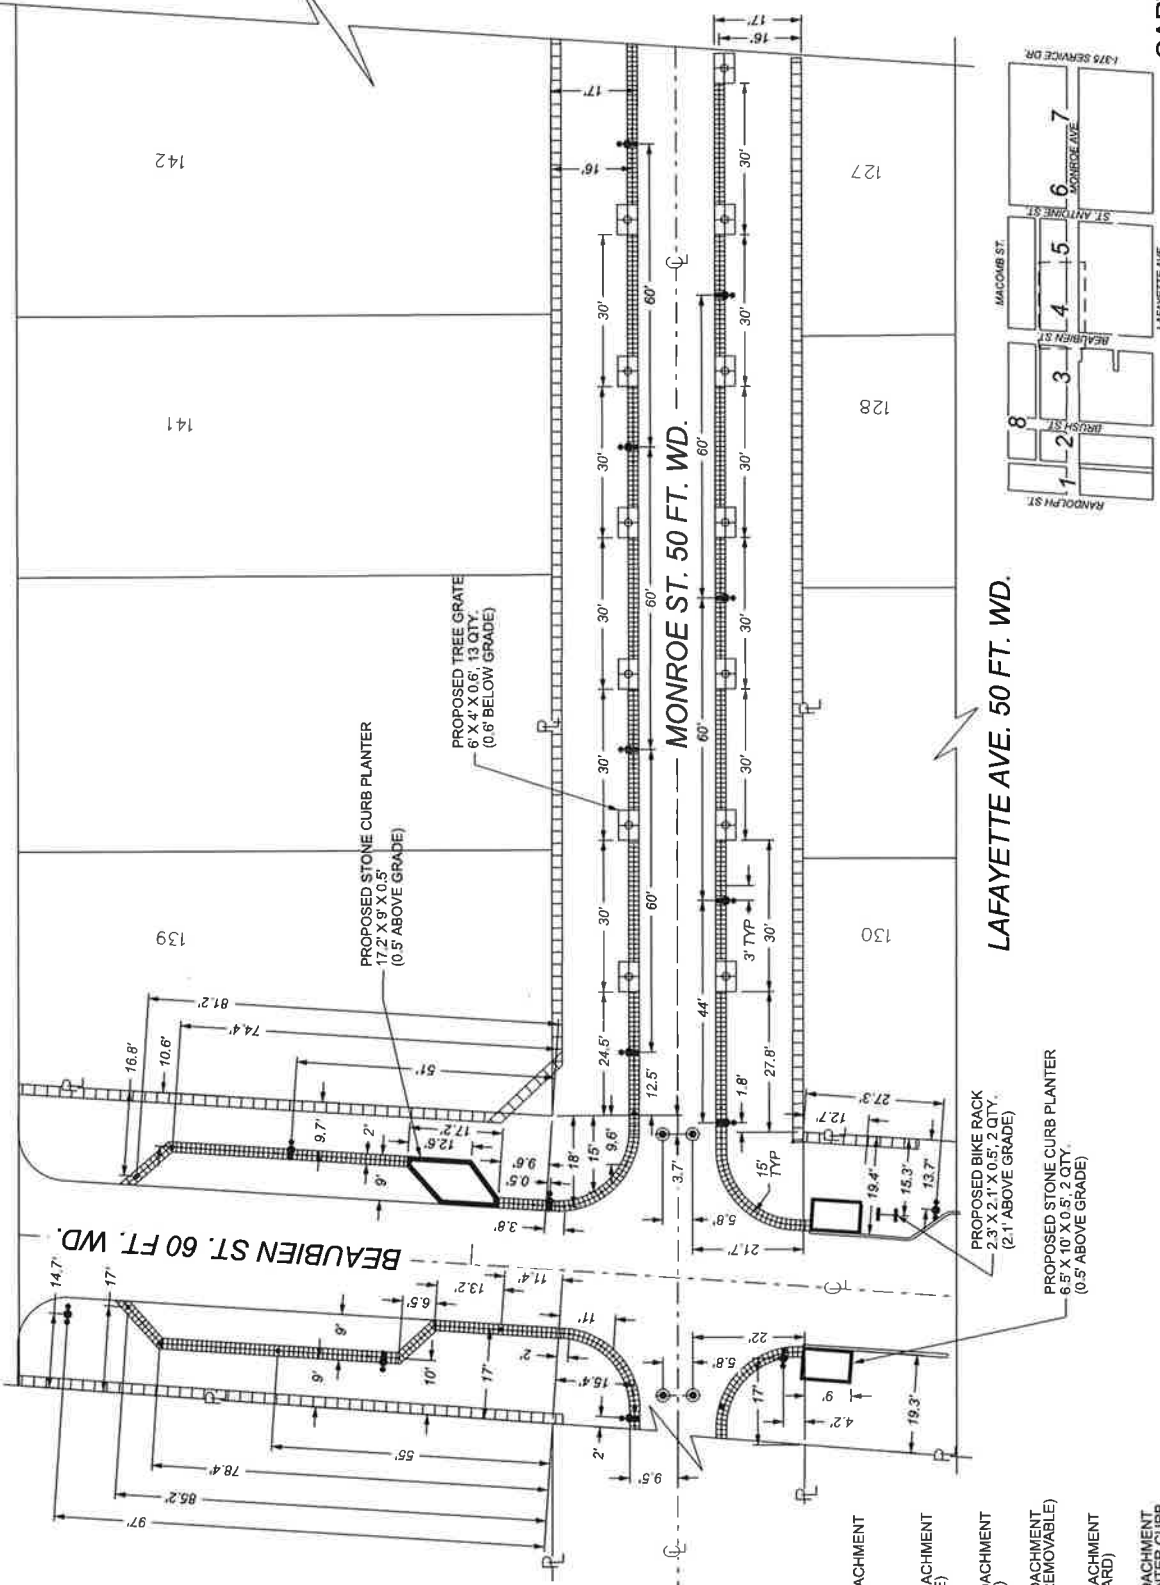

- REQUEST ENCROACHMENT (FOR BIKE RACK)
- REQUEST ENCROACHMENT (FOR TREE GRATE)
- REQUEST ENCROACHMENT (FOR LIGHT POLE)
- REQUEST ENCROACHMENT (FOR BOLLARD, REMOVABLE)
- REQUEST ENCROACHMENT (FOR FIXED BOLLARD)
- REQUEST ENCROACHMENT (FOR STONE PLANTER CURB, SIZES/SHAPES VARY)

PROPOSED BIKE RACK
 2.3' X 2.1' X 0.5', 2 QTY.
 (2.1' ABOVE GRADE)

PROPOSED TREE GRATE
 6' X 4' X 0.6', 13 QTY.
 (0.6' BELOW GRADE)

PROPOSED STONE CURB PLANTER
 17.2' X 9' X 0.5',
 (0.5' ABOVE GRADE)


PROPOSED STONE CURB PLANTER
 6.5' X 10' X 0.5', 2 QTY.
 (0.5' ABOVE GRADE)



DRAWN BY	LC
DATE	12-18-2025
CHECKED	AP/TS
APPROVED	GE

MAP-25-19

MACOMB ST. 50 FT. WD.

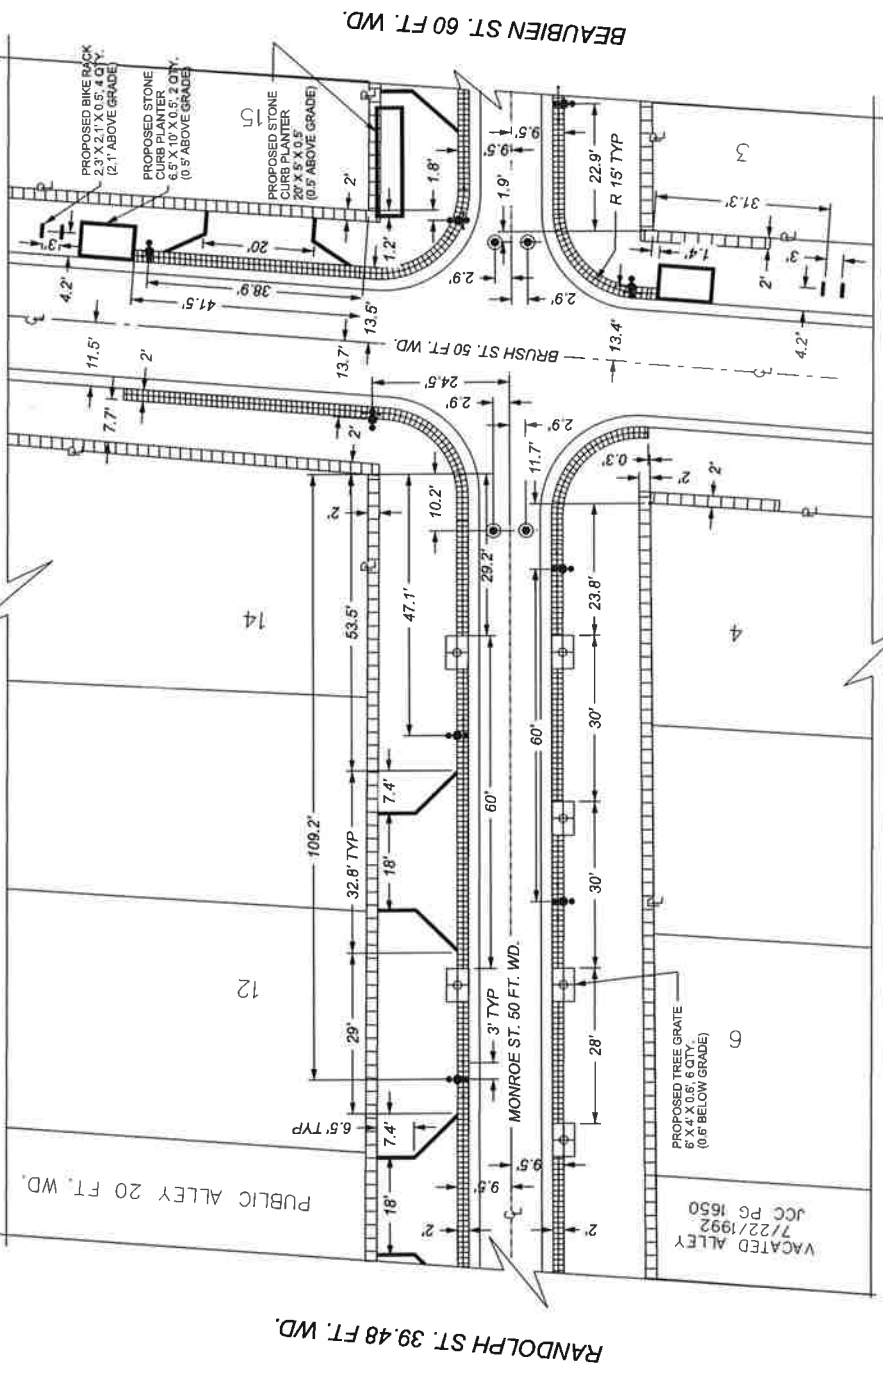

RANDOLPH ST. 39.48 FT. WD.

LAFAYETTE AVE. 50 FT. WD.

AREA 2A

- REQUEST ENCROACHMENT (FOR BIKE RACK)
- REQUEST ENCROACHMENT (FOR TREE GRATE)
- REQUEST ENCROACHMENT (FOR LIGHT POLE)
- REQUEST ENCROACHMENT (FOR BOLLARD, REMOVABLE RECEPTACLE)
- REQUEST ENCROACHMENT (FOR FIXED BOLLARD)
- REQUEST ENCROACHMENT (FOR STONE PLANTER CURB, SIZES/SHAPES VARY)



(FOR OFFICE USE ONLY)

CARTO 28 A

DRAWN BY	LC
DATE	12-18-2025
CHECKED	AP/TS
APPROVED	GE

REQUEST ENCROACHMENT INTO
MONROE STREET FROM RANDOLPH ST. TO I-75
(GREEKTOWN CORRIDOR)

CITY OF DETROIT CITY ENGINEERING DIVISION MAPS & RECORDS BUREAU	
JOB NO.	25-19
DRWG. NO.	25-19_02A



MAP-25-19

AREA 5A


MACOMB ST. 50 FT. WD.





ST. ANTOINE ST. 50 FT. WD.


BEAUBIEN ST. 60 FT. WD.

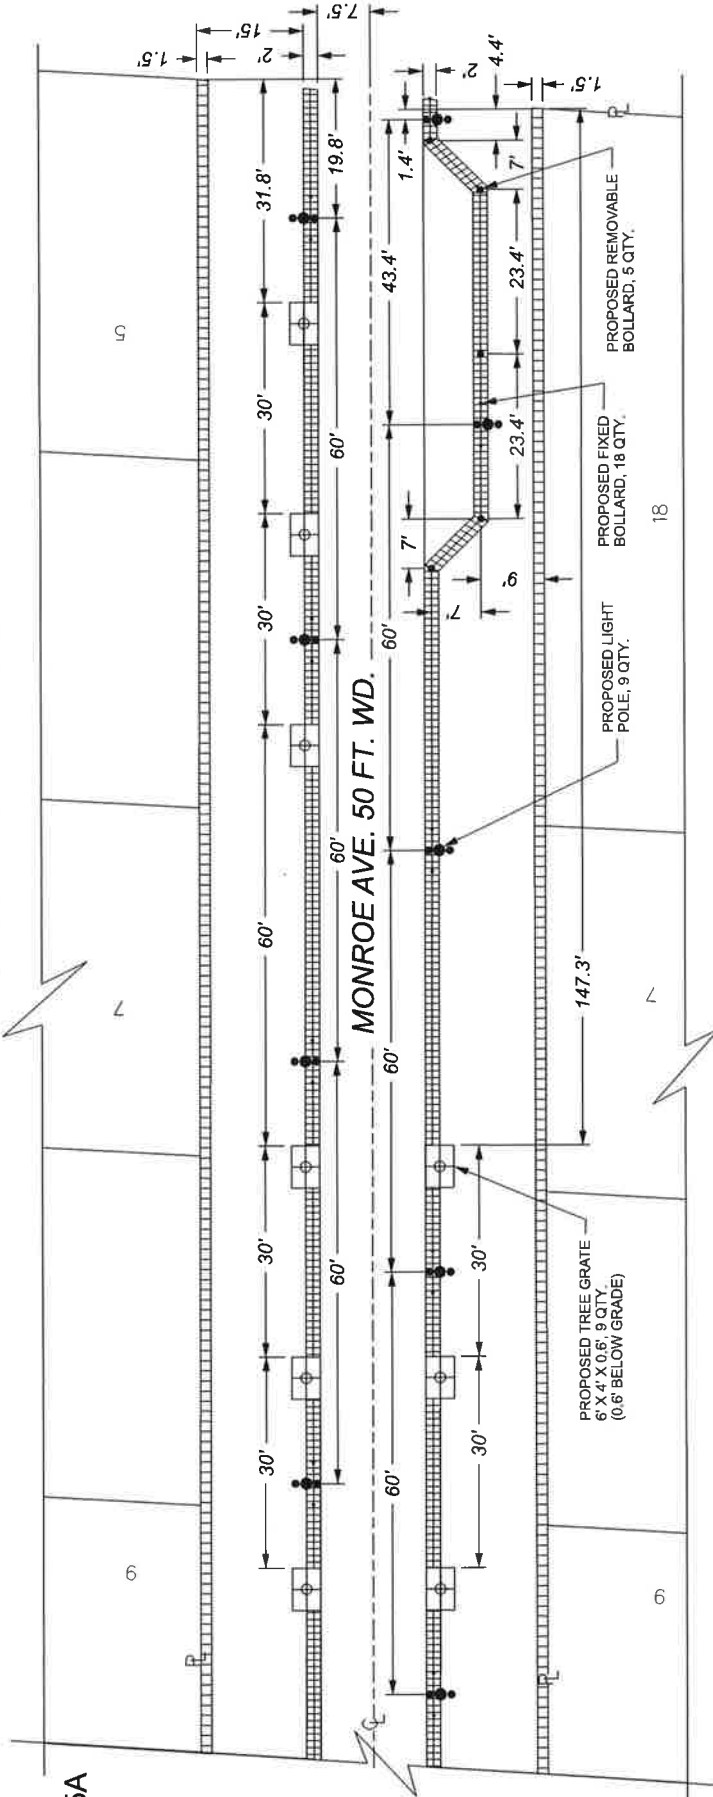MONROE AVE. 50 FT. WD.

LAFAYETTE AVE. 50 FT. WD.



-  - REQUEST ENCROACHMENT (FOR TREE GRATE)
-  - REQUEST ENCROACHMENT (FOR LIGHT POLE)
-  - REQUEST ENCROACHMENT (FOR BOLLARD, REMOVABLE)
-  - REQUEST ENCROACHMENT (FOR FIXED BOLLARD)

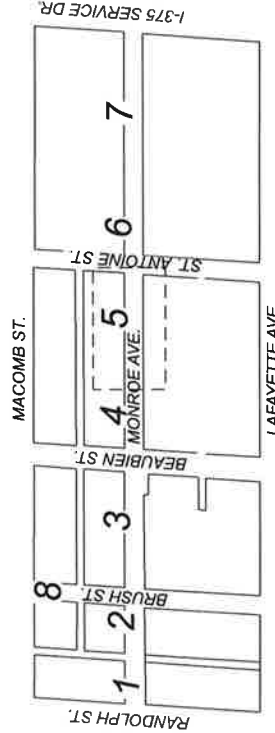

(FOR OFFICE USE ONLY)

CARTO 28 A

<p>REQUEST ENCROACHMENT INTO MONROE STREET FROM RANDOLPH ST. TO I-75 (GREEKTOWN CORRIDOR)</p>		<p>CITY OF DETROIT CITY ENGINEERING DIVISION MAPS & RECORDS BUREAU</p>	
<p>DRAWN BY LC</p>	<p>DATE 12-18-2025</p>	<p>JOB NO. 25-19</p>	<p>DRWG. NO. 25-19_05A</p>
<p>CHECKED AP/TS</p>	<p>APPROVED GE</p>		

MAP-25-19

AREA 5B

BAUBIEN ST. 60 FT. WD.

MACOMB ST. 50 FT. WD.

MONROE AVE. 50 FT. WD.

LAFAYETTE AVE. 50 FT. WD.

ST. ANTOINE ST. 50 FT. WD.

-  - REQUEST ENCROACHMENT (FOR TILE TYPE 1, GUIDE WAY)
-  - REQUEST ENCROACHMENT (FOR TILE TYPE 2, DETECTABLE WARNING)
-  - REQUEST ENCROACHMENT (FOR GRANITE PAVEMENT, PEDESTRIAN)
-  - REQUEST ENCROACHMENT (FOR GRANITE PAVEMENT, VEHICULAR)



(FOR OFFICE USE ONLY)

CARTO 28 A

DRAWN BY	LC
DATE	12-18-2025
CHECKED	AP/TS
APPROVED	GE

**REQUEST ENCROACHMENT INTO
MONROE STREET FROM RANDOLPH ST. TO I-75
(GREEKTOWN CORRIDOR)**

CITY OF DETROIT
CITY ENGINEERING DIVISION
MAPS & RECORDS BUREAU

JOB NO. 25-19

DRWG. NO. 25-19_05B



MAP-25-19

MACOMB ST. 50 FT. WD.

PROPOSED BIKE RACK
2.3' X 2.1' X 0.5', 4 QTY.
(2.1' ABOVE GRADE)

PROPOSED STONE PLANTER CURB
8' X 10' X 0.5', 2 QTY.
(0' TO 0.5' ABOVE GRADE)

BEAUBIEN ST. 60 FT. WD.


AREA 6A

MONROE ST. 50 FT. WD.

S. I-375 SERVICE DRIVE

LAFAYETTE AVE. 50 FT. WD.

- REQUEST ENCROACHMENT (FOR BIKE RACK)
- ⊕ REQUEST ENCROACHMENT (FOR TREE GRATE)
- REQUEST ENCROACHMENT (FOR LIGHT POLE)
- REQUEST ENCROACHMENT (FOR BOLLARD, REMOVABLE)
- REQUEST ENCROACHMENT (FOR FIXED BOLLARD)
- REQUEST ENCROACHMENT (FOR STONE PLANTER CURB, SIZES/SHAPES VARY)

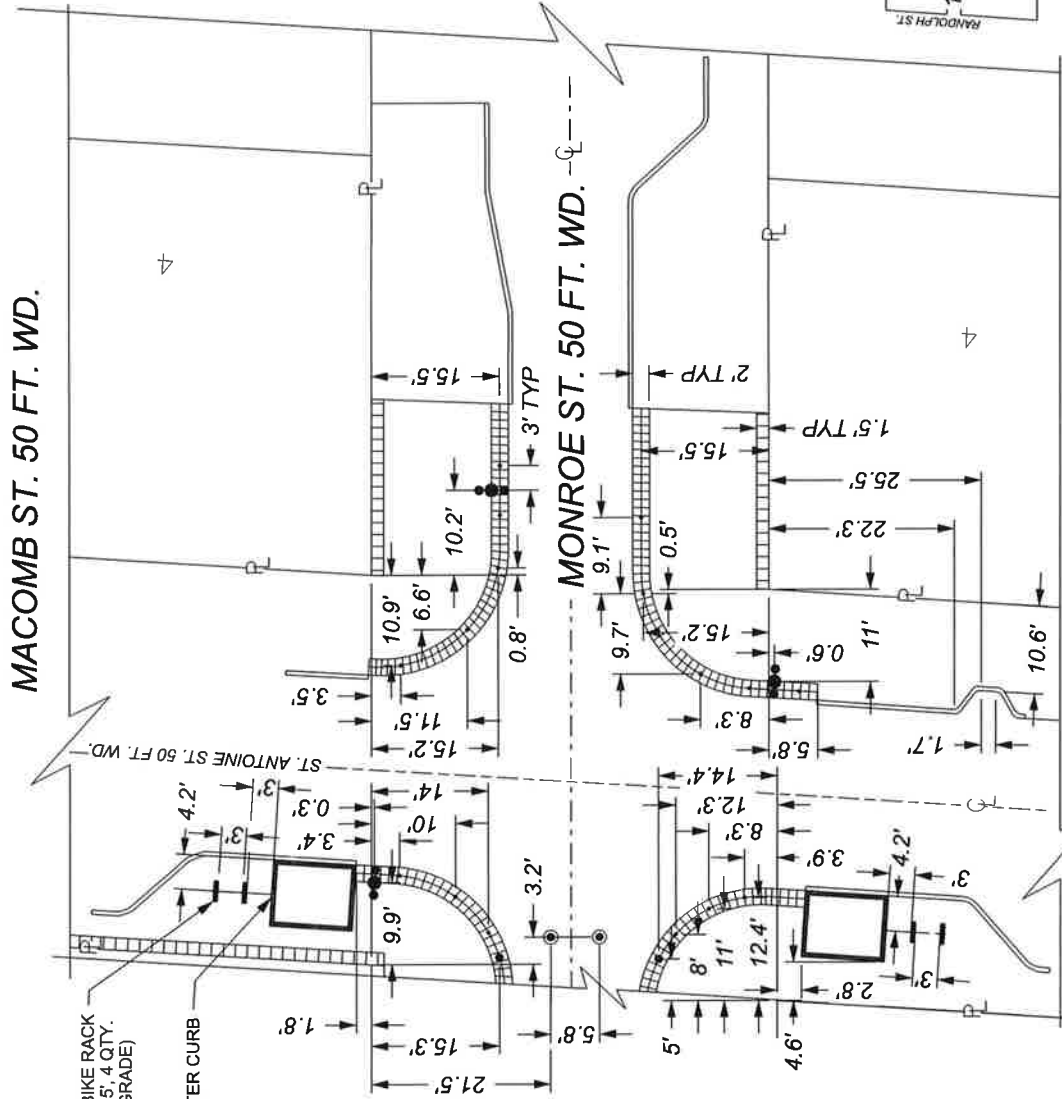

(FOR OFFICE USE ONLY)

CARTO 28 A

DRAWN BY	LC
DATE	12-18-2025
CHECKED	AP/TS
APPROVED	GE

REQUEST ENCROACHMENT INTO MONROE STREET FROM RANDOLPH ST. TO I-75 (GREEKTOWN CORRIDOR)

CITY OF DETROIT
CITY ENGINEERING DIVISION
MAPS & RECORDS BUREAU

JOB NO. 25-19
DRWG. NO. 25-19_06A

MAP-25-19

AREA 2B

- REQUEST ENCROACHMENT
(FOR CONCRETE PAVEMENT
MISC. NONREINF. 6 INCH, MODIFIED)
- REQUEST ENCROACHMENT
(FOR GRANITE PAVEMENT, PEDESTRIAN)
- REQUEST ENCROACHMENT
(FOR CURB AND GUTTER, CONC)
- REQUEST ENCROACHMENT
(FOR CONC PAVT, MISC, REINF. 8 INCH)
- REQUEST ENCROACHMENT
(FOR CONC PAVT, MISC, REINF, VALLEY GUTTER)
- REQUEST ENCROACHMENT
(FOR GRANITE PAVEMENT, VEHICULAR)
- REQUEST ENCROACHMENT
(FOR TILE TYPE 1, GUIDE WAY)
- REQUEST ENCROACHMENT
(FOR TILE TYPE 2, DETECTABLE WARNING)

MACOMB ST. 50 FT. WD.

PUBLIC ALLEY 20 FT. WD.

RANDOLPH ST. 39.48 FT. WD.

12

14

15

BEAUBIEN ST. 60 FT. WD.

BRUSH ST. 50 FT. WD.

MONROE ST. 50 FT. WD.


VACATED ALLEY
7/22/1992
JCC PG 1650

2

4

5

LAFAYETTE AVE. 50 FT. WD.

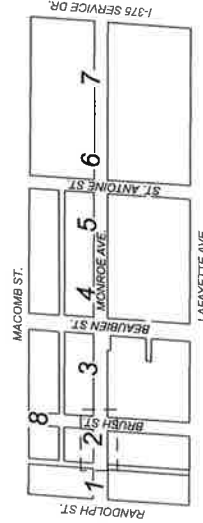

(FOR OFFICE USE ONLY)

CARTO 28 A

DRAWN BY LC

DATE 12-18-2025

CHECKED AP/TS

APPROVED GE

REQUEST ENCROACHMENT INTO
MONROE STREET FROM RANDOLPH ST. TO I-75
(GREEKTOWN CORRIDOR)

CITY OF DETROIT
CITY ENGINEERING DIVISION
MAPS & RECORDS BUREAU

JOB NO. 25-19


DRWG. NO. 25-19_02B

MAP-25-19




MACOMB ST. 50 FT. WD.

AREA 3B

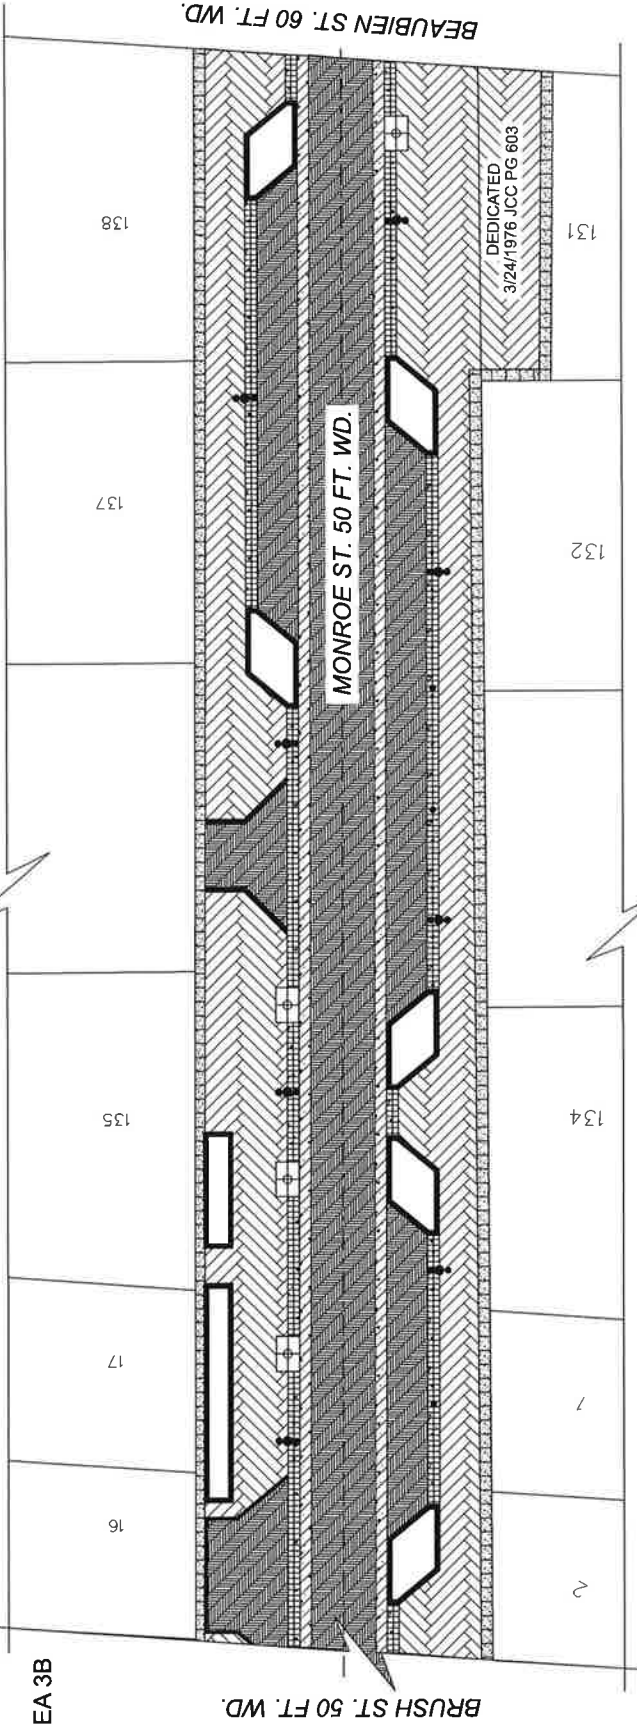

LAFAYETTE AVE. 50 FT. WD.

- REQUEST ENCROACHMENT (FOR CONCRETE PAVEMENT, MISC. NONREINF. 6 INCH, MODIFIED)
- REQUEST ENCROACHMENT (FOR GRANITE PAVER, PEDESTRIAN)
- REQUEST ENCROACHMENT (FOR TILE TYPE 1, GUIDE WAY)
- REQUEST ENCROACHMENT (FOR TILE TYPE 2, DETECTABLE WARNING)
- REQUEST ENCROACHMENT (FOR CONC PAVT., MISC. REINF., VALLEY GUTTER)
- REQUEST ENCROACHMENT (FOR GRANITE PAVER, VEHICULAR)

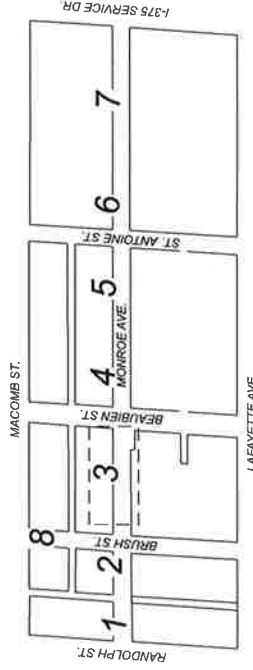

(FOR OFFICE USE ONLY)

CARTO 28 A

DRAWN BY LC

DATE 12-18-2025

CHECKED APTS

APPROVED GE

REQUEST ENCROACHMENT INTO
MONROE STREET FROM RANDOLPH ST. TO I-75
(GREEKTOWN CORRIDOR)

CITY OF DETROIT
CITY ENGINEERING DIVISION
MAPS & RECORDS BUREAU

JOB NO. 25-19


DRWG. NO. 25-19_03B



MAP-25-19

AREA 4B

PUBLIC ALLEY 20 FT. WD.

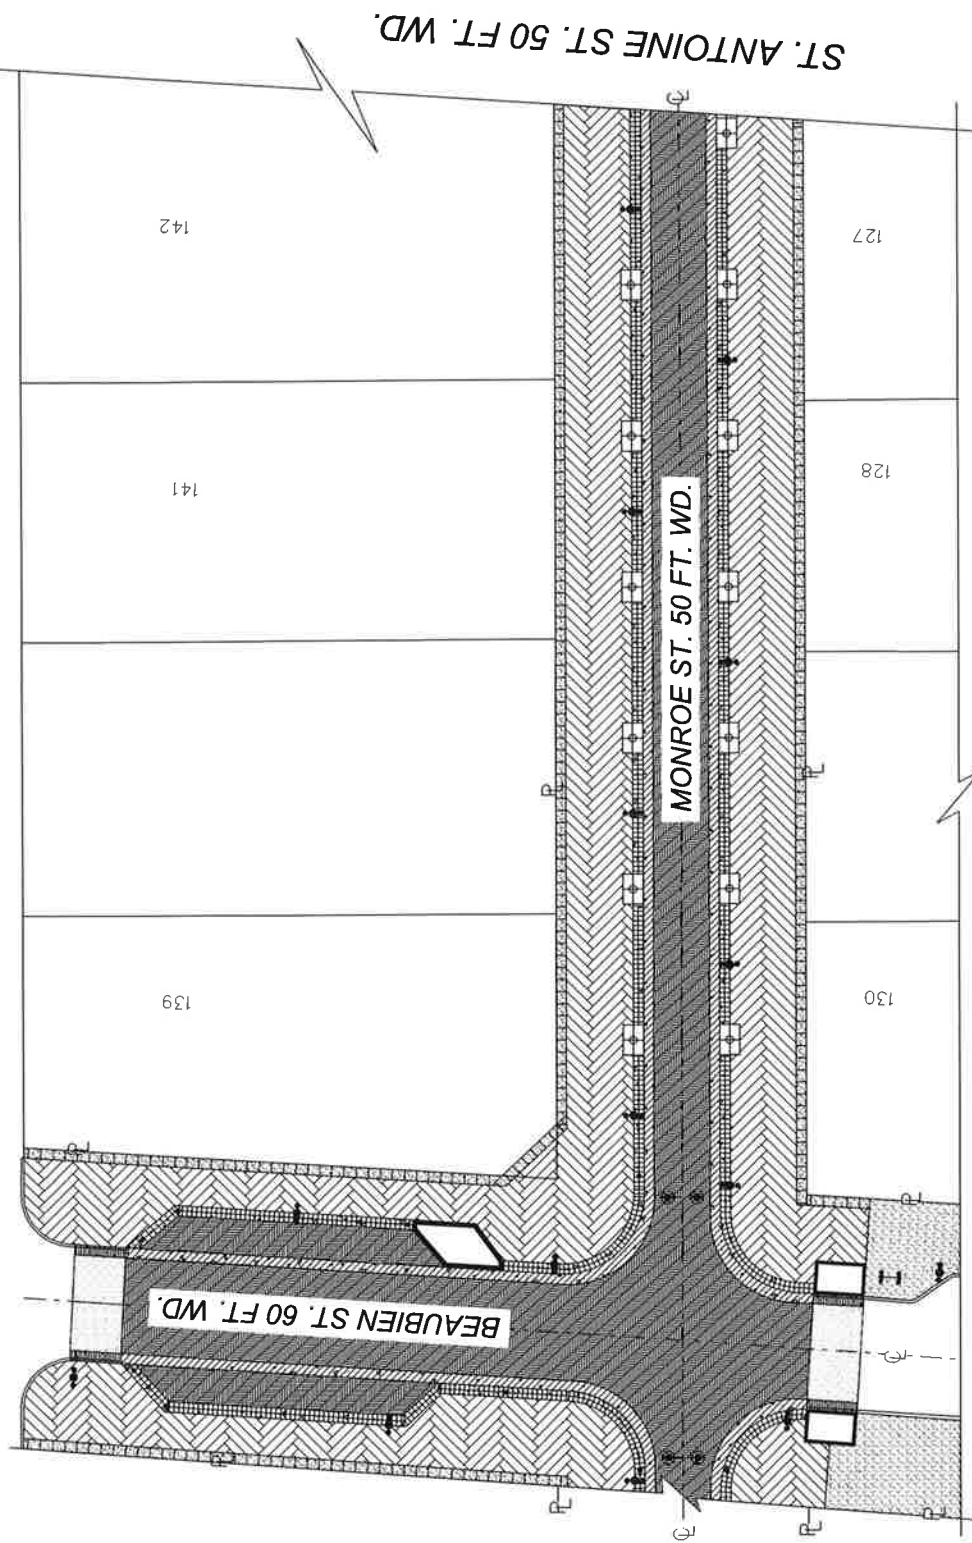

(FOR OFFICE USE ONLY)

CARTO 28 A

- REQUEST ENCROACHMENT (FOR CONCRETE PAVEMENT MISC. NONREINF. 6 INCH, MODIFIED)
- REQUEST ENCROACHMENT (FOR GRANITE PAVER, PEDESTRIAN)
- REQUEST ENCROACHMENT (FOR CURB AND GUTTER, CONC)
- REQUEST ENCROACHMENT (FOR CONC PAVT, MISC. REINF. 8 INCH)
- REQUEST ENCROACHMENT (FOR TILE TYPE 1, GUIDE WAY)
- REQUEST ENCROACHMENT (FOR TILE TYPE 2, DETECTABLE WARNING)
- REQUEST ENCROACHMENT (FOR CONC PAVT, MISC. REINF. VALLEY GUTTER)
- REQUEST ENCROACHMENT (FOR GRANITE PAVER, VEHICULAR)

CITY OF DETROIT
 CITY ENGINEERING DIVISION
 MAPS & RECORDS BUREAU

JOB NO. 25-19
 DRWG. NO. 25-19_04B

**REQUEST ENCROACHMENT INTO
 MONROE STREET FROM RANDOLPH ST. TO I-75
 (GREEKTOWN CORRIDOR)**

DRAWN BY	LC
DATE	12-18-2025
CHECKED	AP/TS
APPROVED	GE

