

(NOT TO SCALE)

PARKING NO MARKED PARKING ON SITE.

BENCHMARK

ARROW ON FIRE HYDRANT AT SE CORNER OF GILBERT AND CLAYTON. ELEVATION = 595.83' (NAVD 88)

PARCEL AREA

 $6,300\pm$ SQUARE FEET = $0.14\pm$ ACRES LOTS 229-231:

 $13,230\pm$ SQUARE FEET = $0.30\pm$ ACRES TOTAL: 19,530± SQUARE FEET = 0.44± ACRES

BASIS OF BEARING


NORTH 28'00'00" WEST, BEING THE SOUTHWESTERLY RIGHT OF WAY LINE OF LIVERNOIS AVENUE, AS PLATTED.

SURVEYOR'S NOTE


THE UNDERGROUND UTILITIES SHOWN HAVE BEEN LOCATED FROM FIELD SURVEY INFORMATION AND EXISTING DRAWINGS. THE SURVEYOR MAKES NO GUARANTEES THAT THE UNDERGROUND UTILITIES SHOWN COMPRISE ALL SUCH UTILITIES IN THE AREA, EITHER IN SERVICE OR ABANDONED.
THE SURVEYOR FURTHER DOES NOT WARRANT THAT THE UNDERGROUND UTILITIES SHOWN ARE IN THE EXACT LOCATION INDICATED ALTHOUGH HE DOES CERTIFY THAT THEY ARE LOCATED AS ACCURATELY AS POSSIBLE FROM INFORMATION AVAILABLE. THE SURVEYOR HAS NOT PHYSICALLY LOCATED THE UNDERGROUND UTILITIES OTHER THAN THE STRUCTURE INVENTORY SHOWN HEREON.

LEGEND	
•	SET 1/2" REBAR WITH CAP P.S. 47976
×	SET X-CUT
•	FOUND MONUMENT (AS NOTED)
(R&M)	RECORD AND MEASURED DIMENSION
(R)	RECORD DIMENSION
(M)	MEASURED DIMENSION
⊠	ELECTRIC METER
Ш	ELECTRIC PANEL
0	UTILITY POLE
	GAS METER
←	LIGHT POLE WITH STREET LAMP
©	COMBINATION SANITARY/STORM MANHOLE
Ħ	SQUARE CATCH BASIN
	FIRE HYDRANT
₩ M AC	WATER VALVE
AC	AIR CONDITIONING UNIT
- o -	SINGLE POST SIGN
	 PARCEL BOUNDARY LINE
	- PLATTED LOT LINE
	- BUILDING
	CONCRETE CURB
	- EDGE OF CONCRETE (CONC.)
	— EDGE OF ASPHALT (ASPH.)
X	FENCE (AS NOTED)
<u> </u>	OVERHEAD UTILITY LINE
	BUILDING AREA

ASPHALT

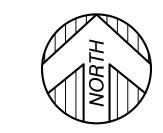


GRAPHIC SCALE

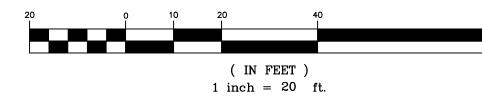

PROPERTY DESCRIPTION

LAND SITUATED IN THE CITY OF DETROIT, COUNTY OF WAYNE, STATE OF MICHIGAN, DESCRIBED AS:

LOTS 199, 229, 230, AND 231, CICOTT, GILBERT AND BARKUM'S SUBDIVISION, ACCORDING TO THE PLAT RECORDED IN LIBER 3, PAGE 19, WAYNE COUNTY RECORDS.

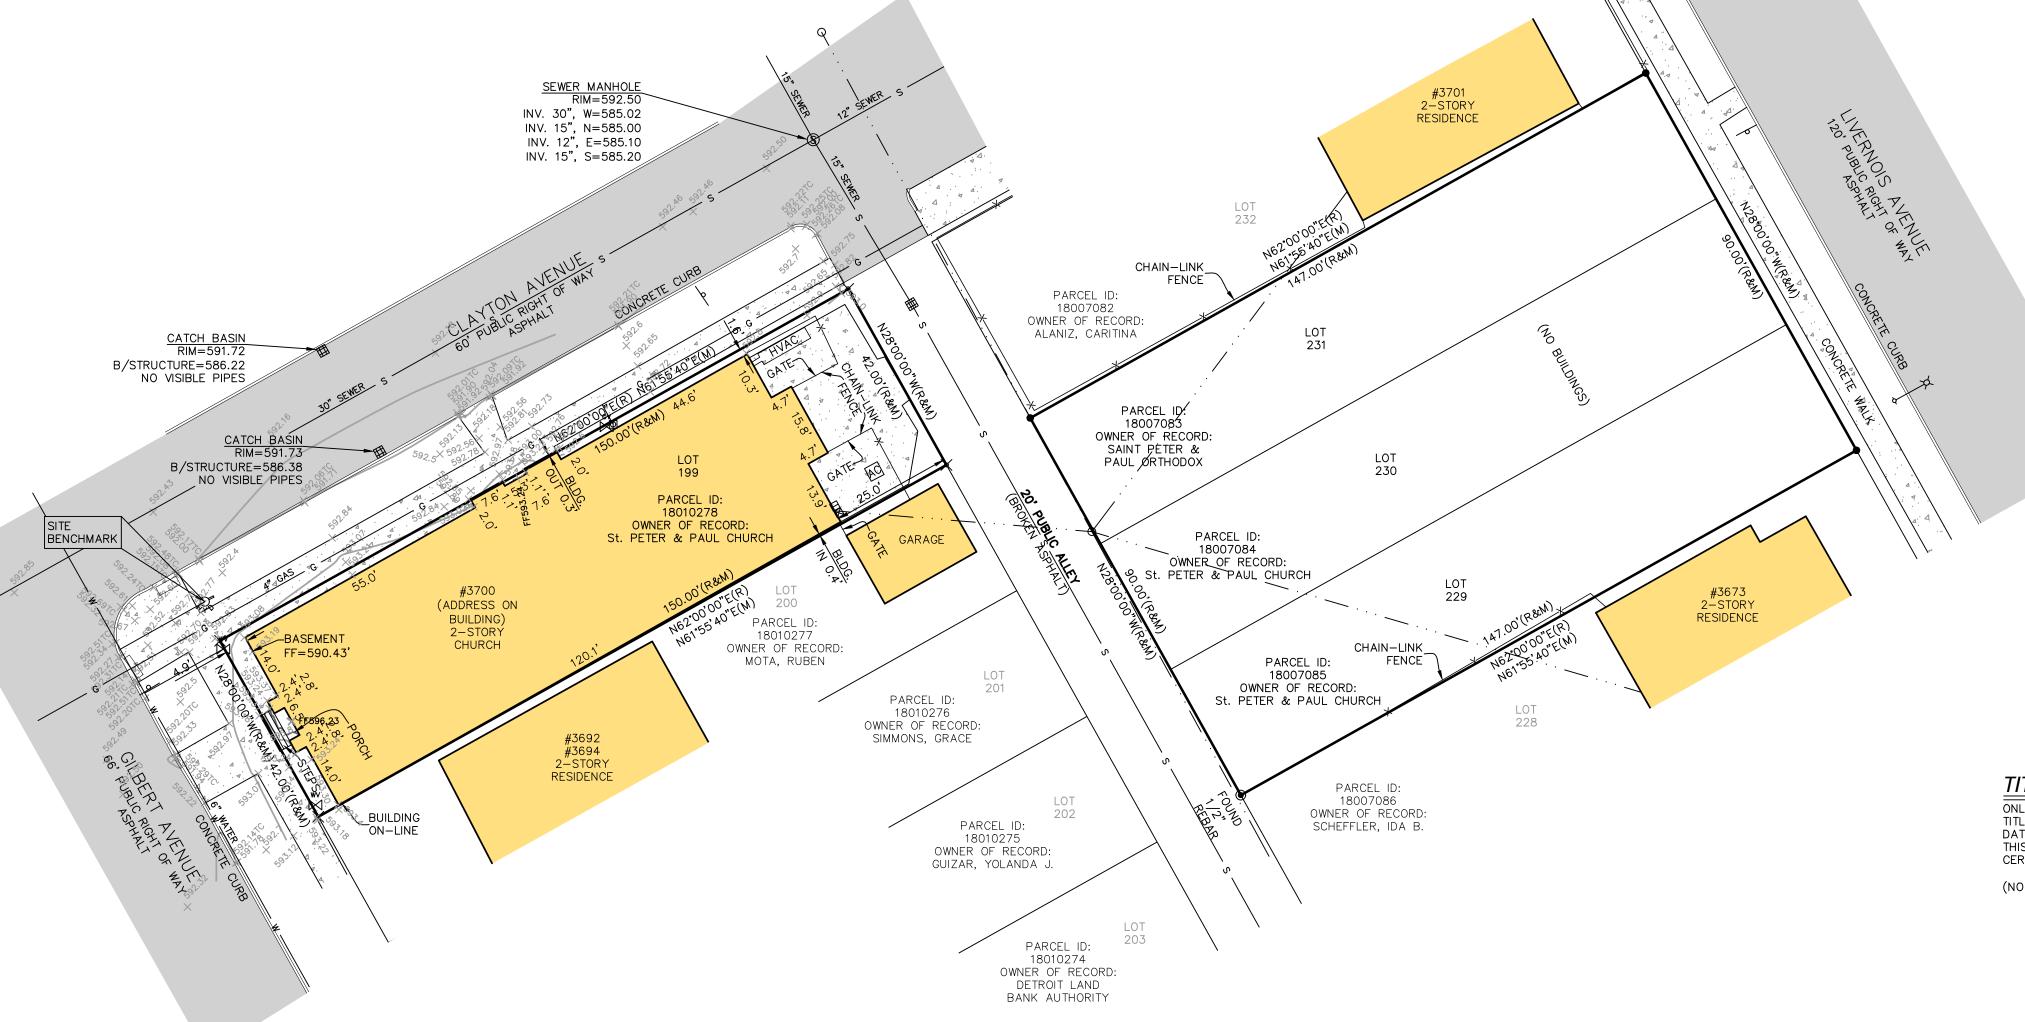

TITLE REPORT NOTE

ONLY THOSE EXCEPTIONS CONTAINED WITHIN THE OLD REPUBLIC NATIONAL TITLE INSURANCE COMPANY FILE No. 82-19679834-SCM, REVISION 2, DATED DECEMBER 20, 2019, AND RELISTED BELOW WERE CONSIDERED FOR THIS SURVEY. NO OTHER RECORDS RESEARCH WAS PERFORMED BY THE CERTIFYING SURVEYOR.

(NO SPECIFIC EASEMENTS LISTED)

SURVEYOR'S CERTIFICATION

TO VERA & JOSEPH DRESNER FOUNDATION, INC., A MICHIGAN NON-PROFIT CORPORATION, ON BEHALF OF AN ENTITY TO BE FORMED; OLD REPUBLIC NATIONAL TITLE INSURANCE COMPANY; AND ATA NATIONAL TITLE GROUP, LLC:

THIS IS TO CERTIFY THAT THIS MAP OR PLAT AND THE SURVEY ON WHICH IT IS BASED WERE MADE IN ACCORDANCE WITH THE 2016 MINIMUM STANDARD DETAIL REQUIREMENTS FOR ALTA/NSPS LAND TITLE SURVEYS, JOINTLY ESTABLISHED AND ADOPTED BY ALTA AND NSPS, AND INCLUDED ITEMS 2, 4, 7A, 8, AND 9 OF TABLE A, THEREOF. THE FIELD WORK WAS COMPLETED ON 01/06/2020.


DATE OF PLAT OR MAP: 01/07/2020



ANTHONY T. SYCKO, JR., P.S. PROFESSIONAL SURVEYOR MICHIGAN LICENSE NO. 47976 22556 GRATIOT AVE., EASTPOINTE, MI 48021 TSycko@kemtec-survey.com



1 OF 1 SHEETS

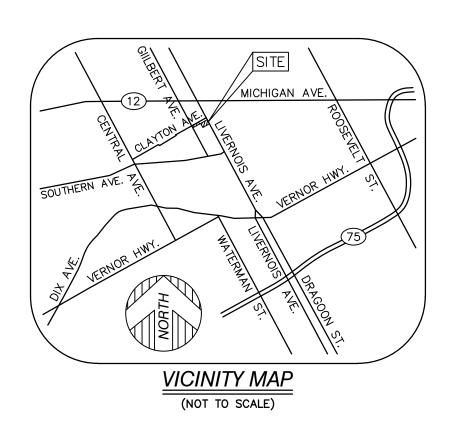

PARKING

NO MARKED PARKING ON SITE.

BENCHMARK

ARROW ON FIRE HYDRANT AT SE CORNER OF GILBERT AND CLAYTON. ELEVATION = 595.83' (NAVD 88)

PARCEL AREA

 $6,300\pm$ SQUARE FEET = $0.14\pm$ ACRES LOTS 229-231: $13,230\pm$ SQUARE FEET = $0.30\pm$ ACRES 19,530± SQUARE FEET = 0.44± ACRES

BASIS OF BEARING


NORTH 28'00'00" WEST, BEING THE SOUTHWESTERLY RIGHT OF WAY LINE OF LIVERNOIS AVENUE, AS PLATTED.

SURVEYOR'S NOTE


THE UNDERGROUND UTILITIES SHOWN HAVE BEEN LOCATED FROM FIELD SURVEY INFORMATION AND EXISTING DRAWINGS. THE SURVEYOR MAKES NO GUARANTEES THAT THE UNDERGROUND UTILITIES SHOWN COMPRISE ALL SUCH UTILITIES IN THE AREA, EITHER IN SERVICE OR ABANDONED. THE SURVEYOR FURTHER DOES NOT WARRANT THAT THE UNDERGROUND UTILITIES SHOWN ARE IN THE EXACT LOCATION INDICATED ALTHOUGH HE DOES CERTIFY THAT THEY ARE LOCATED AS ACCURATELY AS POSSIBLE FROM INFORMATION AVAILABLE. THE SURVEYOR HAS NOT PHYSICALLY LOCATED THE UNDERGROUND UTILITIES OTHER THAN THE STRUCTURE INVENTORY SHOWN HEREON.

LEGEND

LEGEND	
•	SET 1/2" REBAR WITH CAP P.S. 47976
×	SET X-CUT
•	FOUND MONUMENT (AS NOTED)
(R&M)	RECORD AND MEASURED DIMENSION
(R)	RECORD DIMENSION
(M)	MEASURED DIMENSION
	ELECTRIC METER
Ш	ELECTRIC PANEL
0	UTILITY POLE
O	GAS METER
\ _	LIGHT POLE WITH STREET LAMP
©	COMBINATION SANITARY/STORM MANHOLE
III	SQUARE CATCH BASIN
	FIRE HYDRANT
$\ddot{\bowtie}$	WATER VALVE
AC	AIR CONDITIONING UNIT
- o -	SINGLE POST SIGN
	PARCEL BOUNDARY LINE
	PLATTED LOT LINE
	BUILDING
	CONCRETE CURB
	EDGE OF CONCRETE (CONC.)
	EDGE OF ASPHALT (ASPH.)
×	FENCE (AS NOTED)
	OVERHEAD UTILITY LINE
	BUILDING AREA
	ASPHALT
A	CONCRETE

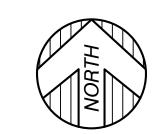


GRAPHIC SCALE

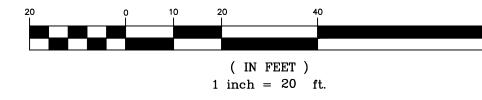

PROPERTY DESCRIPTION

LAND SITUATED IN THE CITY OF DETROIT, COUNTY OF WAYNE, STATE OF MICHIGAN, DESCRIBED AS:

LOTS 199, 229, 230, AND 231, CICOTT, GILBERT AND BARKUM'S SUBDIVISION, ACCORDING TO THE PLAT RECORDED IN LIBER 3, PAGE 19, WAYNE COUNTY RECORDS.

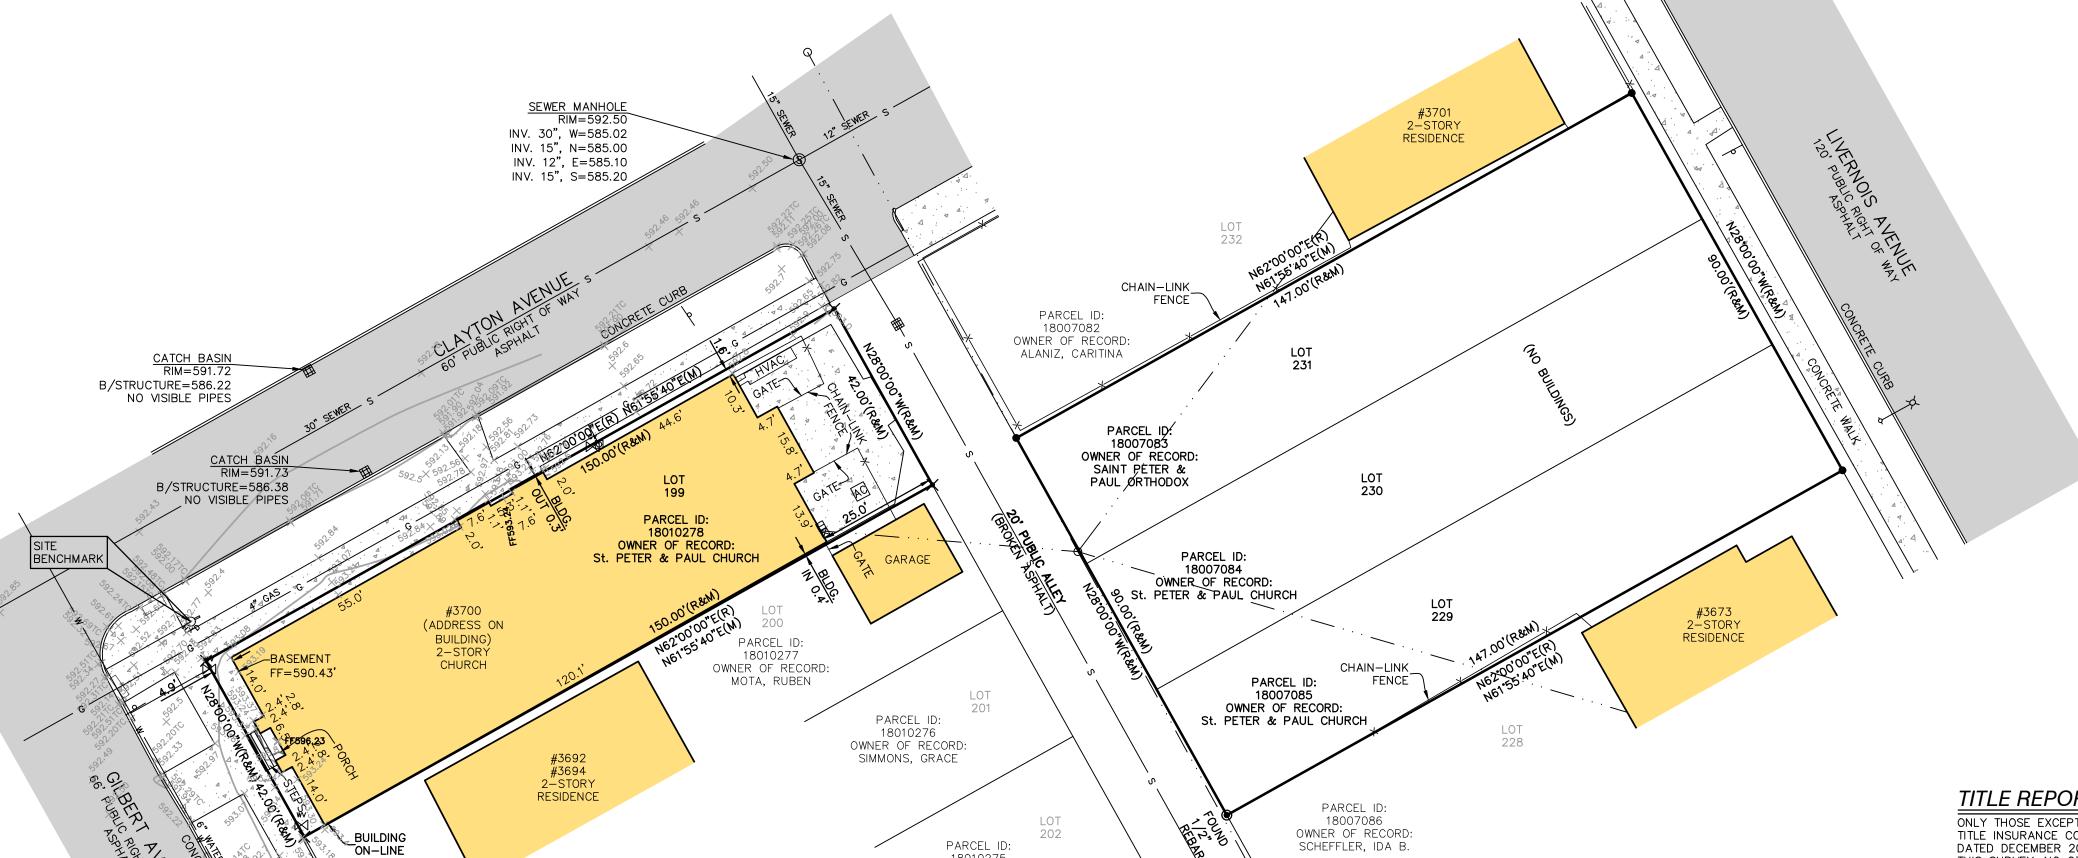

OWNER OF RECORD:

GUIZAR, YOLANDA J.

PARCEL ID: 18010274 OWNER OF RECORD: DETROIT LAND BANK AUTHORITY

TITLE REPORT NOTE

ONLY THOSE EXCEPTIONS CONTAINED WITHIN THE OLD REPUBLIC NATIONAL TITLE INSURANCE COMPANY FILE No. 82-19679834-SCM, REVISION 2, DATED DECEMBER 20, 2019, AND RELISTED BELOW WERE CONSIDERED FOR THIS SURVEY. NO OTHER RECORDS RESEARCH WAS PERFORMED BY THE CERTIFYING SURVEYOR.

(NO SPECIFIC EASEMENTS LISTED)

SURVEYOR'S CERTIFICATION


TO VERA & JOSEPH DRESNER FOUNDATION, INC., A MICHIGAN NON-PROFIT CORPORATION, ON BEHALF OF AN ENTITY TO BE FORMED; OLD REPUBLIC NATIONAL TITLE INSURANCE COMPANY; AND ATA NATIONAL TITLE GROUP, LLC:

THIS IS TO CERTIFY THAT THIS MAP OR PLAT AND THE SURVEY ON WHICH IT IS BASED WERE MADE IN ACCORDANCE WITH THE 2016 MINIMUM STANDARD DETAIL REQUIREMENTS FOR ALTA/NSPS LAND TITLE SURVEYS, JOINTLY ESTABLISHED AND ADOPTED BY ALTA AND NSPS, AND INCLUDED ITEMS 2, 4, 7A, 8, AND 9 OF TABLE A, THEREOF. THE FIELD WORK WAS COMPLETED ON 01/06/2020.

DATE OF PLAT OR MAP: 01/07/2020

ANTHONY T. SYCKO, JR., P.S. PROFESSIONAL SURVEYOR MICHIGAN LICENSE NO. 47976 22556 GRATIOT AVE., EASTPOINTE, MI 48021 TSycko@kemtec-survey.com

1 OF 1 SHEETS

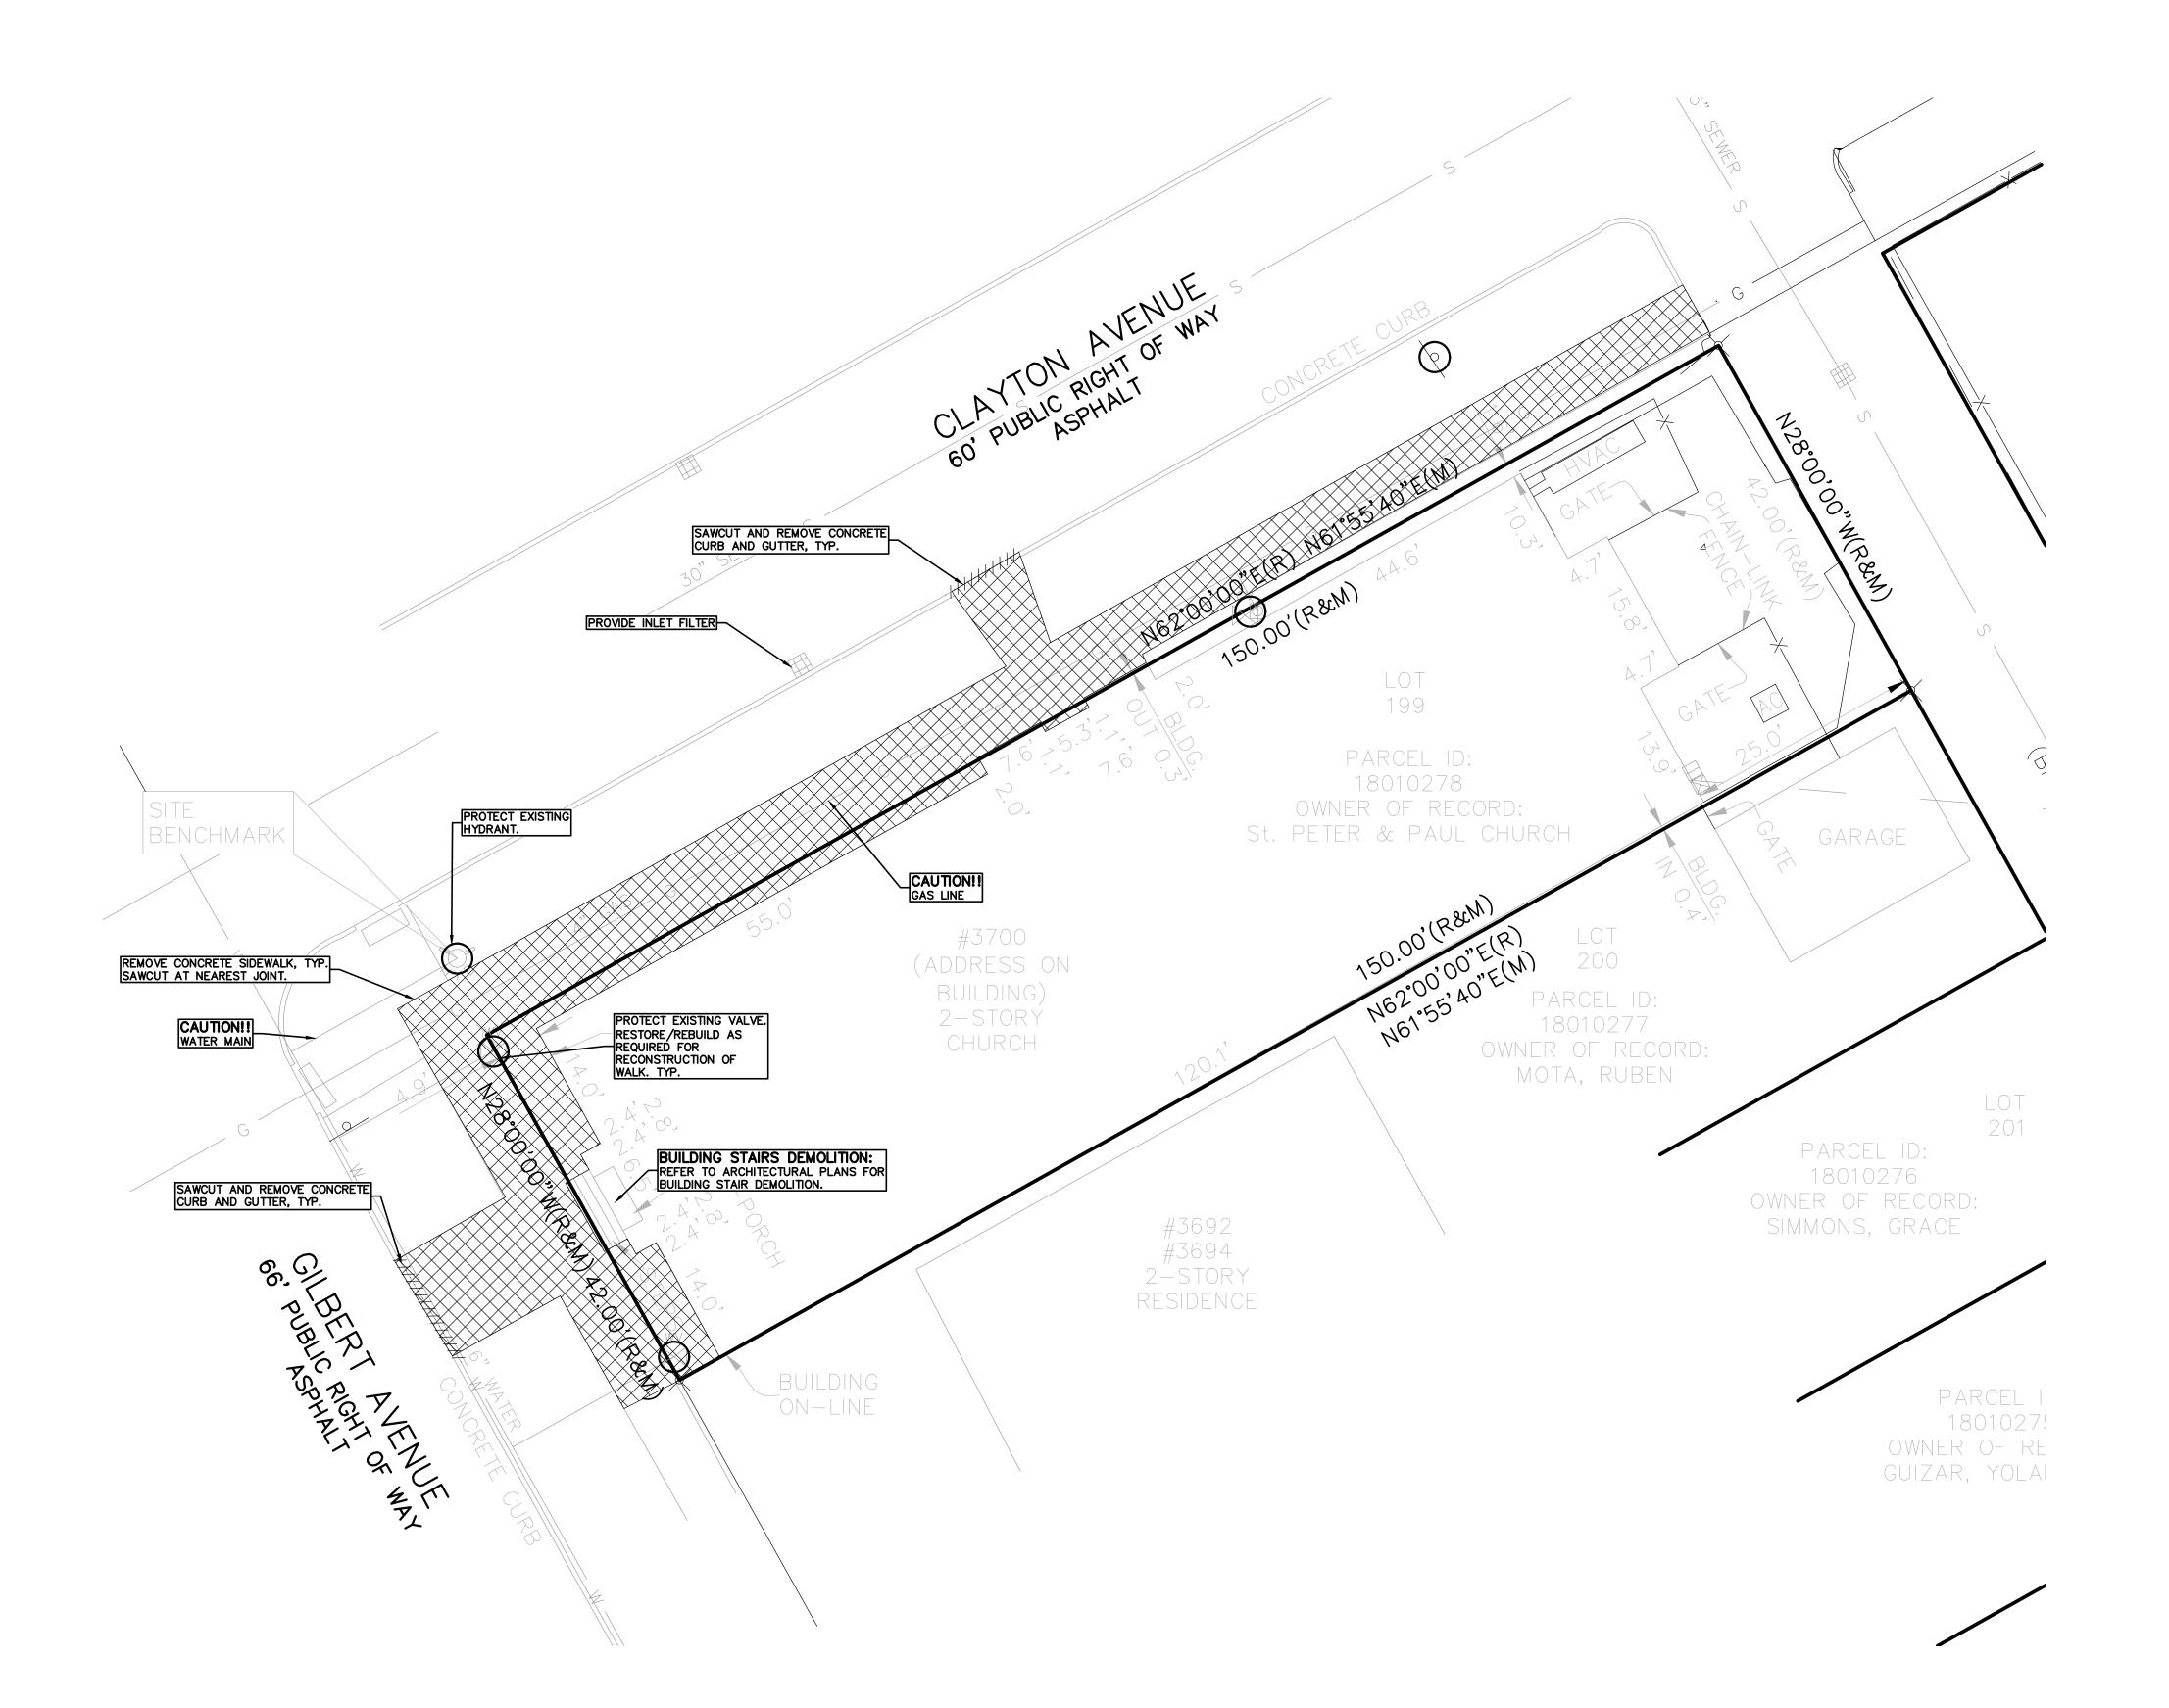

GENERAL DEMOLITION NOTES:

THESE NOTES APPLY TO ALL CONSTRUCTION ACTIVITIES ON THIS PROJECT:


- 1. ALL MATERIAL TO BE REMOVED, WHETHER SPECIFICALLY NOTED IN THE PLANS OR NOT, SHALL BE REMOVED FROM THE SITE BY THE CONTRACTOR AND DISPOSED OF OFF-SITE IN A LEGAL MANNER. NO ON-SITE BURY OR BURN PITS SHALL BE ALLOWED.
- ALL DEMOLITION WORK SHALL CONFORM TO ALL LOCAL CODES AND ORDINANCES.
- 3. STAGING/PHASING OF DEMOLITION AND CONSTRUCTION IS TO BE COORDINATED WITH THE OWNER AND THE CONTRACTOR PRIOR TO CONSTRUCTION.
- SPECIFIC DEMOLITION ITEMS HAVE BEEN INDICATED ON THE PLANS AS A GUIDE TO THE GENERAL SCOPE OF THE WORK. IT IS THE INTENT THAT THESE ITEMS SHALL BE COMPLETELY REMOVED BY THE CONTRACTOR ABOVE AND BELOW GROUND, UNLESS SPECIFICALLY NOTED OTHERWISE, AND THAT DEMOLITION WILL INCLUDE BUT WILL NOT NECESSARILY BE LIMITED TO THESE ITEMS. CONTRACTOR SHALL VISIT SITE TO VERIFY EXISTING CONDITIONS AND EXTENTS OF THE DEMOLITION THAT WILL BE REQUIRED PRIOR TO SUBMITTING A BID.
- 5. REMOVE ALL STRUCTURES DESIGNATED FOR REMOVAL ACCORDING TO THE DEMOLITION PLAN. THIS INCLUDES FOUNDATIONS, FOOTINGS, FOUNDATION WALLS, FLOOR SLABS, UNDERGROUND UTILITIES, CONCRETE, ASPHALT, TREES, ETC.
- 6. THE CONTRACTOR SHALL, AS A MINIMUM, PROVIDE TREE PROTECTION FENCING AROUND EXISTING TREES TO BE SAVED THAT ARE WITHIN 15 FEET OF CONSTRUCTION ACTIVITIES AND AS INDICATED IN THE PLANS OR PER LOCAL AGENCY REQUIREMENTS.
- 7. THE CONTRACTOR SHALL BE RESPONSIBLE FOR CLEAN UP, NOISE, DUST CONTROL, STREET SWEEPING AND HOURS OF OPERATION IN ACCORDANCE WITH THE LOCAL CODES.
- 8. THE CONTRACTOR SHALL PROVIDE ALL NECESSARY BARRICADES, SIGNAGE, MARKINGS, LIGHTS AND OTHER TRAFFIC CONTROL DEVICES TO PROTECT THE WORK ZONE AND SAFELY MAINTAIN TRAFFIC PER AGENCY REQUIREMENTS AND IN ACCORDANCE WITH THE LATEST EDITION OF THE STATE MANUAL OF UNIFORM TRAFFIC CONTROL DEVICES.
- 9. THE CONTRACTOR SHALL CONTACT THE APPROPRIATE UTILITY COMPANIES TO CONFIRM THAT UTILITY LEADS HAVE BEEN TAKEN OUT OF SERVICE PRIOR TO DEMOLITION.
- 10. ALL BUILDING GAS LEADS, METERS AND ASSOCIATED EQUIPMENT SHALL BE REMOVED AS SHOWN ON THE PLANS. COORDINATE ALL ASSOCIATED WORK WITH THE APPROPRIATE UTILITY COMPANY.
- 11. REMOVE ALL OVERHEAD AND UNDERGROUND ELECTRICAL LINES WITHIN THE AREA OF CONSTRUCTION AS SHOWN ON THE PLANS. COORDINATE SHUTDOWNS AND REMOVALS WITH ELECTRICAL SERVICE PROVIDER OR THE APPROPRIATE UTILITY COMPANY. (NOTE: PHONE AND CABLE T.V. SERVICES MAY ALSO BE LOCATED ON OVERHEAD LINES.)


 12. THE CONTRACTOR IS RESPONSIBLE FOR THE REMOVAL
- AND REPLACEMENT OF SIGNS AND SUPPORTS WITHIN THE WORK AREA, AS NECESSARY TO FACILITATE CONSTRUCTION. SIGNS SHALL BE PROTECTED OR STOCKPILED FOR REUSE AS SPECIFIED IN THE PLANS OR AS REQUIRED BY THE AGENCY OF JURISDICTION. THE CONTRACTOR SHALL REPLACE ANY DAMAGED SIGNS AND SUPPORTS AT NO ADDITIONAL COST TO THE OWNER.
- 13. THE CONTRACTOR SHALL NOTIFY THE APPROPRIATE 811/ONE CALL UTILITY LOCATING CENTER, THE CITY ENGINEER AND/OR THE AUTHORITY HAVING JURISDICTION 3 BUSINESS DAYS PRIOR TO THE BEGINNING OF CONSTRUCTION.


PEA GROUP t: 844.813.2949



www.peagroup.com

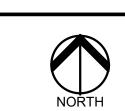

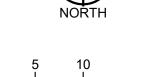

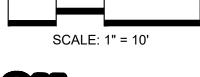



CAUTION!!

THE LOCATIONS AND ELEVATIONS OF EXISTING UNDERGROUND UTILITIES AS SHOWN ON THIS DRAWING ARE ONLY APPROXIMATE. NO GUARANTEE IS EITHER EXPRESSED OR IMPLIED AS TO THE COMPLETENESS OR ACCURACY THEREOF. THE CONTRACTOR SHALL BE EXCLUSIVELY RESPONSIBLE FOR DETERMINING THE EXACT UTILITY LOCATIONS AND ELEVATIONS PRIOR TO THE START OF CONSTRUCTION.

CLIENT

INTOTO STUDIO 6505 WOODWARD AVE., SUITE 201 DETROIT, MI

DEMOLITION LEGEND:

ITEM TO BE PROTECTED

ITEM TO BE REMOVED

CURB/FENCE REMOVAL

CONCRETE PAVEMENT AND
SIDEWALK REMOVAL

SAWCUT LINE

AREA OR ITEMS TO BE REMOVED

UTILITY REMOVAL ***

ABANDON UTILITY

ASPHALT REMOVAL

TREE REMOVAL

3700 GILBERT RENOVATION 3700 GILBERT ST. DETROIT, WAYNE COUNTY, MI

PROJECT TITLE

-/-/-/-/-/-/-/-/-/-/-/

REVISIONS
-

ORIGINAL ISSUE DATE: MAY 24, 2024

DRAWING TITLE

DEMOLITION PLAN

 PEA JOB NO.
 24-0720


 P.M.
 ESB


 DN.
 XXX

 DES.
 RDW

DRAWING NUMBER:

C-1.0

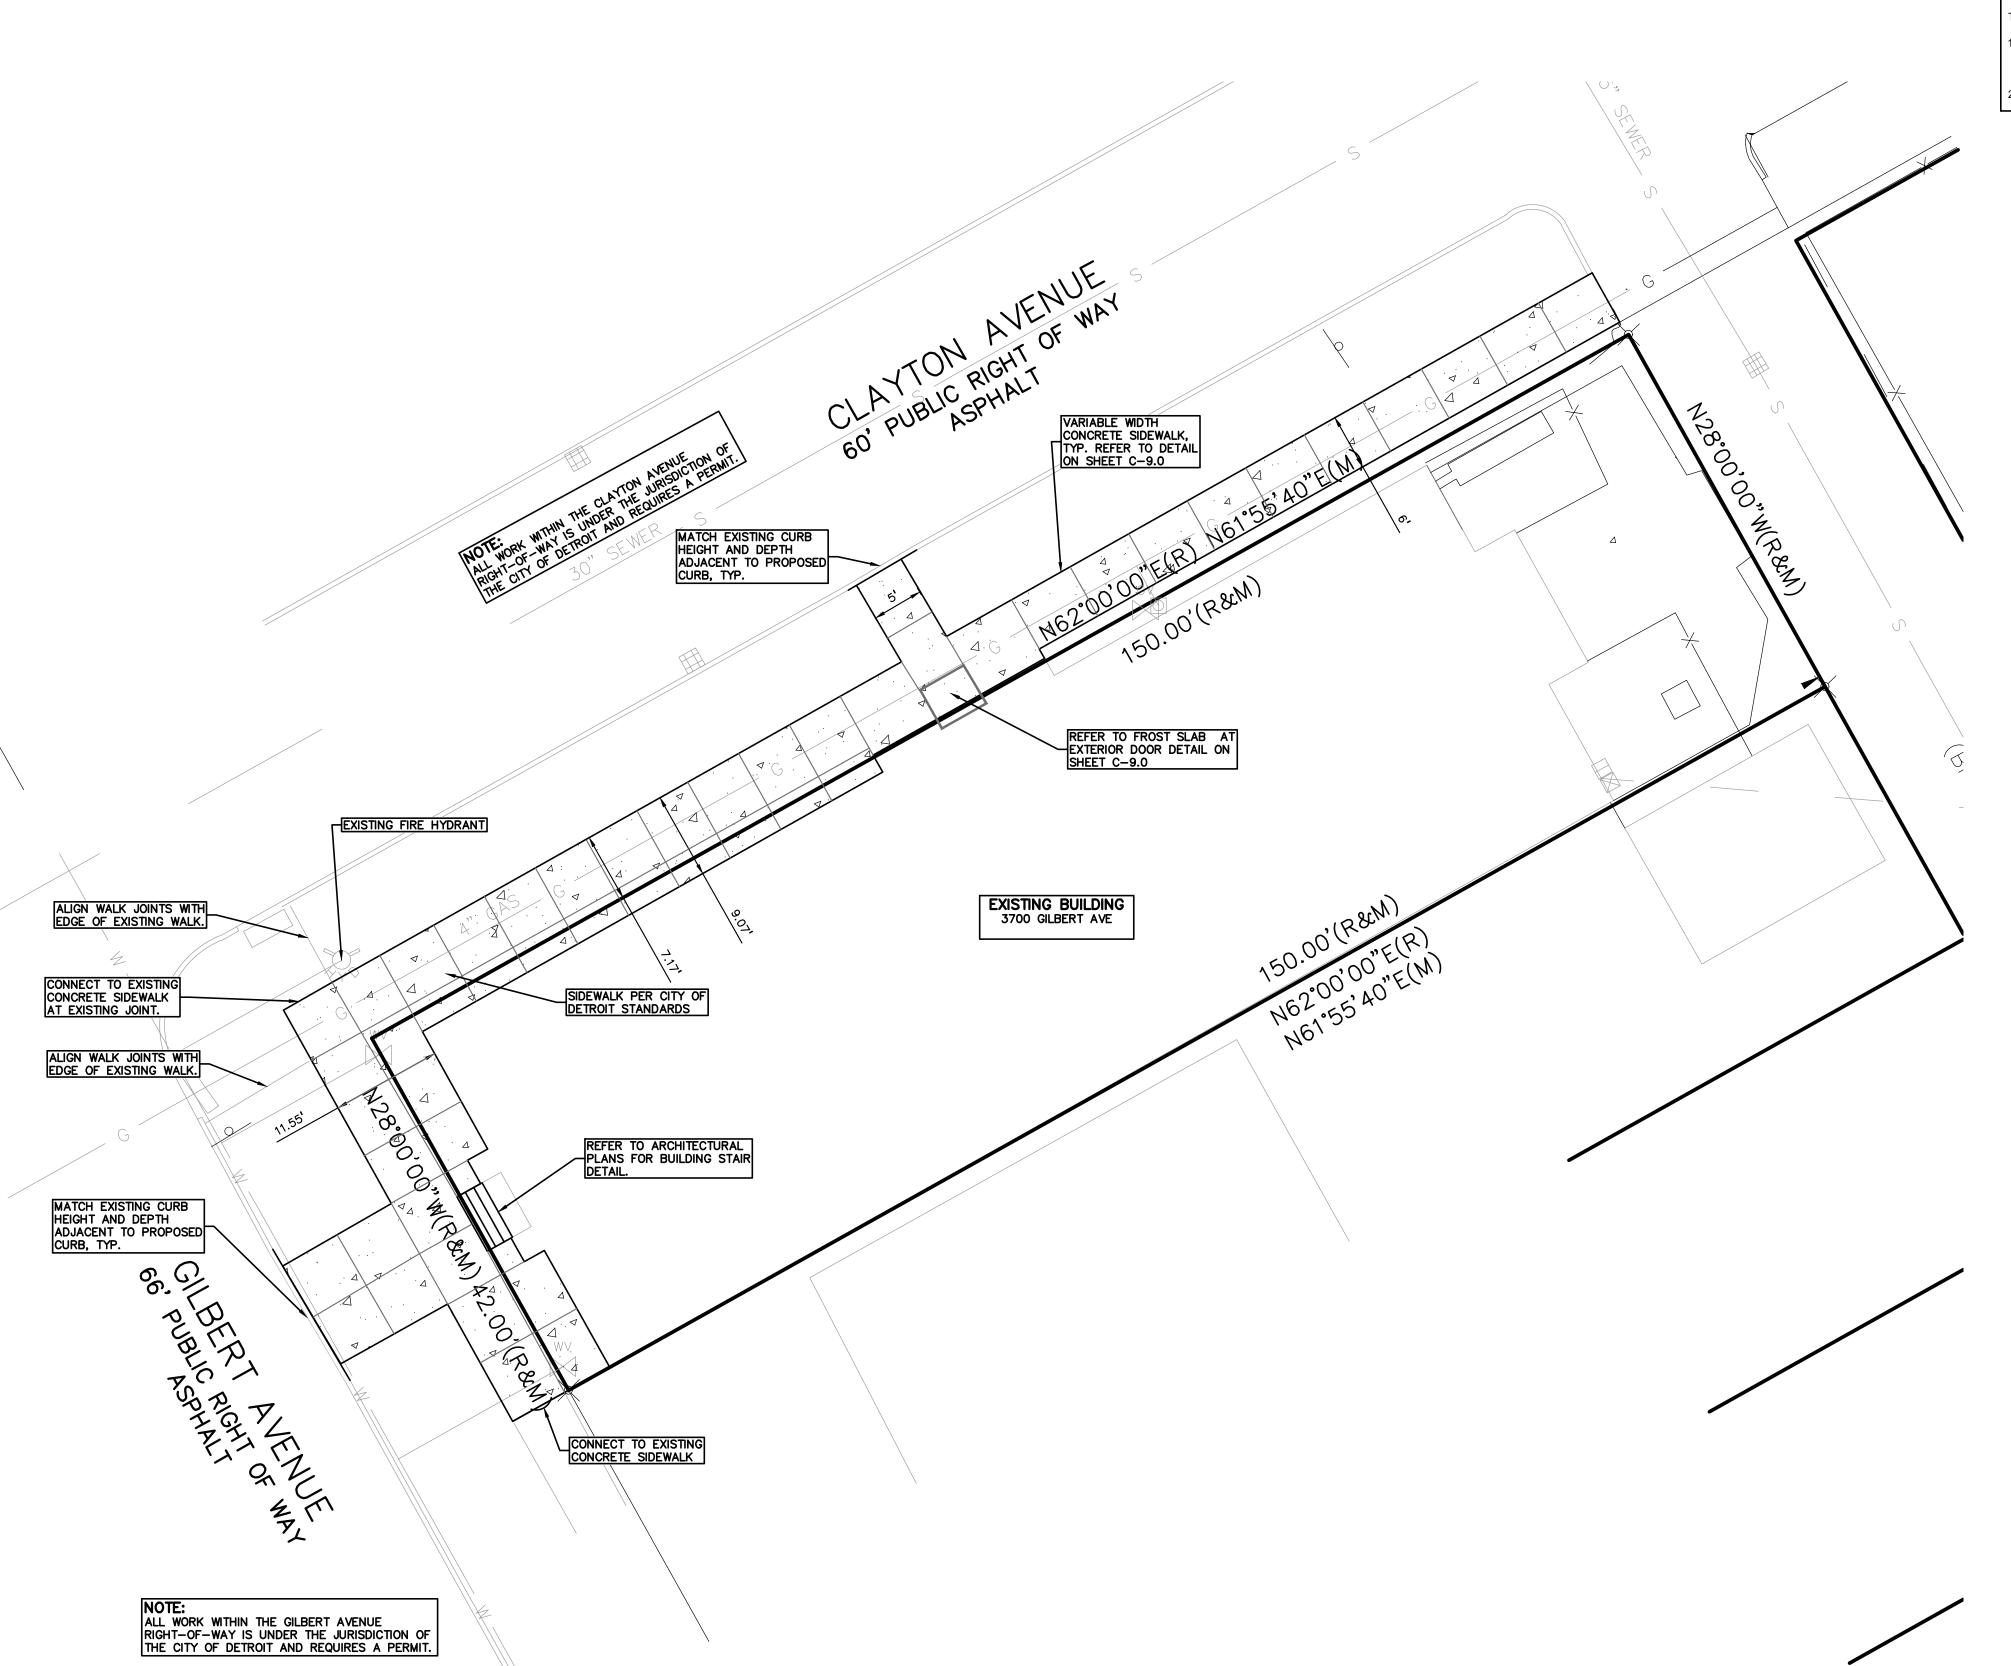

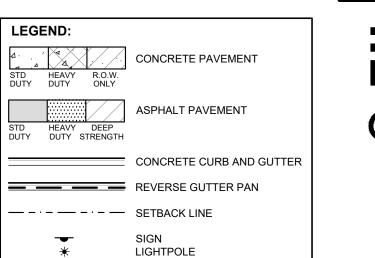


GROUP t: 844.813.2949 www.peagroup.com

GENERAL NOTES:

THESE NOTES APPLY TO ALL CONSTRUCTION ACTIVITIES ON THIS PROJECT.

. ALL DIMENSIONS SHOWN ARE TO BACK OF CURB, FACE OF SIDEWALK, OUTSIDE FACE OF BUILDING, PROPERTY LINE, CENTER OF MANHOLE/CATCH BASIN OR CENTERLINE OF PIPE UNLESS OTHERWISE NOTED.

REFER TO NOTES & DETAILS SHEET FOR ON-SITE PAVING DETAILS.

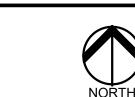

PREMIUM TRENCH BACKFILL NOTE:
ALL UTILITIES UNDER PAVEMENT OR WITHIN 3' OF THE EDGE OF PAVEMENT (OR WITHIN THE 45° LINE OF INFLUENCE OF PAVEMENT) SHALL HAVE M.D.O.T. CLASS II GRANULAR BACKFILL COMPACTED TO 95% MAX. DRY DENSITY (ASTM

DWSD NOTE:

ALL WORK MUST BE DONE IN ACCORDANCE WITH THE LATEST VERSION OF THE CITY OF DETROIT WATER & SEWERAGE DEPARTMENT STANDARD SPECIFICATIONS AND DETAILS.



SCALE: 1" = 10'



CAUTION!! THE LOCATIONS AND ELEVATIONS OF EXISTING UNDERGROUND UTILITIES AS SHOWN ON THIS DRAWING ARE ONLY APPROXIMATE. NO GUARANTEE IS EITHER EXPRESSED OR IMPLIED AS TO THE COMPLETENESS OR ACCURACY THEREOF. THE CONTRACTOR SHALL BE EXCLUSIVELY RESPONSIBLE FOR DETERMINING THE EXACT UTILITY LOCATIONS AND ELEVATIONS PRIOR TO THE START OF CONSTRUCTION.

CLIENT

INTOTO STUDIO 6505 WOODWARD AVE., SUITE 201 DETROIT, MI


PROJECT TITLE

3700 GILBERT RENOVATION 3700 GILBERT ST. DETROIT, WAYNE COUNTY, MI

ORIGINAL ISSUE DATE: MAY 24, 2024 DRAWING TITLE

DIMENSION AND PAVING PLAN

24-0720 PEA JOB NO. ESB XXX RDW DES. DRAWING NUMBER:

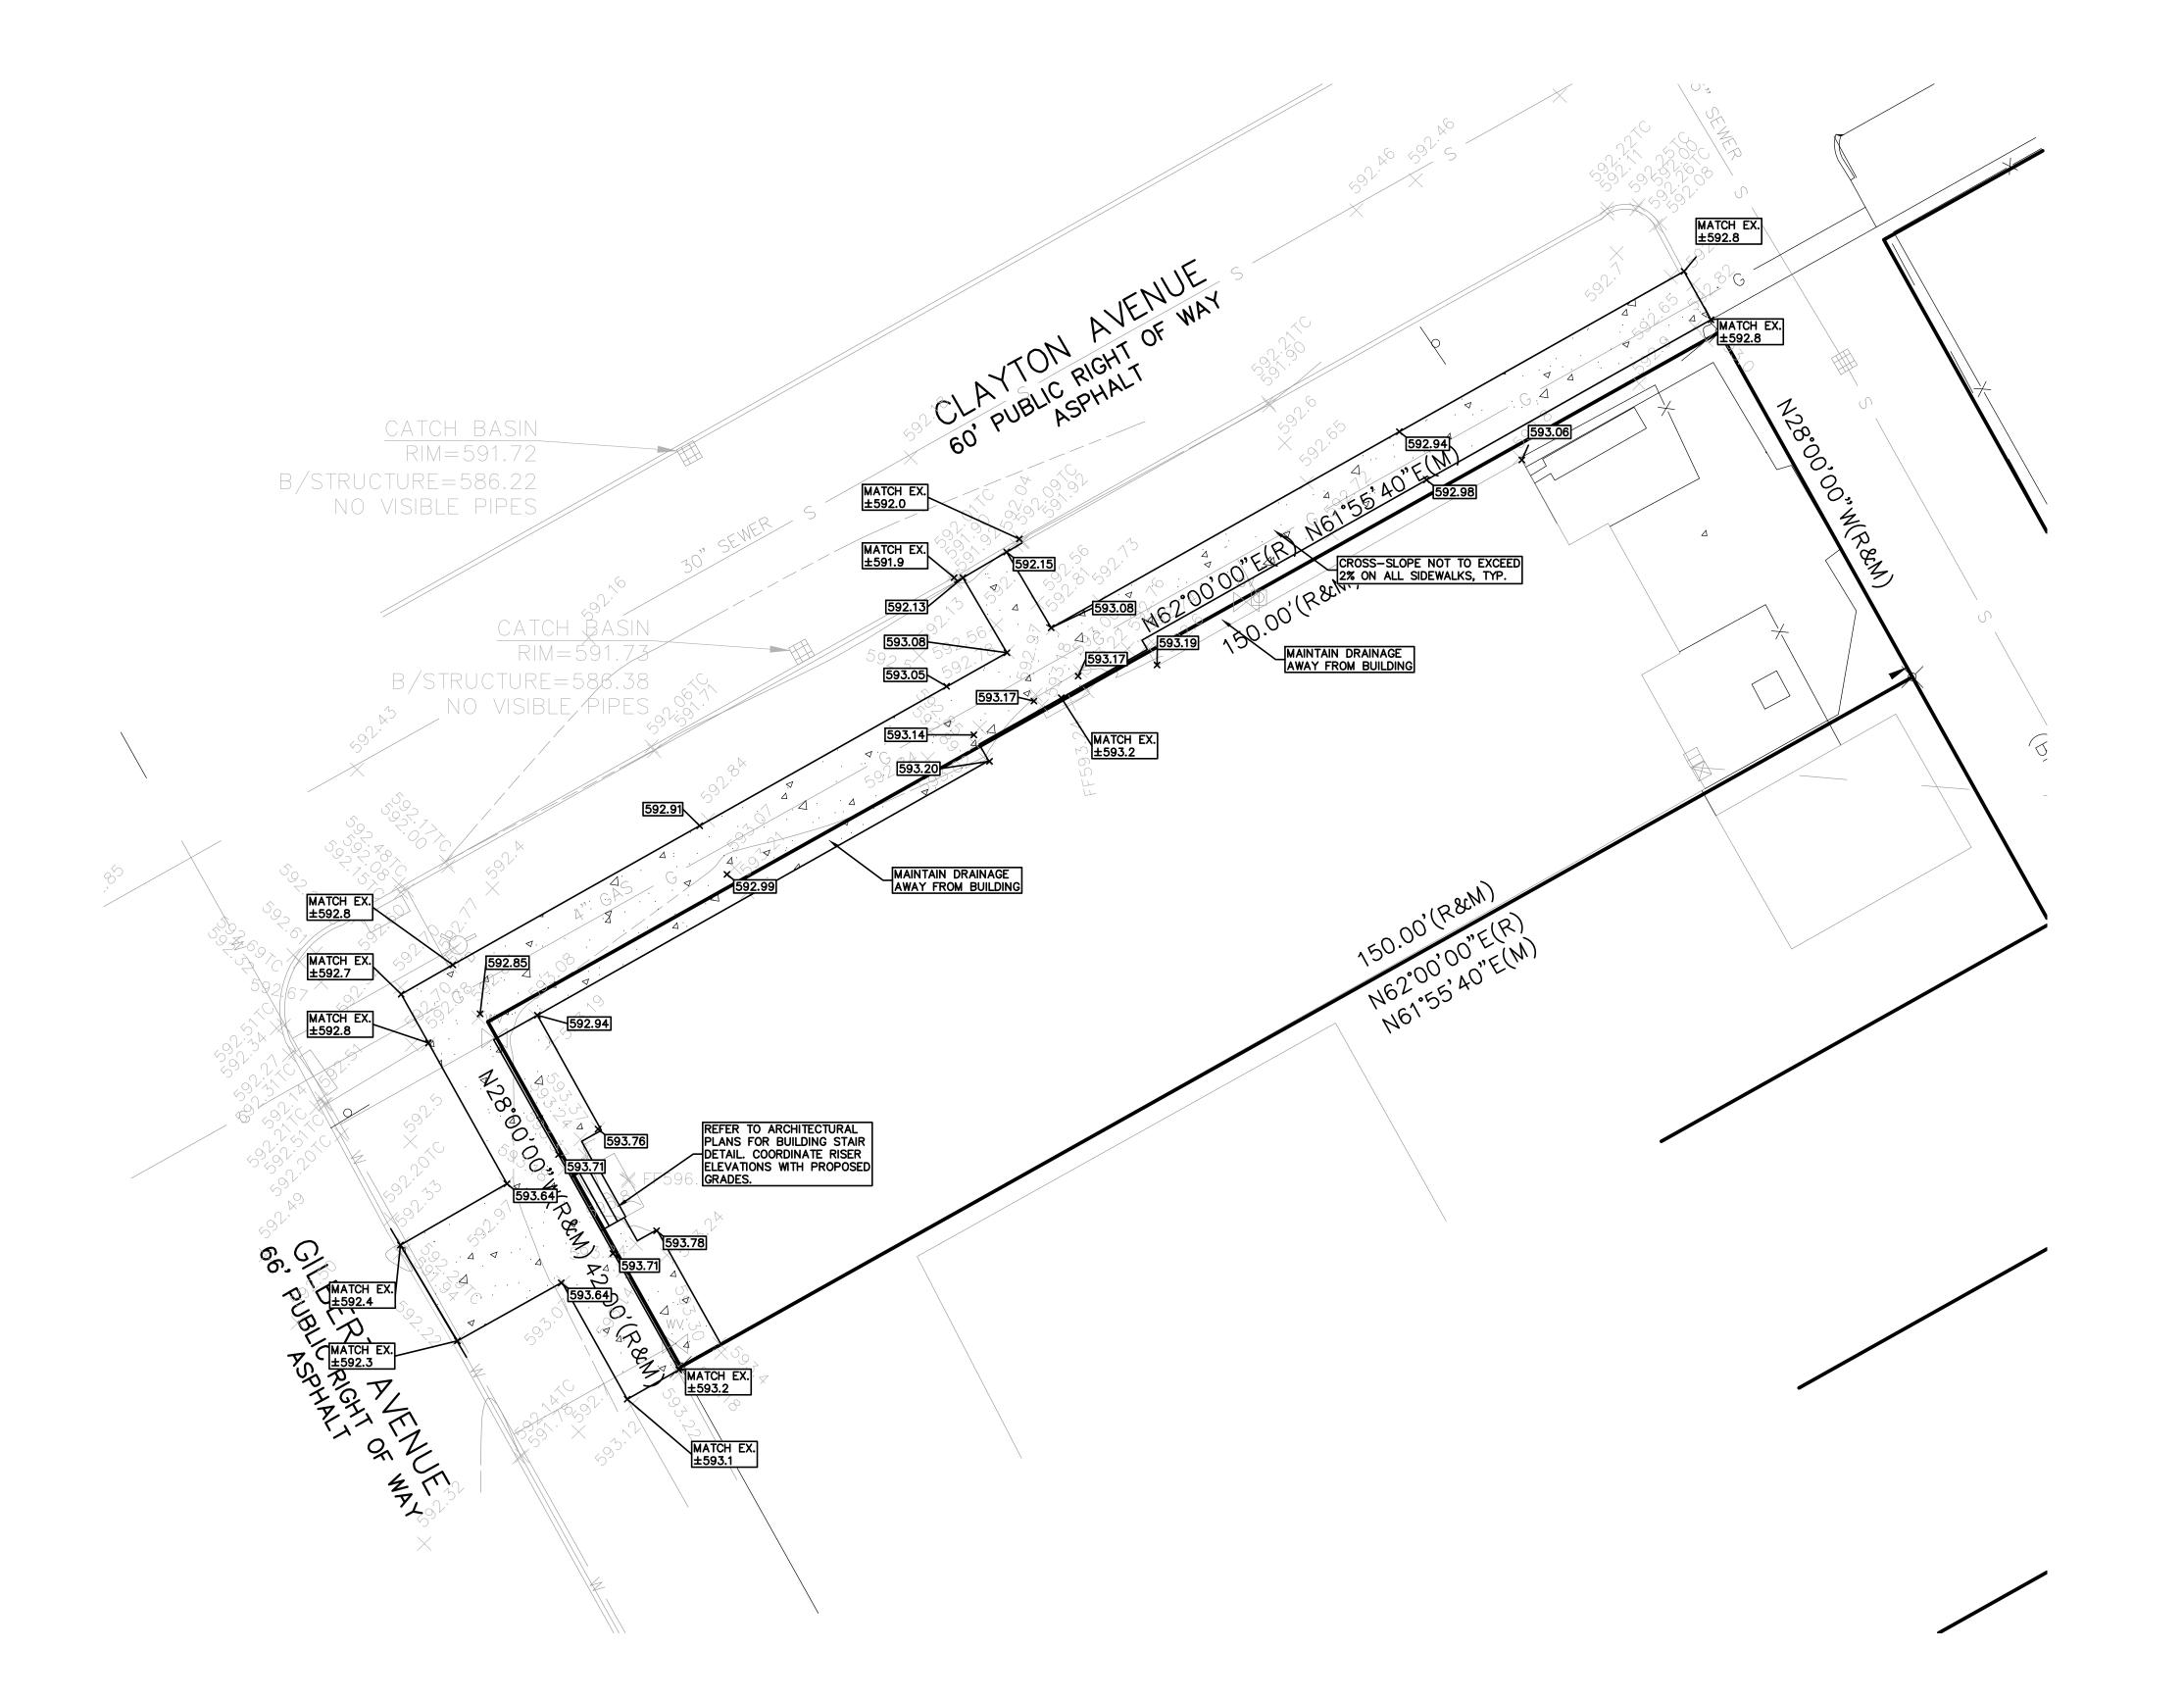

GRADING LEGEND:

EXISTING SPOT ELEVATION PROPOSED SPOT ELEVATION: TYPICALLY TOP OF PAVEMENT

IN PAVED AREAS, GUTTER GRADE GROUP

 EXISTING CONTOUR ——922—— PROPOSED CONTOUR

IN CURB LINES.

PROPOSED REVERSE GUTTER PAN - - - PROPOSED RIDGE LINE

ABBREVIATIONS

T/C = TOP OF CURB G = GUTTER GRADE T/P = TOP OF PAVEMENT FF = FINISH FLOOR T/S = TOP OF SIDEWALK FG = FINISH GRADE
T/W = TOP OF WALL RIM = RIM ELEVATION B/W = BOTTOM OF WALL

----- PROPOSED SWALE/DITCH

REFER TO GRADING NOTES ON SHEET C-9.0

EARTHWORK BALANCING NOTE:

THE CONTRACTOR SHALL BE RESPONSIBLE FOR IMPORTING OR EXPORTING ALL MATERIALS AS REQUIRED TO PROPERLY GRADE THIS PROJECT TO THE FINISHED ELEVATIONS SHOWN ON THE APPROVED PLANS. THE CONTRACTOR SHALL MAKE THEIR OWN DETERMINATION OF CUT AND FILL QUANTITIES AND ALLOW FOR REMOVAL OF EXCESS OR IMPORTATION OF ADDITIONAL MATERIAL AT NO ADDITIONAL COST TO THE OWNER.

BENCHMARKS: (NAVD 88)

SITE BENCHMARK


ARROW ON FIRE HYDRANT AT SE CORNER OF GILBERT AND CLAYTON. ELEV. - 595.83



t: 844.813.2949

www.peagroup.com



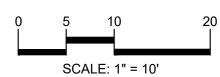



CAUTION!! THE LOCATIONS AND ELEVATIONS OF EXISTING UNDERGROUND UTILITIES AS SHOWN ON THIS DRAWING ARE ONLY APPROXIMATE. NO GUARANTEE IS EITHER EXPRESSED OR IMPLIED AS TO THE COMPLETENESS OR ACCURACY THEREOF. THE CONTRACTOR SHALL BE EXCLUSIVELY RESPONSIBLE FOR DETERMINING THE EXACT UTILITY LOCATIONS AND ELEVATIONS PRIOR TO THE START OF CONSTRUCTION.

CLIENT

INTOTO STUDIO 6505 WOODWARD AVE., SUITE 201 DETROIT, MI

PROJECT TITLE

3700 GILBERT RENOVATION 3700 GILBERT ST. DETROIT, WAYNE COUNTY, MI

DRAWING TITLE

ORIGINAL ISSUE DATE: MAY 24, 2024

GRADING PLAN

PEA JOB NO. 24-0720 XXX RDW

DRAWING NUMBER:

GENERAL NOTES:

FOR ALL CITY INSPECTION FEES.

- THESE NOTES APPLY TO ALL CONSTRUCTION ACTIVITIES ON THIS PROJECT.
- ALL CONSTRUCTION, WORKMANSHIP AND MATERIALS SHALL BE IN ACCORDANCE WITH CURRENT OSHA, MDOT AND MUNICIPALITY STANDARDS AND REGULATIONS.
- 2. THE CONTRACTOR SHALL NOTIFY THE CITY ENGINEER AND/OR THE AUTHORITY HAVING JURISDICTION 3 BUSINESS DAYS PRIOR TO THE BEGINNING OF CONSTRUCTION.
- THE CONTRACTOR SHALL CONTACT THE ENGINEER SHOULD THEY ENCOUNTER ANY DESIGN ISSUES DURING CONSTRUCTION. IF THE CONTRACTOR MAKES DESIGN MODIFICATIONS WITHOUT THE WRITTEN DIRECTION OF THE DESIGN ENGINEER, THE CONTRACTOR DOES SO
- ALL NECESSARY PERMITS, TESTING, BONDS AND INSURANCES ETC., SHALL BE PAID FOR BY THE CONTRACTOR. THE OWNER SHALL PAY
- THE CONTRACTOR SHALL NOTIFY THE APPROPRIATE 811/ONE CALL UTILITY LOCATING CENTER, THE CITY ENGINEER AND/OR THE AUTHORITY HAVING JURISDICTION 3 BUSINESS DAYS PRIOR TO THE BEGINNING OF CONSTRUCTION. IF NO NOTIFICATION IS GIVEN AND DAMAGE RESULTS, SAID DAMAGE WILL BE REPAIRED AT SOLE EXPENSE OF THE CONTRACTOR. IF EXISTING UTILITY LINES ARE ENCOUNTERED THAT CONFLICT IN LOCATION WITH NEW CONSTRUCTION, THE CONTRACTOR SHALL NOTIFY THE DESIGN ENGINEER SO THAT THE CONFLICT MAY BE RESOLVED.
- CONTRACTOR SHALL VERIFY THAT THE PLANS AND SPECIFICATIONS ARE THE VERY LATEST PLANS AND SPECIFICATIONS AND FURTHERMORE, VERIFY THAT THESE PLANS AND SPECIFICATIONS HAVE BEEN APPROVED. ALL ITEMS CONSTRUCTED BY THE CONTRACTOR PRIOR TO RECEIVING FINAL APPROVAL, HAVING TO BE ADJUSTED OR RE-DONE, SHALL BE AT THE CONTRACTORS EXPENSE. SHOULD THE CONTRACTOR ENCOUNTER A CONFLICT BETWEEN THESE PLANS AND/OR SPECIFICATIONS, THEY SHALL SEEK CLARIFICATION IN WRITING FROM THE ENGINEER BEFORE COMMENCEMENT OF CONSTRUCTION. FAILURE TO DO SO SHALL BE AT SOLE
- ANY WORK WITHIN THE STREET OR HIGHWAY RIGHTS-OF-WAY SHALL BE PERFORMED IN ACCORDANCE WITH THE REQUIREMENTS OF THE AGENCIES HAVING JURISDICTION AND SHALL NOT BEGIN UNTIL ALL NECESSARY PERMITS HAVE BEEN ISSUED FOR THE WORK.
- ALL PROPERTIES OR FACILITIES IN THE SURROUNDING AREAS, PUBLIC OR PRIVATE, DESTROYED OR OTHERWISE DISTURBED DUE TO CONSTRUCTION, SHALL BE REPLACED AND/OR RESTORED TO THE ORIGINAL CONDITION BY THE CONTRACTOR.
-). THE CONTRACTOR SHALL PROVIDE ALL NECESSARY BARRICADING, SIGNAGE, LIGHTS AND TRAFFIC CONTROL DEVICES TO PROTECT THE WORK AND SAFELY MAINTAIN TRAFFIC IN ACCORDANCE WITH LOCAL REQUIREMENTS AND THE MANUAL OF UNIFORM TRAFFIC CONTROL DEVICES (LATEST EDITION). THE DESIGN ENGINEER, OWNER, CITY AND STATE SHALL NOT BE HELD LIABLE FOR ANY CLAIMS RESULTING FROM ACCIDENTS OR DAMAGES CAUSED BY THE CONTRACTOR'S FAILURE TO COMPLY WITH TRAFFIC AND PUBLIC SAFETY REGULATIONS
- 10. THE USE OF CRUSHED CONCRETE IS PROHIBITED ON THE PROJECT WITHIN 100 FEET OF ANY WATER COURSE (STREAM, RIVER, COUNTY DRAIN, ETC.) AND LAKE, REGARDLESS OF THE APPLICATION OR LOCATION OF THE WATER COURSE OR LAKE RELATIVE TO THE
- 1. IT SHALL BE THE RESPONSIBILITY OF THE CONTRACTOR TO ADJUST THE TOP OF ALL EXISTING AND PROPOSED STRUCTURES (MANHOLES, CATCH BASINS, INLETS, GATE WELLS ETC.) WITHIN GRADED AND /OR PAVED AREAS TO FINAL GRADE SHOWN ON THE PLANS. ALL SUCH ADJUSTMENTS SHALL BE INCIDENTAL TO THE JOB AND WILL NOT BE PAID FOR SEPARATELY.

CONSTRUCTION MATERIAL SUBMITTALS

UNLESS REQUIRED OTHERWISE IN THE PROJECT SPECIFICATIONS, THE CONTRACTOR SHALL ONLY SUBMIT THE FOLLOWING CONSTRUCTION MATERIAL SUBMITTALS, AS APPLICABLE TO THE PLANS, FOR REVIEW BY THE ENGINEER. UNLESS APPROVED IN ADVANCE AND IN WRITING BY THE ENGINEER, ANY MATERIAL SUBMITTALS PROVIDED TO THE ENGINEER FOR REVIEW IN ADDITION TO THIS LIST SHALL BE RETURNED TO THE CONTRACTOR WITHOUT A REVIEW BEING PERFORMED.

- SOIL EROSION AND SEDIMENTATION CONTROL MEASURES
- UTILITY TRENCH BACKFILL MATERIAL WITH ALL MATERIAL DATA INCLUDED IN THE SUBMITTAL BEING DATED WITHIN 60 DAYS OF THE SUBMITTAL UNLESS APPROVED OTHERWISE BY THE ENGINEER
- . PAVEMENT AGGREGATE BASE MATERIAL WITH ALL MATERIAL DATA INCLUDED IN THE SUBMITTAL BEING DATED WITHIN 60 DAYS OF THE SUBMITTAL UNLESS APPROVED OTHERWISE BY THE ENGINEER
- . PAVEMENT UNDERDRAIN MATERIAL AND BACKFILL WITH ALL BACKFILL MATERIAL DATA INCLUDED IN THE SUBMITTAL BEING DATED WITHIN 60 DAYS OF THE SUBMITTAL UNLESS APPROVED OTHERWISE BY THE ENGINEER
- PAVEMENT MIX DESIGNS SUBMITTED FOR REVIEW BY THE ENGINEER MUST FOLLOW THE CURRENT MDOT REVIEW CHECKLISTS AS SUMMARIZED BELOW AND ALL MATERIAL DATA INCLUDED IN THE SUBMITTAL BEING DATED WITHIN 60 DAYS OF THE SUBMITTAL
- UNLESS APPROVED OTHERWISE BY THE ENGINEER: •8.1. CONCRETE MIX DESIGN REVIEW CHECKLIST (FORM 2000)
- •8.2. SUPERPAVE MIX DESIGN CHECKLIST (FORM 1862) •8.3. MARSHALL MIX DESIGN CHECKLIST (FORM 1849)
- 5. SITE RAILINGS INCLUDING FOOTING OR EMBEDMENTS
- ANY ITEMS SHOWN IN THE PLANS OR DETAIL SHEETS THAT SPECIFICALLY STATE FOR THE CONTRACTOR TO SUBMIT A SHOP DRAWING TO THE ENGINEER FOR REVIEW. THESE ITEMS INCLUDE, BUT ARE NOT LIMITED TO:
- RETAINING WALL MATERIAL AND STRUCTURAL CALCULATIONS
- TRENCH DRAIN MATERIAL AND SHOP DRAWING DEPICTING THE LAYOUT OF THE SYSTEM
- ANY SPECIALITY ITEMS SHOWN IN THE PLANS OR DETAIL SHEETS THAT SPECIFICALLY DO NOT STATE FOR THE CONTRACTOR SHALL SUBMIT A SHOP DRAWING TO THE ENGINEER FOR REVIEW BUT THE CONTRACTOR REQUESTS TO BE REVIEWED. THE CONTRACTOR'S REQUEST FOR REVIEW MUST BE IN WRITING AND APPROVED BY THE ENGINEER PRIOR TO SUBMITTING THE

PAVING NOTES:


- IN AREAS WHERE NEW PAVEMENTS ARE BEING CONSTRUCTED, THE TOPSOIL AND SOIL CONTAINING ORGANIC MATTER SHALL BE REMOVED PRIOR TO PAVEMENT CONSTRUCTION.
- 2. REFER TO ARCHITECTURAL PLANS FOR DETAILS OF FROST SLAB AT EXTERIOR BUILDING DOORS.
- CONSTRUCTION TRAFFIC SHOULD BE MINIMIZED ON THE NEW PAVEMENT. IF CONSTRUCTION TRAFFIC IS ANTICIPATED ON THE PAVEMENT STRUCTURE, THE INITIAL LIFT THICKNESS COULD BE INCREASED AND PLACEMENT OF THE FINAL LIFT COULD BE DELAYED UNTIL THE MAJORITY OF THE CONSTRUCTION ACTIVITIES HAVE BEEN COMPLETED. THIS ACTION WILL ALLOW REPAIR OF LOCALIZED FAILURE, IF ANY DOES OCCUR. AS WELL AS REDUCE LOAD DAMAGE ON THE PAVEMENT SYSTEM.
- 4. ALL EXPANSION JOINTS AND CONCRETE PAVEMENT JOINTS TO BE SEALED.
- 5. CONCRETE PAVEMENT JOINTING UNLESS SHOWN OTHERWISE IN THE PLANS OR REQUIRED BY THE AUTHORITY HAVING JURISDICTION: 5.1. WHERE PROPOSED CONCRETE ABUTS A STRUCTURE, PROVIDE A MINIMUM 1/2" EXPANSION JOINT. THE JOINT FILLER BOARD MUST
- BE AT LEAST THE FULL DEPTH OF THE CONCRETE AND HELD DOWN A 1/2" TO ALLOW FOR SEALING. 5.2. WHERE PROPOSED CONCRETE ABUTS EXISTING CONCRETE OR IN BETWEEN POURS OF PROPOSED CONCRETE (CONSTRUCTION JOINT), PROVIDE 5/8" DOWELS EVERY 30" CENTER TO CENTER HALF WAY ALONG THE THICKNESS OF THE PROPOSED PAVEMENT. ALTERNATE DOWELS SIZES AND SPACING MUST BE APPROVED THE ENGINEER PRIOR TO COMMENCING WORK AND VIA THE
- 5.3. WHERE PROPOSED CONCRETE ABUTS EXISTING OR PROPOSED SIDEWALK OR CURBING, PROVIDE A MINIMUM 1/2" EXPANSION JOINT. 5.4. CONTROL, LONGITUDINAL AND/OR TRANSVERSE JOINTS SHALL BE PLACED TO PROVIDE PANELS WITHIN THE PAVEMENT AS SQUARE
- AS POSSIBLE WITH THE FOLLOWING MAXIMUM SPACING PARAMETERS:
- 5.4.1. 6-INCH THICK CONCRETE PAVEMENT: 12' X 12' 5.4.2. 8-INCH THICK CONCRETE PAVEMENT: 15' X 15'
- 5.5. IRREGULAR-SHAPED PANELS MAY REQUIRE THE USE OF REINFORCING MESH OR FIBER MESH AS DETERMINED BY THE ENGINEER.
- THE USE OF MESH MUST BE APPROVED THE ENGINEER PRIOR TO COMMENCING WORK AND VIA THE SUBMITTAL PROCESS. 5.6. IF A JOINT PLAN IS NOT PROVIDED IN THE PLANS, THE CONTRACTOR SHALL SUBMIT ONE TO THE ENGINEER FOR REVIEW PRIOR TO COMMENCING WORK AND VIA THE SUBMITTAL PROCESS.
- CONCRETE CURBING JOINTING UNLESS SHOWN OTHERWISE IN THE PLANS OR REQUIRED BY THE AUTHORITY HAVING JURISDICTION 6.1. JOINTS WHEN ADJACENT TO ASPHALT PAVEMENT
- 6.1.1. PLACE CONTRACTION JOINTS AT 10' INTERVALS 6.1.2. PLACE 1/2" EXPANSION JOINT AT CATCH BASINS, EXISTING AND PROPOSED SIDEWALK OR EXISTING CURBING.
- 6.1.3. PLACE 1" EXPANSION JOINT:
- 6.1.3.1. AT SPRING POINTS OF INTERSECTIONS OR ONE OF THE END OF RADIUS LOCATIONS IN A CURVE
- 6.1.3.2. AT 400' MAXIMUM INTERVALS ON STRAIGHT RUNS
- 6.1.3.3. AT THE END OF RADIUS AT OPPOSITE ENDS IN A CURBED LANDSCAPE ISLAND
- 6.2. JOINTS WHEN TIED TO CONCRETE PAVEMENT 6.2.1. PLACE CONTRACTION JOINTS OPPOSITE ALL TRANSVERSE CONTRACTION JOINTS IN PAVEMENT 6.2.2. PLACE 1/2" EXPANSION JOINT AT CATCH BASINS, EXISTING AND PROPOSED SIDEWALK OR EXISTING CURBING.
- 6.2.3. PLACE 1"EXPANSION JOINT OPPOSITE ALL TRANSVERSE EXPANSION JOINTS IN PAVEMENT
- 6.2.4. CURB AND GUTTER AND CONCRETE SHALL BE TIED TOGETHER SIMILAR TO A LONGITUDINAL LANE TIE JOINT (MDOT B1 JOINT) 6.3. IN BETWEEN POURS OF PROPOSED CONCRETE CURBING (CONSTRUCTION JOINT):
- 6.3.1. CARRY THE REBAR CONTINUOUSLY BETWEEN POURS 6.3.2. IF THE REBAR IS NOT LONG ENOUGH TO CARRY CONTINUOUSLY, THEN TIE TWO PIECES OF REBAR PER THE LATEST MDOT **SPECIFICATIONS**
- CONCRETE SIDEWALK JOINTING UNLESS SHOWN OTHERWISE IN THE PLANS OR REQUIRED BY THE AUTHORITY HAVING JURISDICTION
- 7.1. PLACE TRANSVERSE CONTRACTION JOINTS EQUAL TO THE WDTH OF THE WALK WHEN WDTH IS LESS THAN 8' 7.2. PLACE TRANSVERSE AND LONGITUDINAL CONTRACTION JOINTS EQUAL TO 1/2 THE WIDTH OF THE WALK WHEN WIDTH IS EQUAL TO
- OR GREATER THAN 8' 7.3. PLACE 1" EXPANSION JOINT WHERE ABUTTING SIDEWALK RAMP AND/OR RADIUS IN INTERSECTION
- 7.4. PLACE TRANSVERSE 1/2" EXPANSION JOINT AT MAXIMUM OF 100' SPACING
- 7.5. PLACE 1/2" EXPANSION JOINT WHEN ABUTTING A FIXED STRUCTURE. OTHER PAVEMENT (CONCRETE PAVEMENT AND DRIVE APPROACHES), UTILITY STRUCTURES, LIGHT POLE BASES AND COLUMNS


GENERAL GRADING AND EARTHWORK NOTES:

BLANKET PEGGED IN PLACE OVER SEED.

OR AS DICTATED BY FIELD CONDITIONS.

- THESE NOTES APPLY TO ALL CONSTRUCTION ACTIVITIES ON THIS PROJECT
- CONTRACTOR SHALL FIELD VERIFY ALL EXISTING TREES AND BRUSH AND REMOVE ALL THAT ARE NECESSARY TO GRADE SITE.
- . ALL GRADES ARE TO TOP OF PAVEMENT UNLESS OTHERWISE NOTED.
- THE STAGING OF CONSTRUCTION ACTIVITIES SHALL OCCUR ONLY WITHIN THE SITE BOUNDARIES. ANY CONSTRUCTION ACTIVITIES OUTSIDE
- OF THE SITE BOUNDARIES SHALL BE AT THE SOLE RESPONSIBILITY AND RISK OF THE CONTRACTOR.
- ALL SOIL EROSION AND SEDIMENTATION CONTROL MEASURES SHALL MEET THE REQUIREMENTS OF THE AUTHORIZED PUBLIC AGENCY OF JURISDICTION. AN EROSION CONTROL PERMIT MUST BE SECURED FROM THE CITY PRIOR TO CONSTRUCTION.
- 5. ALL EARTHWORK AND GRADING OPERATIONS SHALL BE PERFORMED IN ACCORDANCE WITH THE SOILS INVESTIGATION AND REPORT.
- REFER TO SOIL EROSION CONTROL PLAN FOR ADDITIONAL SOIL EROSION AND SEDIMENTATION CONTROL MEASURES AND NOTES.
- THE DETENTION BASIN SIDE SLOPES AND ALL SLOPE EXCEEDING 1:6 MUST BE STABILIZED BY SODDING OR BY PLACING A MULCH
- 3. ALL DISTURBED AREAS SHALL BE SEEDED AND MULCHED OR SODDED IN ACCORDANCE WITH THE LANDSCAPE PLANS. PROVIDE A MINIMUM OF 3" OF TOPSOIL IN THESE AREAS UNLESS OTHERWISE NOTED.
- THE CONTRACTOR SHALL NOTE EXISTING UNDERGROUND UTILITIES WITHIN AND ADJACENT TO THE SITE. BACKFILL FOR EXISTING UTILITY TRENCHES SHALL BE EXAMINED CRITICALLY. ANY TRENCHES FOUND TO HAVE SOFT, UNSTABLE OR UNSUITABLE BACKFILL MATERIAL, I THE OPINION OF THE THIRD PARTY TESTING COMPANY, THAT ARE TO BE WITHIN THE ZONE OF INFLUENCE OF PROPOSED BUILDINGS OR
- PAVEMENT SHALL BE COMPLETELY EXCAVATED AND BACKFILLED WITH SUITABLE MATERIAL. 10. ON-SITE FILL CAN BE USED IF THE SPECIFIED COMPACTION REQUIREMENTS CAN BE ACHIEVED. IF ON-SITE SOIL IS USED, IT SHOULD BE CLEAN AND FREE OF FROZEN SOIL, ORGANICS, OR OTHER DELETERIOUS MATERIALS.
- SUBGRADE/EXISTING AGGREGATE BASE SHOULD BE THOROUGHLY PROOFROLLED USING A FULLY LOADED TANDEM AXLE TRUCK OR FRONT END LOADER UNDER THE OBSERVATION OF A GEOTECHNICAL/PAVEMENT ENGINEER. LOOSE OR YIELDING AREAS THA CANNOT BE MECHANICALLY STABILIZED SHOULD BE REINFORCED USING GEOGRIDS OR REMOVED AND REPLACED WITH ENGINEERED FILL
- 12. SUBGRADE UNDERCUTTING, INCLUDING BACKFILLING SHALL BE PERFORMED TO REPLACE MATERIALS SUSCEPTIBLE TO FROST HEAVING AND UNSTABLE SOIL CONDITIONS. ANY EXCAVATIONS THAT MAY BE REQUIRED BELOW THE TOPSOIL IN FILL AREAS OR BELOW SUBGRADE IN CUT AREAS WILL BE CLASSIFIED AS SUBGRADE UNDERCUTTING.
- 13. SUBGRADE UNDERCUTTING SHALL BE PERFORMED WHERE NECESSARY AND THE EXCAVATED MATERIAL SHALL BECOME THE PROPERTY OF THE CONTRACTOR. ANY SUBGRADE UNDERCUTTING SHALL BE BACKFILLED AS RECOMMENDED IN THE GEOTECHNICAL ENGINEERING
- 14. ANY SUB-GRADE WATERING REQUIRED TO ACHIEVE REQUIRED DENSITY SHALL BE CONSIDERED INCIDENTAL TO THE JOB.

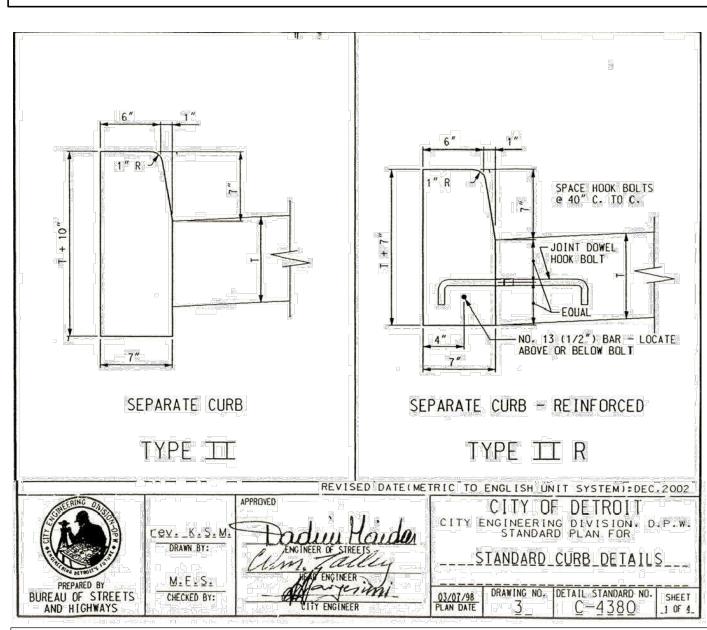


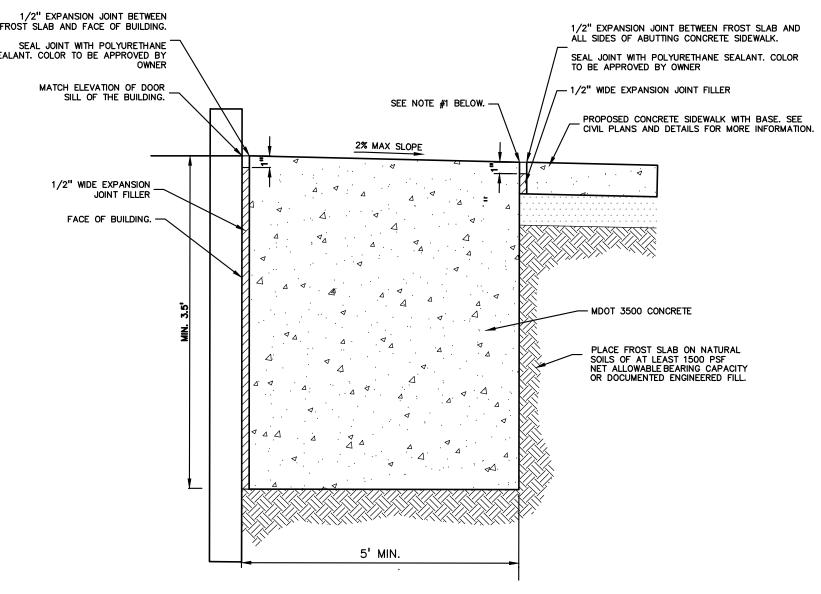


FROST SLAB AT EXTERIOR DOOR

NOTES:

- 1. WHEN FROST SLAB IS ABUTTING PAVEMENT WITH A VERTICAL FACE EXPOSED, THE EXPOSED VERTICAL FACE OF THE FROST SLAB SHALL HAVE A BROOM FINISH AND A 1" RADIUS AT THE EXPOSED CORNER SIMILAR TO THE INTEGRAL CURB AND WALK DETAIL.
- 2. UNLESS OTHERWISE NOTED, BIDDERS ARE TO ASSUME THAT ALL EXISTING STOOPS IN THE WORK AREA WILL BE REMOVED AND REPLACED WITH A FROST SLAB PER THIS DETAIL.
- 3. IF THE EXISTING STOOP IS FOUND TO BE A CONCRETE CAP ON TOP OF A FOOTING, REMOVE AND REPLACE CAP, PROTECT AND TIE NEW CAP INTO BUILDING FOOTING. PROVIDE CREDIT TO OWNER FOR CHANGE. SHOP DRAWINGS SHALL BE PROVIDED TO THE ENGINEER FOR REVIEW AND APPROVAL.

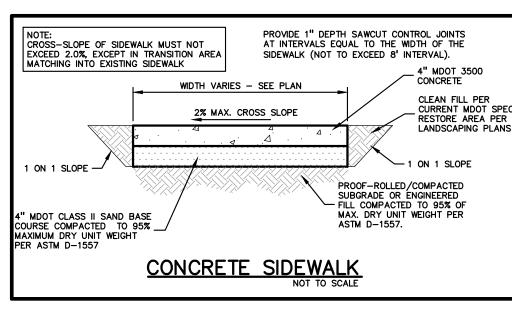

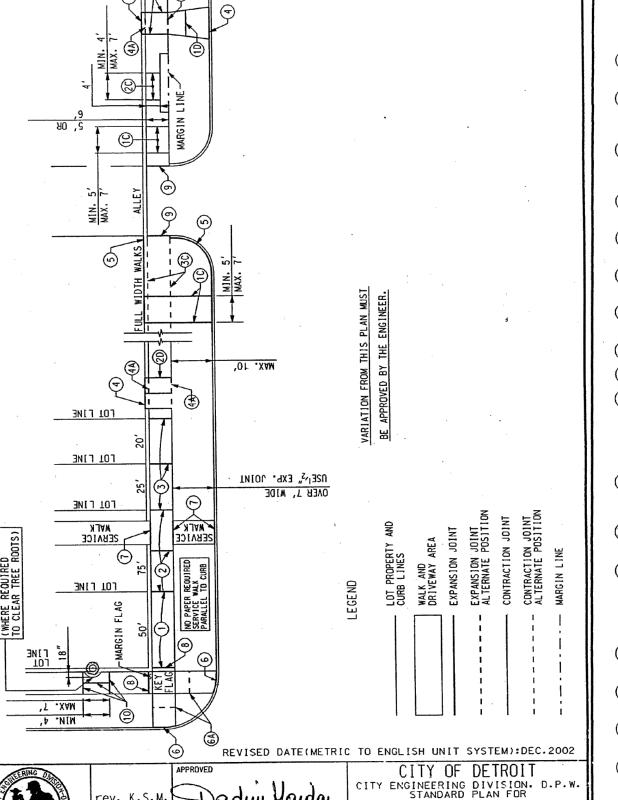

EXPANSION JOINTS

- ALL EXPANSION JOINT PAPER SHALL EXTEND 1" BELOW THE BOTTOM OF THE THINNER OF ADJOINING PAVEMENT SECTIONS.
- PLACE 1/2" PAPER EXPANSION JOINTS AT LOT LINES WHEN LOT LINES ARE BETWEEN 25' AND 50' APART.
- PLACE ADDITIONAL 1/2" PAPER EXPANSION JOINTS SO THAT THE DISTANCE BETWEEN JOINTS DOES NOT EXCEED 50' WHEN LOT LINES ARE OVER
- PLACE 1/2" PAPER EXPANSION JOINTS AT EVERY SECOND LOT LINE AND CONTRACTION JOINT AT INTERVENING LOT LINE WHEN LOT LINES ARE LESS THAN 25' APART.
- PLACE 1" PAPER EXPANSION JOINTS AT CURB AND BUILDING OR PROPERTY LINE OR AT ALTERNATE POSITION (A) AS SHOWN FOR DRIVEWAY.
- PLACE 1" PAPER EXPANSION JOINTS AT CURB AND BUILDING OR PROPERTY LINE FOR FULL WIDTH SIDEWALK EXCEEDING 7' IN WIDTH.
- PLACE 1" PAPER EXPANSION JOINTS AT CURB CIRCLES OR AT ALTERNATE POSITION (6A) AS SHOWN.
- PLACE 1" PAPER EXPANSION JOINTS AT INTERSECTIONS OF SERVICE WALKS AND SIDEWALKS AND SERVICE WALKS AND CURBS.
- (8) PLACE 1" PAPER EXPANSION JOINTS AT MARGIN FLAGS AT CROSSWALKS.
- (9) PLACE 1" PAPER EXPANSION JOINTS AT ALLEY APRONS. 10) PLACE 1/2" PAPER EXPANSION JOINT BOTH SIDES OF SIDEWALK FLAG ABUTTING TREE AND ON CENTERLINE JOINT.

CONTRACTION JOINTS

- PLACE CONTRACTION JOINTS AT INTERVALS OF NOT LESS THAN 5' NOR MORE THAN 7' ON WALKS 5' WIDE OR WIDER, INCLUDING FULL
- PLACE CONTRACTION JOINTS AT INTERVALS OF NOT LESS THAN 4' NOR MORE THAN 7' ON WALKS 4' WIDE.
- PLACE CONTRACTION JOINTS AT THE MARGIN LINE ON FULL WIDTH WALKS (OPTIONAL).

DRIVEWAYS

PLACE CONTRACTION JOINTS IN DRIVEWAYS SO THAT NO SLAB WILL EXCEED THE DIMENSIONS OF 15' BY 15'

REMOVAL SHALL BE "JOINT TO JOINT"

3. CONCRETE PAVEMENT CUTS SHALL BE MINIMUM 3' WIDE.

IN CONFORMANCE WITH MDOT STANDARD DETAIL R-44-F

1' BEYOND BASE CONCRETE REPAIR.

EXTENDED 1' BEYOND 1ST LIFT.

10. RESTORE HMA PAVEMENT $3\frac{1}{2}$ " TO MATCH EXISTING, IN 2 LIFTS:

4. ALL PAVEMENT CUTS SHALL BE MINIMUM 1' WIDER THAN TRENCH WIDTH.

5. ALL REMOVALS SHALL BE SAWCUT STRAIGHT AND SQUARE (90 DEGREES).

6. CONCRETE RESTORATION PAVEMENT SHALL BE MDOT P1 MIX (3,500 PSI).

7. RESTORED CONCRETE PAVEMENT SHALL MATCH THICKNESS OF EXISTING

CONCRETE PAVEMENT IN CONFORMANCE WITH MDOT STANDARDS DETAIL R-44-F

2ND LIFT - 1/2" MDOT HMA 5E3 (36A RESIDENTIAL), COMPACTED,

1ST LIFT - 2" MDOT HMA 4E3 (13A RESIDENTIAL), COMPACTED, EXTENDED

8. RESTORED CONCRETE SHALL BE ANCHORED TO EXISTING CONCRETE PAVEMENT

9. APPLY HMA TACK COAT PER MDOT STANDARD SPECIFICATIONS SECTION 904.

11. BITUMINOUS JOINT SEALER SHALL BE PLACED AT ALL FINISHED HMA JOINTS.

DELINEATORS, WILL HAVE TO BE REPLACED AT THE COST OF THE PERMIT

HOLDER, AND SHALL CONFORM TO THE LATEST CED / TED STANDARDS.


12. ALL DISTRUBED PAVEMENT MARKINGS AND OTHER ASSETS, INCLUDING BIKE LANE

13. FOR OTHER RELATED SPECIFICATIONS (BACKFILL COMPACTION, MATERIALS, ETC...

REFER TO DIVISION 15 OF THE STANDARD SPECIFICATIONS FOR PAVING AND

14. NOTIFY THE CITY OF DETROIT ENGINEERING DEPARTMENT 24 HOURS PRIOR

CITY ENGINEERING DIVISION. D.P.W STANDARD PLAN FOR F DRIVEWAY EDGE IS WITHIN 2 FEET OF LOT ___SIDEWALK_JOINTING_ __STANDARD_

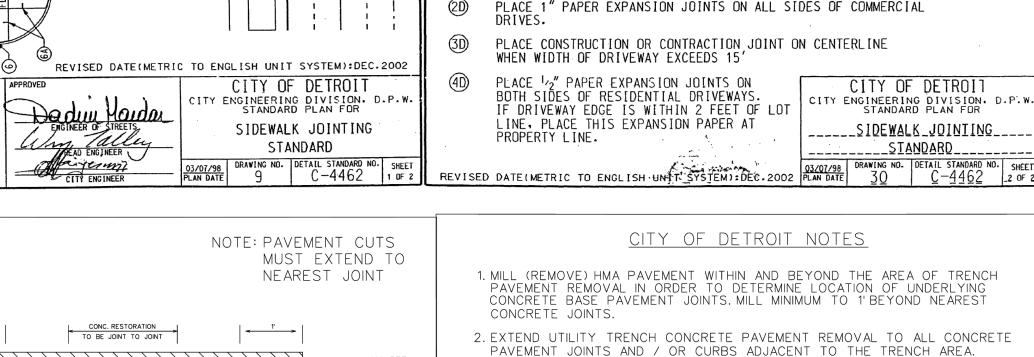

PLACE BITUMINOUS JOIN' SEALER AT ALL EDGES HMA, 5E3 ** - HMA, 4E3 ** CONCRETE BASE PLACE %" DIA. DOWEL HOOK BOLTS @ 36" C. TO C. * BOTTOM OF CONCRETE REPLACEMENT SHALL ♦ 1/2" CONCRETE BASE THICKNESS ** OR EQUIVALENT AS PER CURRENT MICHIGAN SPECIFICATION AS DETERMINED BY THE ENGINEER TO ABOVE 3" HMA REPLACEMENT. WHEN PAVEMENT REPLACEMENT IS 100 FEET FROM EITHER SIDE OF UNDERPASS REPLACE 10" MIN CONCRETE BASE WITH TOP OF CONCRETE LEVEL WITH TOP OF EXISTING CONCRETE AND REPLACE HMA SECTION AS EXISTING RESIDENTIAL STREETS:

DRAWN BY:

M.F.S.

CHECKED BY:

MAJOR STREETS

DESCRIPTION DRWN CHED APPD DATE
REVISIONS
DRAWN BY WLW CHECKED KSM

08/29/18

APPROVED SRB

- HMA, 13A *> REPLACE CONCRETE DEPTH EQUAL PLACE %" DIA. DOWEL HOOK BOLTS @ 36" C. TO C. — MAJOR STREET NOTE SHOWN -[X] SHALL APPLY ** OR EQUIVALENT AS PER CURRENT MICHIGAN

♦ ½" CONCRETE BASE THICKNESS DEPARTMENT OF TRANSPORTATION STANDARD SPECIFICATION AS DETERMINED BY THE ENGINEER ISOLATED CUT: TRIM JOINT TO OBTAIN VERTICAL CU HMA SURFACE ON

CONCRETE BASE

UTILITY TRENCH

CONSTRUCTION

PAVEMENT RESTORATION

CITY OF DETROIT CITY ENGINEERING DIVISION SURVEY BUREAU DRWG. NO. 1 OF 2

DESCRIPTION DRWN CHED APPD DATE REVISIONS
WN BY WLW CHECKED KSM 08/29/18 APPROVED SA

RELATED CONSTRUCTION.

TO STARTING CONSTRUCTION.


HMA SURFACE ON CONCRETE BASE **UTILITY TRENCH** CONSTRUCTION PAVEMENT RESTORATION


CITY ENGINEERING DIVISION SURVEY BUREAU DRWG. NO. 2 OF 2

15. ANY OPEN EXCAVATIONS ARE TO BE STEEL PLATED. IF EXCAVATIONS ARE IN THE PAVEMENT, THE PLATES ARE TO BE SPIKED AND RAMPED WITH COLD PATCH. CONTACT THE CITY WITH LOCATION OF THE STEEL PLATE. 16. THE CITY OF DETROIT REQUIRES ALL CONCRETE WORK TO BE STAMPED WITH A CONTRACTORS IDENTIFICATION STAMP. CITY OF DETROIT





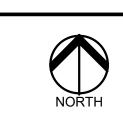

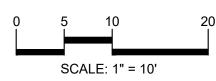



CAUTION!! TILITIES AS SHOWN ON THIS DRAWING ARE ONLY MPLIED AS TO THE COMPLETENESS OR ACCURACY THERE THE CONTRACTOR SHALL BE EXCLUSIVELY RESPONSIBLE FOR DETERMINING THE EXACT UTILITY LOCATIONS AND ELEVATIONS PRIOR TO THE START OF CONSTRUCTION.

6505 WOODWARD AVE., SUITE 201 DETROIT, MI

INTOTO STUDIO

PROJECT TITLE 3700 GILBERT RENOVATION

3700 GILBERT ST. DETROIT, WAYNE COUNTY, MI

REVISIONS

ORIGINAL ISSUE DATE: MAY 24, 2024

DRAWING TITLE **NOTES AND DETAILS**

24-0720 PEA JOB NO. ESB DN. XXXRDW DES.

DRAWING NUMBER:

