CAPITAL SECURITY PROJECT THEODORE LEVIN U.S. COURTHOUSE NEW RAMP

231 WEST LAFAYETTE DETROIT, MI 48226

AE# 1905-28

ARCHITECT G.H. FORBES ASSOCIATES 816 E. 4TH STREET ROYAL OAK, MI 48067

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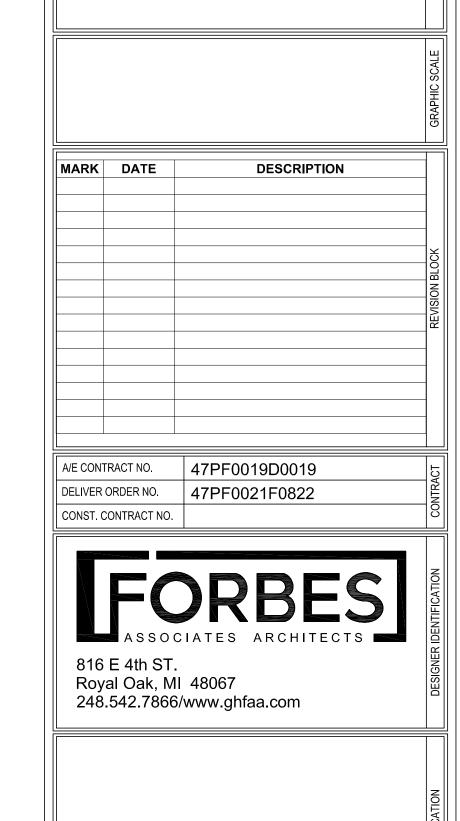
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AB	RK	KEV	/IA	Ш	IU	N	;

ADDITEVIATION	<u>5</u>	
A.B.	ANCHOR BOLTS	DN.
A.C.T.	ACOUSTICAL CEILING TILE	D.O.
	ADDITIONAL	D.O. DN.
ADDN.	, , , , , , , , , , , , , , , , , , , ,	DIN. D.S.
ADJ.	ADJACENT	
A.F.F.	ABOVE FINISHED FLOOR	DWG.
A.F.G.	ABOVE FINISHED GRADE	DWL.
A.H.J.	AUTHORITY HAVING JURISDICTION	EA.
A.H.U.	AIR HANDLING UNIT	E.J.
ALT.	ALTERNATE	EL.
ANCH.	ANCHOR	ELEC.
A.N.S.I.	AMERICAN NATIONAL	EMB.
	STANDARDS INSTITUTE	EQ.
A.P.	ACCESS PANEL	EQUIP.
APPROX.	APPROXIMATE	EQUIV.
ARCH.	ARCHITECT, ARCHITECTURAL	E.W.
A.S.T.M.	AMERICAN SOCIETY FOR	EXC.
,	TESTING MATERIALS	EXP.
B.A.S.	BUILDING AUTOMATION SYSTEM	EXP.B.
B/B	BACK TO BACK	(E)
B.C.	BOTTOM CHORD	EXIST.
B.E.	BOTTOM CHORD BOTTOM ELEVATION	EXT.
		F/F
BET.	BETWEEN	
B.F.	BARRIER FREE	F.D.
B.F.F	BELOW FINISHED FLOOR	FDN.
BLDG.	BUILDING	F.F.E.
BLK.	BLOCK	FIN.
BM.	BEAM	FL.
B.O.S.	BOTTOM OF STEAL	F.S.
BOTT.	BOTTOM	FT.
BRCG.	BRACING	FTG.
BRG.	BEARING	FUT.
BRKT.	BRACKET	GA.
BSMT.	BASEMENT	GALV.
BULL.	BULLETIN	G.C.
C.	CHANNEL OR CONDUIT	GEN.
C/C	CENTER TO CENTER	G.L.
CERT.	CERTIFIED	GRAT.
C.G.	CORNER GUARD	GRT.
CHKD. PL.	CHECKERED PLATE	GWB.
C.J.	CONSTRUCTION/CONTROL JOINT	H
C.L.	CENTER LINE	HGR.
CLG.	CEILING	H.A.
CLG. CLR.	CLEAR	HT.
CM.	CENTIMETER	HORIZ.
C.M.U.	CONCRETE MASONRY UNIT	H.P.
CNVR.	CONVEYOR	H.R.
		H.S.
COL.	COLUMN	
CONN.	CONNECT/CONNECTION	I.D.
CONSTR.	CONSTRUCTION	I.E.
CONT.	CONTINUATION/CONTINUOUS	IN.
CONTR.	CONTRACTOR	INCL.
COV.	COVER	INFO.
CTR.	CENTER	J.C.
DEG.	DEGREE	JT.
DEMO	DEMOLITION	K.B.
DET.	DETAIL	K.O.P.
D.H.	DOOR HEADER	K.P.
DIA.	DIAMETER	L.
DIAG.	DIAGONAL	LAD.
DIM.	DIMENSION	
D.J.	DOOR JAMB	

DOWN	LAM.	LAMINATE	RAD.
DOOR OPENING	LAV.	LAVATORY	R.C.P.
DOOR	LB.	POUND	R
DOWN SPOUT	LEV.	LEVEL	R.D.
DRAWING	L.F.	LINEAR FEET	RTU
DOWEL	LG.	LONG	REF.
EACH	LGTH.	LENGTH	REFL.
EXPANSION JOINT ELEVATION	L.H. L.J.	LOUVER HEAD LOUVER JAMB	REINF. REM.
ELECTRICAL	L.L.	LIVE LOAD	REQD.
EMBEDMENT	LLH	LONG LEG HORIZONTAL	R.R.
EQUAL	LLV	LONG LEG VERTICAL	RM.
EQUIPMENT	L.O.	LOUVER OPENING	SCHED.
EQUIVALENT	L.P.	LOW POINT	SECT.
EACH WAY	L.S.	LOUVER SILL	S.F.
EXCAVATED	LVR.	LOUVER	SGL.
EXPANSION EXPANSION BOLT	M MACH.	METER MACHINE	SHT. SIM.
EXPANSION BOLT EXISTING	MAINT.	MAINTENANCE	SIIVI. SP.
EXISTING	MAS.	MASONRY	SPEC
EXTERIOR	MAX.	MAXIMUM	SQ.
FACE TO FACE	MECH.	MECHANICAL	S.S.
FLOOR DRAIN	MET.	METAL	SSTL.
FOUNDATION	MEZZ.	MEZZANINE	STAGG.
FINISH FLOOR ELEVATION	MFR.	MANUFACTURER	STD.
FINISH, FINISHED FLOOR	M.I. MIN.	MISCELLANEOUS IRON MINIMUM	STIFF. STL.
FAR SIDE	MISC.	MISCELLANEOUS	STL. PL.
FEET	MM.	MILLIMETER	STRUCT
FOOTING	M.O.	MASONRY OPENING	SUPP.
FUTURE	M.R.A.C.T.	MOISTURE RESISTANT	SURF.
GAGE	M.T.	METRIC TON	SYM.
GALVANIZED	N.I.C.	NOT IN CONTRACT	T
GENERAL CONTRACTOR	NO. NOM.	NUMBER	T&B T.C.
GENERAL GIRT LINE	N.S.	NOMINAL NEAR SIDE	T.C. T/E
GRATING	N.T.S	NOT TO SCALE	TEMP.
GROUT	0/0	OUT TO OUT	THD.
GYPSUM WALL BOARD	O.D.	OUTSIDE DIAMETER	THK.
HIGH	OHD.	OVERHEAD	T.L.
HANGER	OPNG.	OPENING	T/M
HOLLOW METAL HEIGHT	OPP. OPP. HD.	OPPOSITE OPPOSITE HAND	T.O.F. T/STL.
HORIZONTAL	P-LAM	PLASTIC LAMINATE	1/31L. T/S
HIGH POINT	PAR.	PARALLEL	TYP.
HANDRAIL	PC.	PIECE	U/S
HIGH STRENGTH	P/C	PRECAST	U.N.O.
INSIDE DIAMETER	P.C.F.	POUNDS PER CUBIC FOOT	VERT.
INVERT ELEVATION	PEN.	PENETRATION	V.C.T.
INCHES	PH.	PHASE	W/
INCLUDE, INCLUDING INFORMATION	PL. PLWD.	PLATE PLYWOOD	W/O WD.
JANITOR'S CLOSET	PREFAB.	PREFABRICATION	W.H.
JOINT	PROJ.	PROJECT, PROJECTION	W.J.
KNEE BRACE	P.S.F.	POUNDS PER SQUARE FOOT	W O
KNOCK OUT PANEL	P.S.I.	POUNDS PER SQUARE INCH	WPT.
KICK PLATE	PT.	POINT	W.S.
LENGTH	QTY.	QUANTITY	WT.
LADDER			YD. ZC.
			۷٠.

RADIUS REFLECTED CEILING PLAN SIMILAR SPACE **SPECIFICATIONS SQUARE** STAINLESS STEEL STRUCTURAL STEEL STAGGERED STANDARD **STIFFENER** STEEL STEEL PLATE **STRUCTURAL** SUPPORT SURFACE SYMMETRICAL TREAD TOP AND BOTTOM TOP CHORD TOP OF EAVE OR PARAPET STEEL TEMPERATURE, TEMPORARY THREAD THICKNESS TOTAL LOAD TOP OF MASONRY TOP OF FOOTING TOP OF STEEL TOP OF SLAB TYPICAL UNDERSIDE **UNLESS NOTED OTHERWISE** VINYL COMPOSITE TILE WITH WITHOUT WOOD WINDOW HEAD WINDOW JAMB WINDOW OPENING **WORKING POINT** WATER STOP WEIGHT YARD ZINC COATED







BUILDING NAME	THEODORE LEVIN U.S. COURTHOUSE
ADDRESS	231 WEST LAFAYETTE
CITY, STATE, ZIP	Detroit, Michigan 48226
BUILDING NO.	MI0029ZZ
PROJECT TITLE	CAPITAL SECURITY
PROJECT TITLE	PROJECT
GSA PROJECT NO.	VMI00051
SUBMISSION STAGE	
SUBMISSION DATE	12/09/2022
DRAWN BY	SP
CHECKED BY	SWG
FLOOR NO.	
DISCIPLINE	ARCHITECTURAL
PLAN TYPE	COVER SHEET
SHEET NUMBER AND FILENAME	G 001

NATIONAL FIRE PROTECTION ASSOCIATION (NFPA) CODES, NFPA 101 - 2021, NFPA 13 - 2019, NFPA 72 - 2019, NFPA 70 - 2020 ASHRAE HANDBOOKS AND STANDARDS FOR HVAC, ASHRAE 90,1, 2019 ENERGY STANDARD SHEET METAL AND AIR CONDITIONING CONTRACTOR'S NATIONAL ASSOCIATION STANDARDS, 2019 ASHRAE/ANSI 135 BACnet: A DATA COMMUNICATION PROTOCOL FOR BUILDING AUTOMATION AND CONTROL NETWORKS, 2016 AMERICAN SOCIETY OF CIVIL ENGINEERS (ASCE 7 WITH SUPPLEMENT 1), 2016 AMERICAN SOCIETY OF CIVIL ENGINEERS SEISMIC EVALUATION OF EXISTING BUILDINGS (ASCE 31), 2003 AMERICAN SOCIETY OF CIVIL ENGINEERS SEISMIC EVALUATION OF EXISTING BUILDINGS (ASCE 41), 2017 AMERICAN INSTITUTE OF STEEL CONSTRUCTION DESIGN GUIDE 11 GUIDE 11 VIBRATIONS OF STEEL FRAMED STRUCTURAL SYSTEMS DUE TO HUMAN ACTIVITY. SECOND EDITION NATIONAL INSTITUTE OF STANDARDS AND TECHNOLOGY, STANDARDS OF SEISMIC SAFETY FOR EXISTING FEDERALLY OWNED AND LEASED BUILDINGS, ICSSC RECOMMENDED PRACTICE 8 (NIST GCD 11-917-12) ASME A17.1 SAFETY CODE FOR ELEVATORS AND ESCALATORS, 2019 ASME A18.1 SAFETY CODE FOR PLATFORM AND STAIRWAY CHAIR LIFTS, 2020 ARCHITECTURAL WOODWORK STANDARDS (AWS) SECOND EDITION, 2014 PBS-P100, 2018 ABAAS, AMERICANS WITH DISABILITIES ACT AND ARCHITECTURAL BARRIERS ACT ACCESSIBILITY STANDARDS, 2015 U.S. MARSHALS SERVICES (USMS) PUBLICATION 64, VOLUMES I AND II, 2014 AND VOLUME III, 2017 U.S. COURTS DESIGN GUIDE, 2007 WITH 2016 UPDATES ISC FACILITY SECURITY COMMITTEES STANDARD FOR RISK MANAGEMENT, 2021 CAPITAL SECURITY HANDBOOK, 2018 THEODORE LEVIN U.S. COURTHOUSE HISTORIC BUILDING PRESERVATION PLAN (HBPP), 1995, WITH ZONING UPDATE GSA P120 PBS COST ESTIMATING POLICY, 2017, WITH 2021 COST ESTIMATING WORKBOOK GSA PBS NATIONAL BUSINESS SPACE ASSIGNMENT POLICY, 2017 GSA BIM GUIDE (DATES VARY PER SECTIONS 1 THRU 8) FIRST IMPRESSIONS PROGRAM GUIDE, 2017 GSA DESIGN EXCELLENCE CITY OF DETROIT, DEPARTMENT OF PUBLIC WORKS, CITY ENGINEERING DIVISION, STREET AND ALLEY STANDARD PLANS, 2009 • CITY OF DETROIT, DEPARTMENT OF PUBLIC WORKS, CITY ENGINEERING DIVISION, STANDARD SPECIFICATIONS FOR PAVING AND RELATED CONSTRUCTION, 2009 SYMBOLS & ANNOTATIONS SYMBOL-BUILDING SECTION / WALL SECTION SYMBOL-COLUMN GRID JOINT COVER SEE SHEET A621 ■ DRAWING ID FOR SCHEDULE + DETAILS COLUMN CENTER LINE FIRE BARRIER SEE SHEET A621 FOR SCHEDULE + DETAILS COLUMN GRID NUMBER LOUVER TAG SYMBOL-EXTERIOR ELEVATION / INTERIOR ELEVATION SYMBOL-FINISHED FLOOR ELEVATION REFER TO THIS DRAWING ID Name 🌋 Elevation \ SYMBOL - GRAPHIC SCALE A601 A D **A** A601 SYMBOL-SPOT ELEVATION EXTERIOR INTERIOR INTERIOR ELEVATION ELEVATION ELEVATION SYMBOL - MACHINE SYMBOL-DETAIL CALLOUT SYMBOL-VIEW LABEL **REFER TO THIS** DRAWING ID [/] 1/8" = 1'-0" 、A101 / 1/8" = 1'-0" View Name $\frac{102}{100}$ A101/ $\frac{1}{8}$ " = 1'-0" **DIMENSION TYPES** SYMBOL-PROPERTY LINE TAG SYMBOL-ROOM TAG CENTER LINE ROOM IDENTIFICATION Room name N 90 00' 00" E ROOM NUMBER 150 SF ----- ROOM AREA RADIAL SYMBOL-WALL / DOOR / WINDOW SYMBOL-FIXTURE / FURNITURE / EQUIPMENT DIMENSION TYPE 1i LINEAR **ANGULAR** DIMENSION TYPE **DIMENSION** TYPE DOOR NUMBER SYMBOL-STAIR TAG SIGNAGE WINDOW 20R @ 7 1/2" SYMBOL-REVISIONS SYMBOL-CEILING TAG REVISION NUMBER 1i 1'-0" A.F.F. REVISED AREA

APPLICABLE CODES, REGULATIONS AND STANDARDS TO BE USED FOR CONSTRUCTION INCLUDE, BUT ARE NOT LIMITED TO:

INTERNATIONAL BUILDING CODE, 2021

INTERNATIONAL PLUMBING CODE, 2021

INTERNATIONAL FIRE CODE, 2021

NATIONAL ELECTRICAL CODE, 2020

INTERNATIONAL MECHANICAL CODE, 2021

INTERNATIONAL EXISTING ELECTRICAL CODE, 2021


INTERNATIONAL ENERGY CONSERVATION CODE, 2021

GENERAL CONSTRUCTION NOTES

- CONTRACTOR TO FIELD VERIFY ALL DIMENSIONS. ALL EXISTING CONDITIONS ARE TO BE FIELD VERIFIED BY THE G.C. AND ANY DISCREPANCIES BROUGHT TO THE ARCHITECTS ATTENTION.
- 2. PRIOR TO THE START OF CONSTRUCTION, CONTRACTOR TO VERIFY CONDITION OF EXISTING CONSTRUCTION. DOCUMENT ANY EXISTING CONDITION THAT COULD BE MISCONSTRUED AS DAMAGED DURING NEW CONSTRUCTION. NOTIFY THE GOVERNMENT OF EXISTING CONDITIONS IN WRITING PRIOR TO THE COMMENCEMENT OF WORK.
- 3. ALL PARTITIONS TO BE CONSTRUCTED OF NON COMBUSTIBLE MATERIALS IN ACCORDANCE WITH THE INTERNATIONAL BUILDING CODE, LATEST EDITION.
- 4. WHERE NEW CONSTRUCTION ABUTS EXISTING CONSTRUCTION AND APPEARS TO ALIGN FLUSH WITH EXISTING CONSTRUCTION, THE NEW CONSTRUCTION SHALL ALIGN AND BE FLUSH WITH NO VISIBLE JOINT.
- 5. DRAWINGS ARE NOT TO BE SCALED FOR ANY DIMENSIONS.
- 6. ALL WORK MUST COMPLY WITH THE DRAWINGS AND SPECIFICATIONS. ANY REVISIONS REQUIRED DUE TO FIELD CONDITIONS MUST BE REVIEWED AND APPROVED BY THE GSA CONTRACTING OFFICER PRIOR TO CONSTRUCTION.
- 7. PATCH AND REPAIR EXISTING WALLS, FLOORS AND COLUMNS THROUGHOUT TO ACHIEVE A SMOOTH AND BLEMISH FREE SURFACE SUITABLE FOR RECEIVING SPECIFIED FINISH. MODIFICATIONS AND/OR REPAIRS TO HISTORIC MATERIALS SHALL COMPLY WITH HISTORIC PRESERVATION REQUIREMENTS IN THE SPECIFICATIONS.
- 8. ALL ROUGH FRAMING WOOD (E.G. PLYWOOD ETC.) BEING INSTALLED SHALL BE TREATED WITH FIRE-RETARDANT CHEMICALS BY A PRESSURE-IMPREGNATION PROCESS OR OTHER METHODS WHICH TREAT THE MATERIAL THROUGHOUT (AS OPPOSED TO A SURFACE TREATMENT) TO MAKE IT FIRE SAFE.
- 9. 'EXIT' SIGNAGE AND EMERGENCY LIGHTING SHALL MEET THE REQUIREMENTS OF NFPA, LIFE SAFETY CODE, LATEST EDITION
- 10. ALL CONDUIT AND PIPE PENETRATIONS IN WALLS SHALL BE SEALED. ALL PENETRATIONS IN FIRE RATED WALLS AND IN ALL FLOORS SHALL BE FIRE STOPPED. PROVIDE FLOOR-TO-FLOOR FIRESTOPPING AT ANY VERTICAL PIPING OR CONDUIT PENETRATIONS, WHICH ARE EXPOSED IN THE COURSE OF THIS RENOVATION WORK.
- 11. RELOCATE CONDUITS, SPRINKLERS LINES, ETC. TO ACCOMMODATE LIGHT FIXTURES, HVAC ACCESSORIES AND VARIOUS DEVICES. THE CMC CONTRACTOR SHALL FIELD VERIFY THE PROPOSED LOCATIONS FOR NEW EQUIPMENT AND SHALL INCLUDE ALL COSTS ASSOCIATED WITH RELOCATING EXITING EQUIPMENT IN THEIR PROPOSAL(S).
- 12. PROVIDE ADDITIONAL WIRING, CONDUIT AND ACCESSORIES FOR DEVICES TO BE RELOCATED.
- 13. ALL WALL MOUNTED DEVICES SHALL BE FULLY CONCEALED EXCEPT WHERE MOUNTED ON EXISTING WALLS. U.N.O.
- 14. PROVIDE ESCUTCHEONS FOR ALL VISIBLE FLOOR AND WALL PENETRATIONS.
- 15. ALL FIRE SPRINKLER SYSTEM MODIFICATION SHALL BE IN ACCORDANCE WITH NFPA STANDARD NO.13, STANDARD FOR THE INSTALLATION OF SPRINKLER SYSTEMS. LATEST EDITION.
- 16. ALL SPRINKLER EQUIPMENT (E.G. PIPING, SPRINKLERS, ETC.)
 OUTSIDE THE AREA BEING RENOVATED SHALL REMAIN ACTIVE AT ALL TIMES (EXCEPT FOR CAPPING THE MAIN PIPE OR PIPES THAT FEED THE AREA TO BE RENOVATED). THE WORK SHALL BE RESTORED TO A FULLY OPERATING CONDITION PRIOR TO THE CONTRACTOR LEAVING THE WORK SITE EACH DAY. ALL SPRINKLER EQUIPMENT IN THE RENOVATED SPACE CAN BE TAKEN OUT OF SERVICE WHILE WORK IS BEING ACCOMPLISHED EACH DAY, BUT SHALL BE RESTORED TO FULLY OPERATION BEFORE THE CONTRACTOR VACATES THE WORK SITE EACH DAY.
- 17. ALL FIRE ALARM SYSTEM MODIFICATIONS SHALL BE IN ACCORDANCE WITH NFPA STANDARD NO.72, NATIONAL FIRE ALARM CODE, LATEST EDITION. EXISTING FIRE ALARM EQUIPMENT IN RENOVATED SPACE AND ADJACENT SPACES SHALL REMAIN FULLY OPERATIONAL THROUGHOUT CONSTRUCTION.
- 18. ALL NOISY AND/OR DISRUPTIVE WORK IS TO BE PERFORMED AFTER HOURS.
- 19. THE CONTRACTOR WILL BE RESPONSIBLE FOR COORDINATING ALL WORK WITH SECURITY AND ALL GSA SUBCONTRACTORS.
- 20. THE TERM "CONTRACT LIMITS" IS INTENDED ONLY TO PROVIDE A GENERAL AREA OF WHERE THE WORK IS TO OCCUR. WORK, AS DESCRIBED IN THE DOCUMENTS, WILL NEED TO OCCUR OUTSIDE OF THE CONTRACT LIMITS FOR A COMPLETE PROJECT.
- 21. ALL ELEVATOR HALL FIXTURES ARE TO BE FLUSH MOUNT. NO EXTERNAL BOXES ARE TO BE USED.
- 22. CONTRACTOR IS RESPONSIBLE TO PROVIDE ALL PERMITS REQUIRED FOR NEW WORK OUTSIDE OF THE BUILDING. COORDINATE WITH THE CITY OF DETROIT AS REQUIRED.
- 23. THE LEVIN U.S. COURTHOUSE IS LISTED ON THE NATIONAL REGISTER OF HISTORIC PLACES. SECTION 106 OF THE NATIONAL PRESERVATION ACT APPLIES AND THE SECRETARY OF THE INTERIOR'S STANDARDS FOR THE TREATMENT OF HISTORIC PROPERTIES MUST BE COMPLIED WITH. SEE ALSO SECTION 01 35 10 HISTORIC BUILDING TREATMENT PROCEDURES OF THE SPECIFICATIONS.

GENERAL DEMOLITION NOTES

- CONTRACTOR TO FIELD VERIFY ALL DIMENSIONS.
- 2. PRIOR TO THE START OF CONSTRUCTION, CONTRACTOR TO VERIFY CONDITION OF EXISTING CONSTRUCTION. DOCUMENT ANY EXISTING CONDITION THAT COULD BE MISCONSTRUED AS DAMAGED DURING NEW CONSTRUCTION. NOTIFY THE GOVERNMENT OF EXISTING CONDITIONS IN WRITING PRIOR TO THE COMMENCEMENT OF WORK.
- 3. CONFIRM USAGE OF EXISTING POWER WIRING PRIOR TO REMOVAL TO VERIFY THAT THE WIRING DOES NOT POWER OTHER DEVICES OUTSIDE OF THE CONTRACT LIMITS.
- 4. PATCH & REPAIR FLOOR SLAB AND WALLS AS REQUIRED TO PROVIDE A SMOOTH, EVEN FINISH SUITABLE FOR THE APPLICATION OF SPECIFIED FINISHES. WHERE ELECTRICAL DEVICES ARE TO BE REMOVED FROM COLUMNS OR WALLS, REMOVE WIRING TO SOURCE. PATCH WALL WHERE DEVICES ARE REMOVED. MODIFICATIONS AND/OR REPAIRS TO HISTORIC MATERIALS SHALL COMPLY WITH HISTORIC PRESERVATION REQUIREMENTS IN THE SPECIFICATIONS.
- ITEMS TO BE RELOCATED SHALL BE REMOVED, STORED, CLEANED AND REINSTALLED BY THE CONTRACTOR. COORDINATE WITH SPECIFICATIONS.
- 6. GOVERNMENT SHALL OCCUPY THE BUILDING OUTSIDE OF THE CONTRACT LIMITS DURING CONSTRUCTION. COORDINATE DEMOLITION EFFORTS WITH THE GOVERNMENT TO MINIMIZE DISTURBANCES.
- 7. ITEMS NOTED AS BEING REMOVED SHALL BE DISPOSED OF BY THE CONTRACTOR U.N.O.
- 8. COORDINATE DEMOLITION WITH MECHANICAL AND ELECTRICAL DRAWINGS.
- 9. LIGHT FIXTURES TO BE REMOVED SHALL INCLUDE ASSOCIATED WIRING, CONDUITS AND BOXES.
 COORDINATE WITH ADJACENT OFFICE SPACES SUCH THAT THEIR LIGHT FIXTURES REMAIN OPERATIONAL.
- 10. THE TERM "CONTRACT LIMITS" IS INTENDED ONLY TO PROVIDE A GENERAL AREA OF WHERE THE WORK IS TO OCCUR. WORK AS DESCRIBED IN THE DOCUMENTS, WILL NEED TO OCCUR OUTSIDE OF THE CONTRACT LIMITS FOR A COMPLETE PROJECT.
- 11. PATCH AND REPAIR WHERE EXISTING ITEMS (I.E. PLUMBING/MECHANICAL FIXTURES, RECEPTACLES) ARE TO BE REMOVED FROM WALLS OR FLOORS. MODIFICATIONS AND/OR REPAIRS TO HISTORIC MATERIALS SHALL COMPLY WITH HISTORIC PRESERVATION REQUIREMENTS IN THE SPECIFICATIONS. COORDINATE WITH MECHANICAL AND ELECTRICAL DRAWINGS.
- 12. MODIFY THE EXISTING WET PIPE SPRINKLER AND FIRE ALARM SYSTEMS. MAINTAIN THESE SYSTEMS AS FULLY OPERATIONAL FOR THE ADJACENT OCCUPIED SPACES.
- 13. MAINTAIN ALL PATHS OF EGRESS FROM CONSTRUCTION SPACE AND FROM ADJACENT OCCUPIED SPACES CLEAR OF DEBRIS. MATERIALS AND EQUIPMENT.
- 14. SEE TITLE SHEET FOR ABBREVIATIONS.
- 15. WHERE CEILINGS ARE REMOVED, THE EXISTING SPRINKLERS MUST BE REPLACED AS UPRIGHT SPRINKLERS AND THEIR ASSOCIATED ARMOVER/SPRIG-UP'S, ETC. MUST BE MODIFIED TO PROVIDE THE NEW TEMPORARY UPRIGHT SPRINKLERS AND THEIR ASSOCIATED DEFLECTOR TO BE PROVIDED WITHIN 12" OF STRUCTURE OR CEILING ABOVE. ONCE THE NEW SUSPENDED CEILING HAS BEEN PROVIDED THE SPRINKLER CONTRACTOR CAN REMOVE THE EXISTING TEMPORARY UPRIGHT SPRINKLERS.
- 16. HAZARDOUS MATERIALS ARE PRESENT THROUGHOUT THE PROJECT AREA. THE CONTRACTOR SHALL FOLLOW LEAD PAINT REMEDIATION INSTRUCTION PER SPECIFICATION 02 83 00 AND ABATE ASBESTOS PER SPECIFICATION 02 82 00.
- 17. CONTRACTOR TO PROVIDE TEMPORARY BARRIERS AS REQUIRED FOR WORK. REFER TO SPECIFICATIONS FOR BASIS OF DESIGN PRODUCT.
 - THE CONSTRUCTION DOCUMENTS INCLUDE TERMS SUCH AS "REFER TO", "COORDINATE WITH", "SEE DRAWING/SPEC...", ETC. AS A MEANS TO DRAW ATTENTION TO SPECIFIC ITEMS WHICH NEED TO BE CROSS REFERENCED BETWEEN THE VARIOUS DOCUMENTS. THIS IS DONE GENERALLY AS A CONVENIENCE TO THE CONTRACTOR TO HELP FACILITATE THEIR REVIEW OF THE REQUIREMENTS. THE DESIGNER OF RECORD AND/OR OWNER DO NOT INTEND TO USE THESE TERMS IN EVERY OCCASION WHERE SUCH COORDINATION IS REQUIRED. IT IS THE CONTRACTOR'S RESPONSIBILITY TO PROPERLY COORDINATE ALL OF THE REQUIREMENTS LISTED IN THE CONTRACT DOCUMENTS WHETHER OR NOT THE TERMS "REFER TO", "COORDINATE WITH", "SEE DRAWING/SPEC..." ARE LISTED.
- THE LEVIN U.S. COURTHOUSE IS LISTED ON THE NATIONAL REGISTER OF HISTORIC PLACES. SECTION 106 OF THE NATIONAL PRESERVATION ACT APPLIES AND THE SECRETARY OF THE INTERIOR'S STANDARDS FOR THE TREATMENT OF HISTORIC PROPERTIES MUST BE COMPLIED WITH. SEE ALSO SECTION 01 35 10 HISTORIC BUILDING TREATMENT PROCEDURES OF THE SPECIFICATIONS.

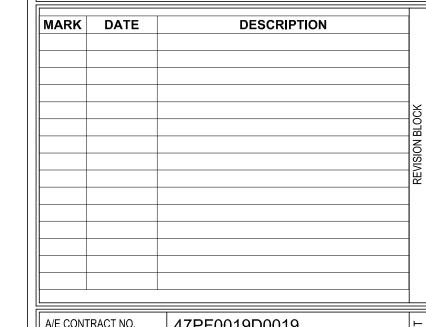

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	DELIVER ORDER NO.	47PF0021F0822
	CONST. CONTRACT NO.	
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816 E 4th ST. Royal Oak, MI 48067 248.542.7866/www.ghfaa.com





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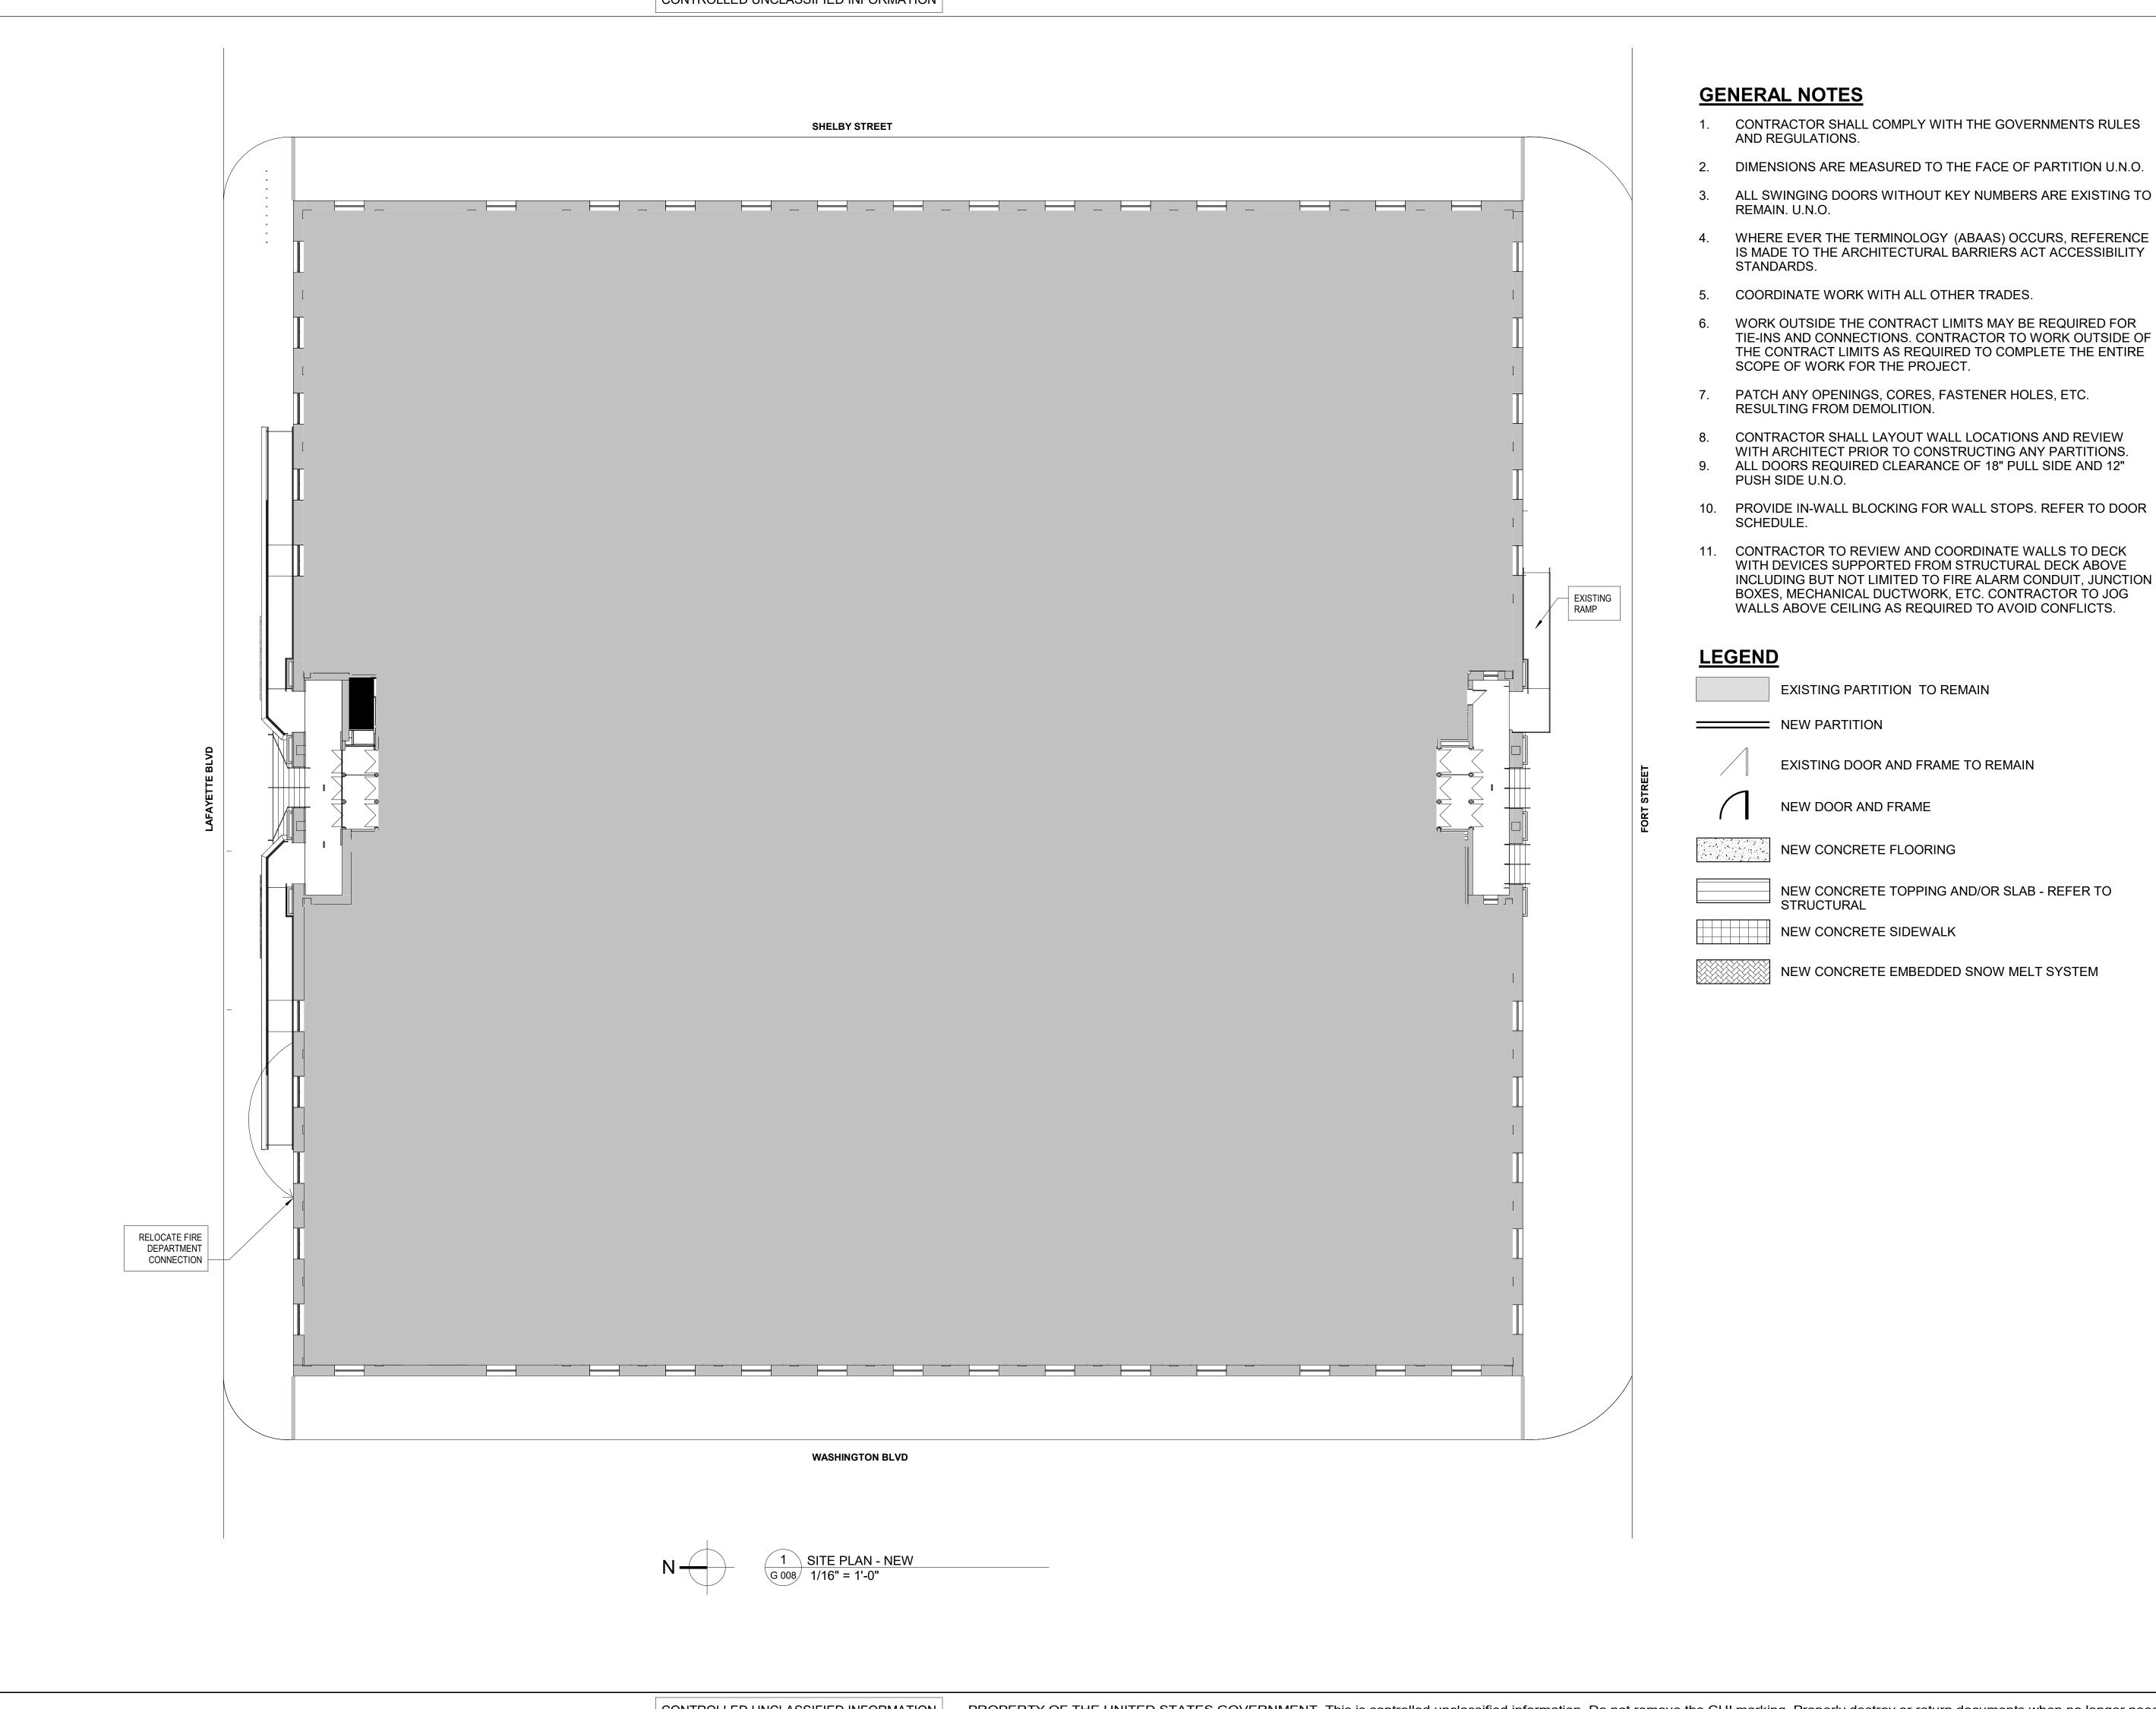
General Services Administration
Public Buildings Service
Great Lakes

THEODORE LEVIN U.S. COURTHOUSE

Customer Projects Service Center John C. Kluczynski Federal Building 230 South Dearborn St. Room 3500 Chicago, IL 60604


ADDRESS	231 WEST LAFAYETTE	ၜႍ
CITY, STATE, ZIP	Detroit, Michigan 48226	BUILDING
BUILDING NO.	MI0029ZZ	<u></u>
PROJECT TITLE	CAPITAL SECURITY	
PROJECT TITLE	PROJECT	
GSA PROJECT NO.	VMI00051	PROJECT
SUBMISSION STAGE		8
SUBMISSION DATE	12/09/2022	
DRAWN BY	SP	
CHECKED BY	SWG	
FLOOR NO.		
DISCIPLINE	ARCHITECTURAL	SEET
PLAN TYPE	GENERAL NOTES & SYMBOLS]တ်

G 002



- IS MADE TO THE ARCHITECTURAL BARRIERS ACT ACCESSIBILITY
- WORK OUTSIDE THE CONTRACT LIMITS MAY BE REQUIRED FOR TIE-INS AND CONNECTIONS. CONTRACTOR TO WORK OUTSIDE OF THE CONTRACT LIMITS AS REQUIRED TO COMPLETE THE ENTIRE

- WITH DEVICES SUPPORTED FROM STRUCTURAL DECK ABOVE INCLUDING BUT NOT LIMITED TO FIRE ALARM CONDUIT, JUNCTION BOXES, MECHANICAL DUCTWORK, ETC. CONTRACTOR TO JOG

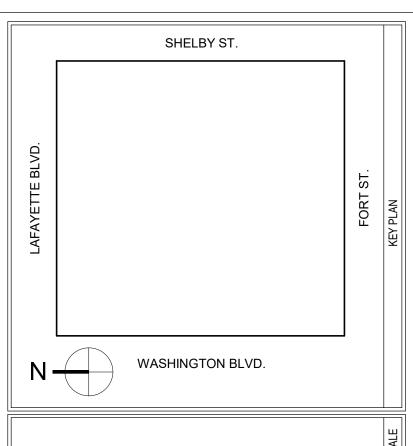


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DELIVER ORDER NO.	47PF0021F0822) OTIV
CONST. CONTRACT NO.		5
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Royal Oak, MI 48067 248.542.7866/www.ghfaa.com







Public Buildings Service Great Lakes ∣ ∈ Customer Projects Service Center John C. Kluczynski Federal Building

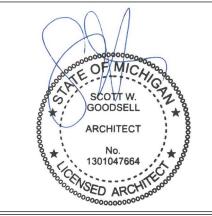General Services Administration

230 South Dearborn St. Room 3500 Chicago, IL 60604

BUILDING NAME	THEODORE LEVIN U.S. COURTHOUSE	
ADDRESS	231 WEST LAFAYETTE] _
CITY, STATE, ZIP	Detroit, Michigan 48226	BI III DING
BUILDING NO.	MI0029ZZ	<u>~</u>
DDO IFOT TITLE	CAPITAL SECURITY	T
PROJECT TITLE	PROJECT	
GSA PROJECT NO.	VMI00051	PRO IFCT
SUBMISSION STAGE		PRO
SUBMISSION DATE	12/09/2022	
DRAWN BY	SP	T
CHECKED BY	SWG	
FLOOR NO.		
DISCIPLINE	ARCHITECTURAL	745
PLAN TYPE	SITE PLAN] <i>t</i> .
SHEET NUMBER AND FILENAME	G 003	

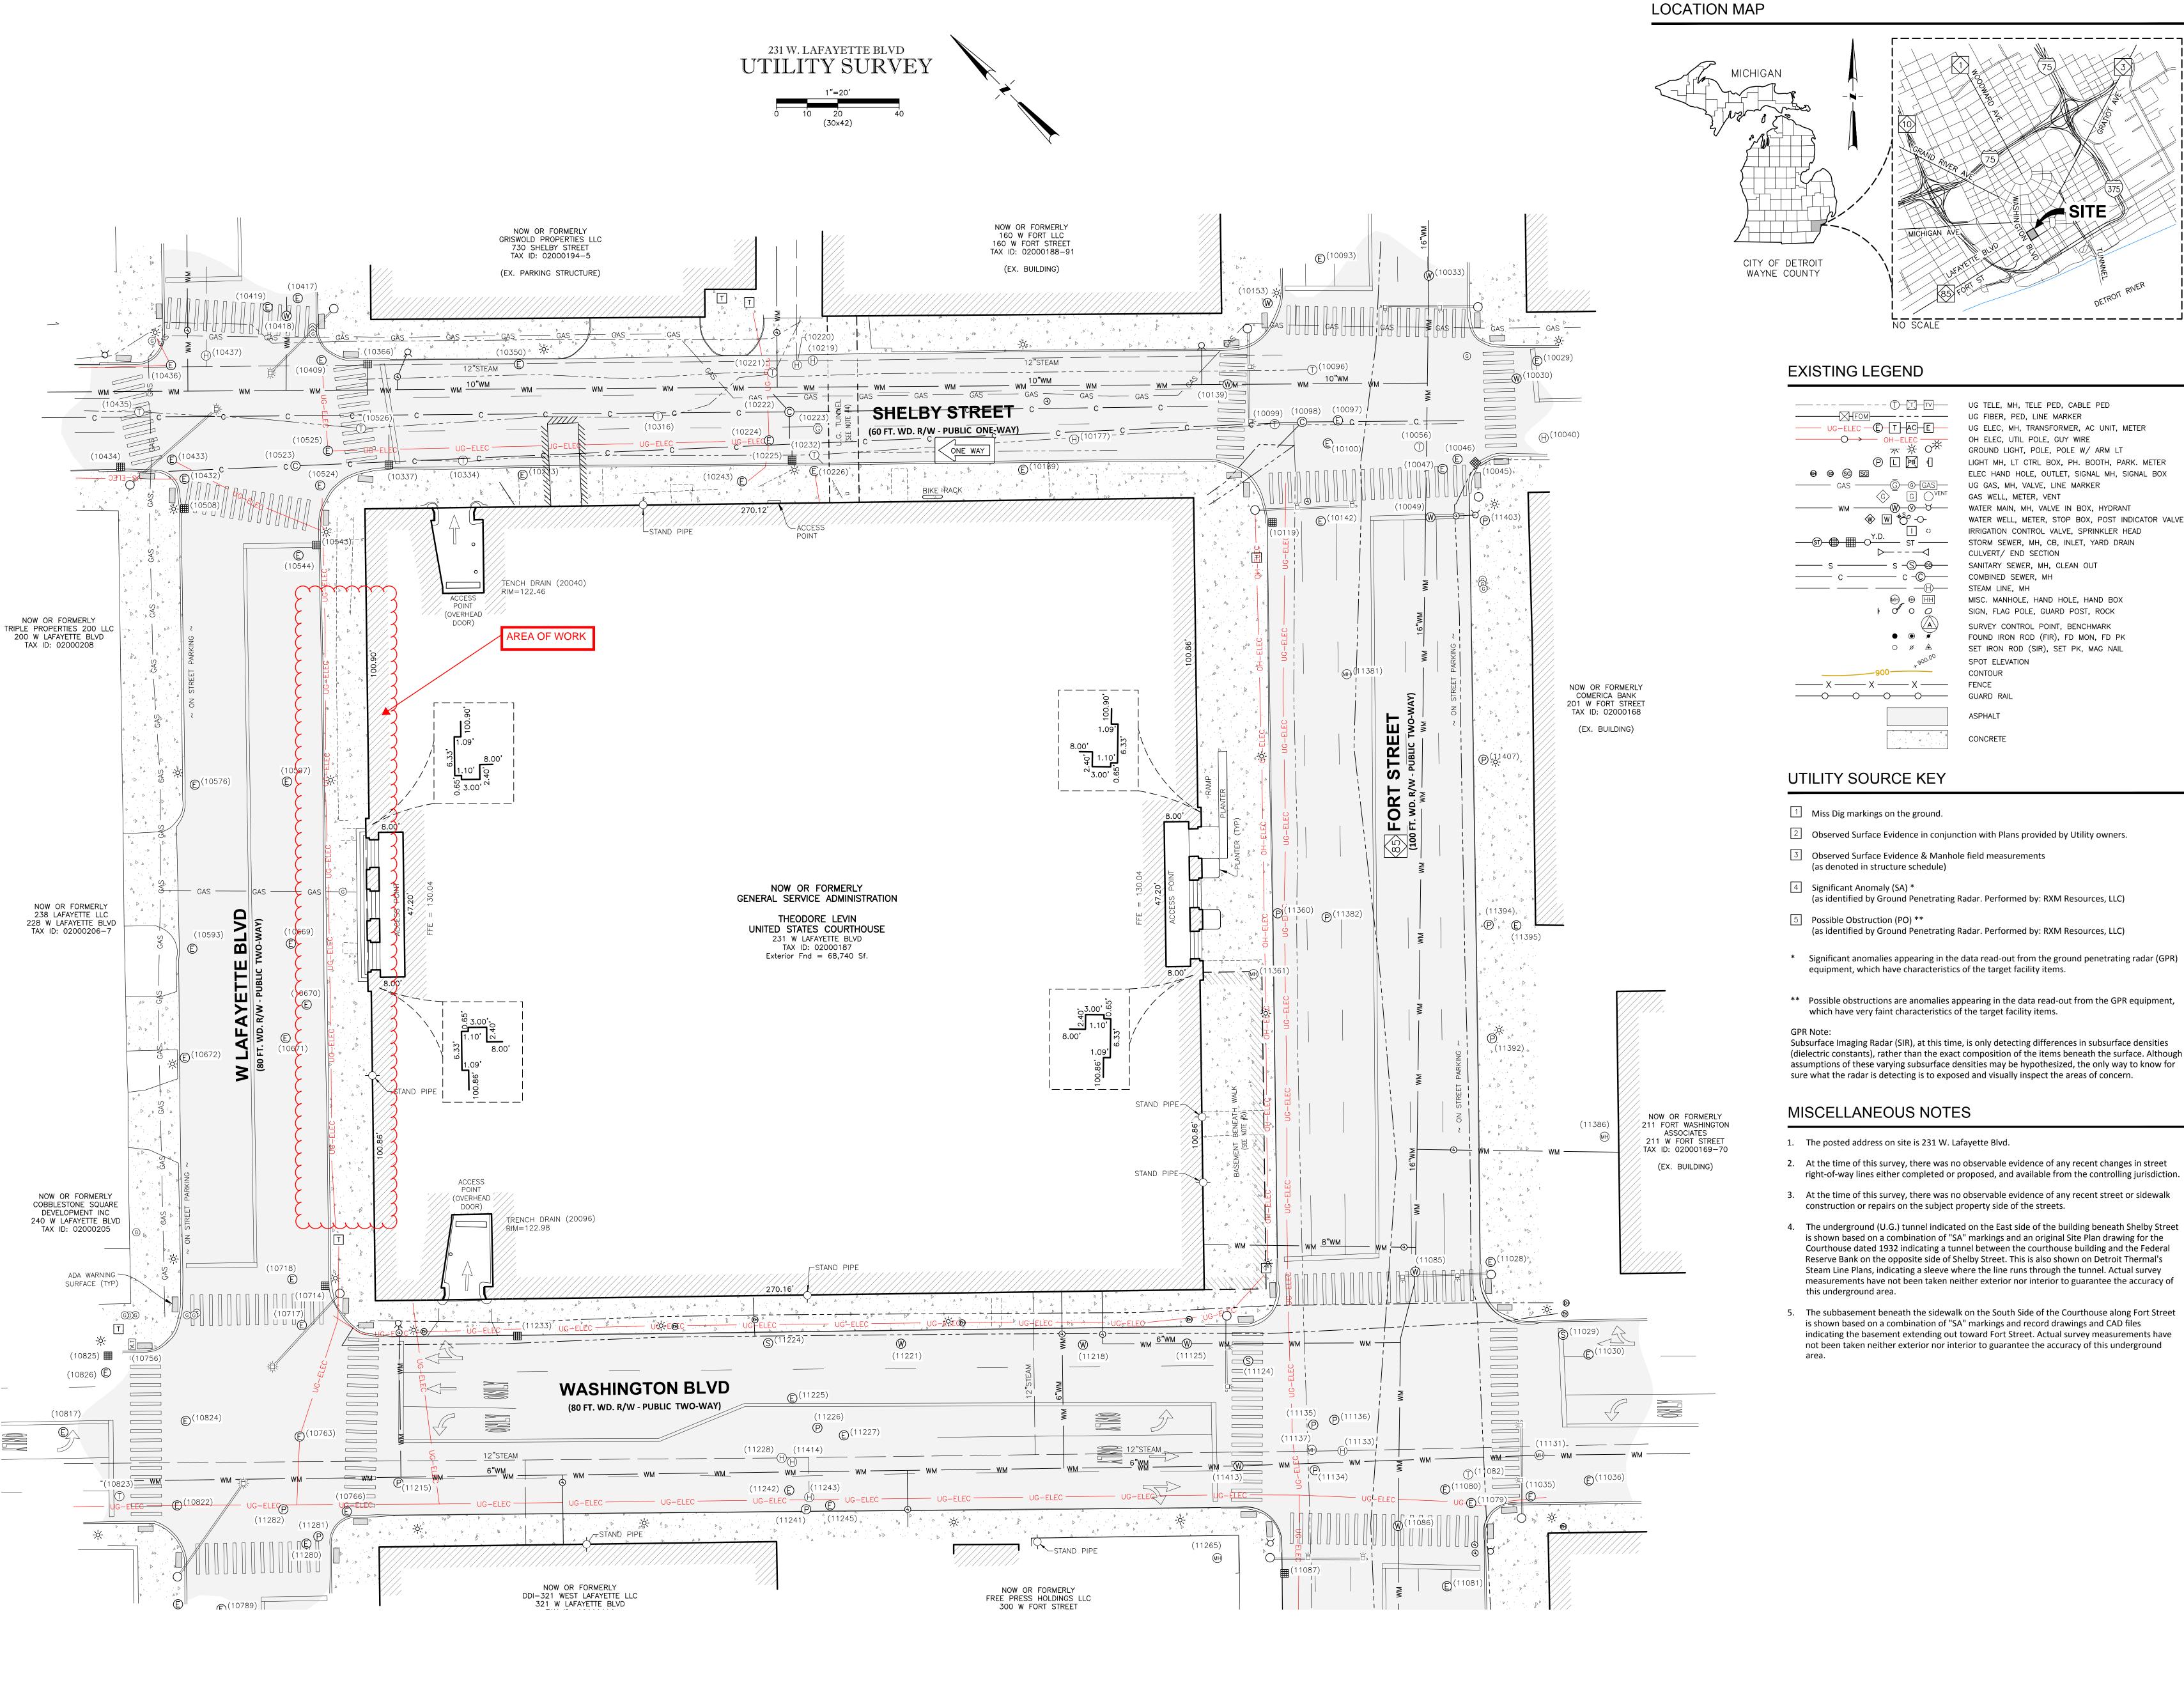

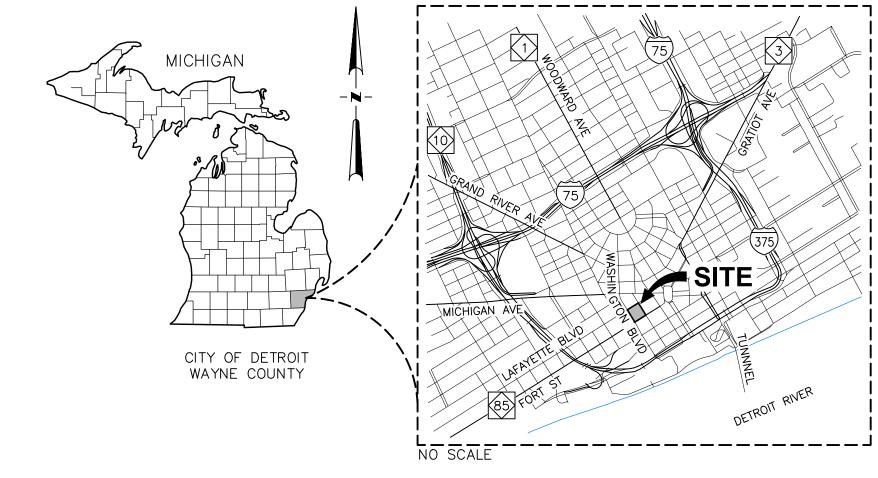

EXISTING LEGEND


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P L [14] {] (8) (8) (9)	LIGHT MH, LT CTRL BOX, PH. BOOTH, PARK. METER ELEC HAND HOLE, OUTLET, SIGNAL MH, SIGNAL BOX
——— GAS ————————————————————————————————	UG GAS, MH, VALVE, LINE MARKER
G G OVENT	GAS WELL, METER, VENT
wm	WATER MAIN, MH, VALVE IN BOX, HYDRANT
	WATER WELL, METER, STOP BOX, POST INDICATOR VALV
—————————————————————————————————————	IRRIGATION CONTROL VALVE, SPRINKLER HEAD STORM SEWER, MH, CB, INLET, YARD DRAIN CULVERT/ END SECTION
—— s ——— s ———	SANITARY SEWER, MH, CLEAN OUT
c c _©	COMBINED SEWER, MH
	STEAM LINE, MH
MH HH	MISC. MANHOLE, HAND HOLE, HAND BOX
1000	SIGN, FLAG POLE, GUARD POST, ROCK
- (A)	SURVEY CONTROL POINT, BENCHMARK
• • <i>*</i>	FOUND IRON ROD (FIR), FD MON, FD PK
	SET IRON ROD (SIR), SET PK, MAG NAIL
900.00	SPOT ELEVATION
XXX	CONTOUR FENCE
	GUARD RAIL
	ASPHALT
	CONCRETE

UTILITY SOURCE KEY


- 1 Miss Dig markings on the ground.
- Observed Surface Evidence in conjunction with Plans provided by Utility owners.
- 3 Observed Surface Evidence & Manhole field measurements (as denoted in structure schedule)
- 4 Significant Anomaly (SA) *
- (as identified by Ground Penetrating Radar. Performed by: RXM Resources, LLC)
- 5 Possible Obstruction (PO) ** (as identified by Ground Penetrating Radar. Performed by: RXM Resources, LLC)
- * Significant anomalies appearing in the data read-out from the ground penetrating radar (GPR) equipment, which have characteristics of the target facility items.
- ** Possible obstructions are anomalies appearing in the data read-out from the GPR equipment, which have very faint characteristics of the target facility items.
- Subsurface Imaging Radar (SIR), at this time, is only detecting differences in subsurface densities (dielectric constants), rather than the exact composition of the items beneath the surface. Although

sure what the radar is detecting is to exposed and visually inspect the areas of concern.

- 1. The posted address on site is 231 W. Lafayette Blvd.
- 2. At the time of this survey, there was no observable evidence of any recent changes in street right-of-way lines either completed or proposed, and available from the controlling jurisdiction.
- 3. At the time of this survey, there was no observable evidence of any recent street or sidewalk construction or repairs on the subject property side of the streets.
- 4. The underground (U.G.) tunnel indicated on the East side of the building beneath Shelby Street is shown based on a combination of "SA" markings and an original Site Plan drawing for the Courthouse dated 1932 indicating a tunnel between the courthouse building and the Federal Reserve Bank on the opposite side of Shelby Street. This is also shown on Detroit Thermal's Steam Line Plans, indicating a sleeve where the line runs through the tunnel. Actual survey measurements have not been taken neither exterior nor interior to guarantee the accuracy of this underground area.
- 5. The subbasement beneath the sidewalk on the South Side of the Courthouse along Fort Street is shown based on a combination of "SA" markings and record drawings and CAD files indicating the basement extending out toward Fort Street. Actual survey measurements have not been taken neither exterior nor interior to guarantee the accuracy of this underground

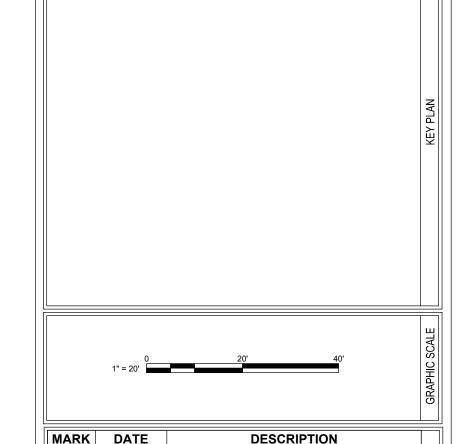

MARK	DATE	DESCRIPTION

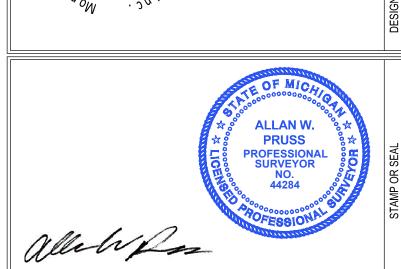

638 SOUTH GRAND AVE. FOWLERVILLE,

MICHIGAN 48836

(OFFICE) 517-223-3512

(FAX) 517-223-9987

GS-05P-14-SV-C-0056

ENGINEERS · SURVEYORS · CONSULTANTS · LANDSCAPE

ARCHITECTS · LAND PLANNERS

General Services Administration Public Buildings Service

Professional Services Division John C. Kluczynski Federal Building 230 South Dearborn St. Chicago, IL 60604

A/E CONTRACT NO.

DELIVER ORDER NO.


CONST. CONTRACT NO.


CITY, STATE, ZIP	Detroit, Michigan 48226
BUILDING NO.	MI0029ZZ
PROJECT TITLE	Theodore Levin US Courthouse
	Prospectus Alteration
GSA PROJECT NO.	GS-05P-14-SV-C-0056
SUBMISSION STAGE	
SUBMISSION DATE	7-22-16
DRAWN BY	

BUILDING NAME Theodore Levin US Courthouse

231 West Lafayette Blvd

CHECKED BY FLOOR NO. DISCIPLINE PLAN TYPE **REF V101** AND FILENAME

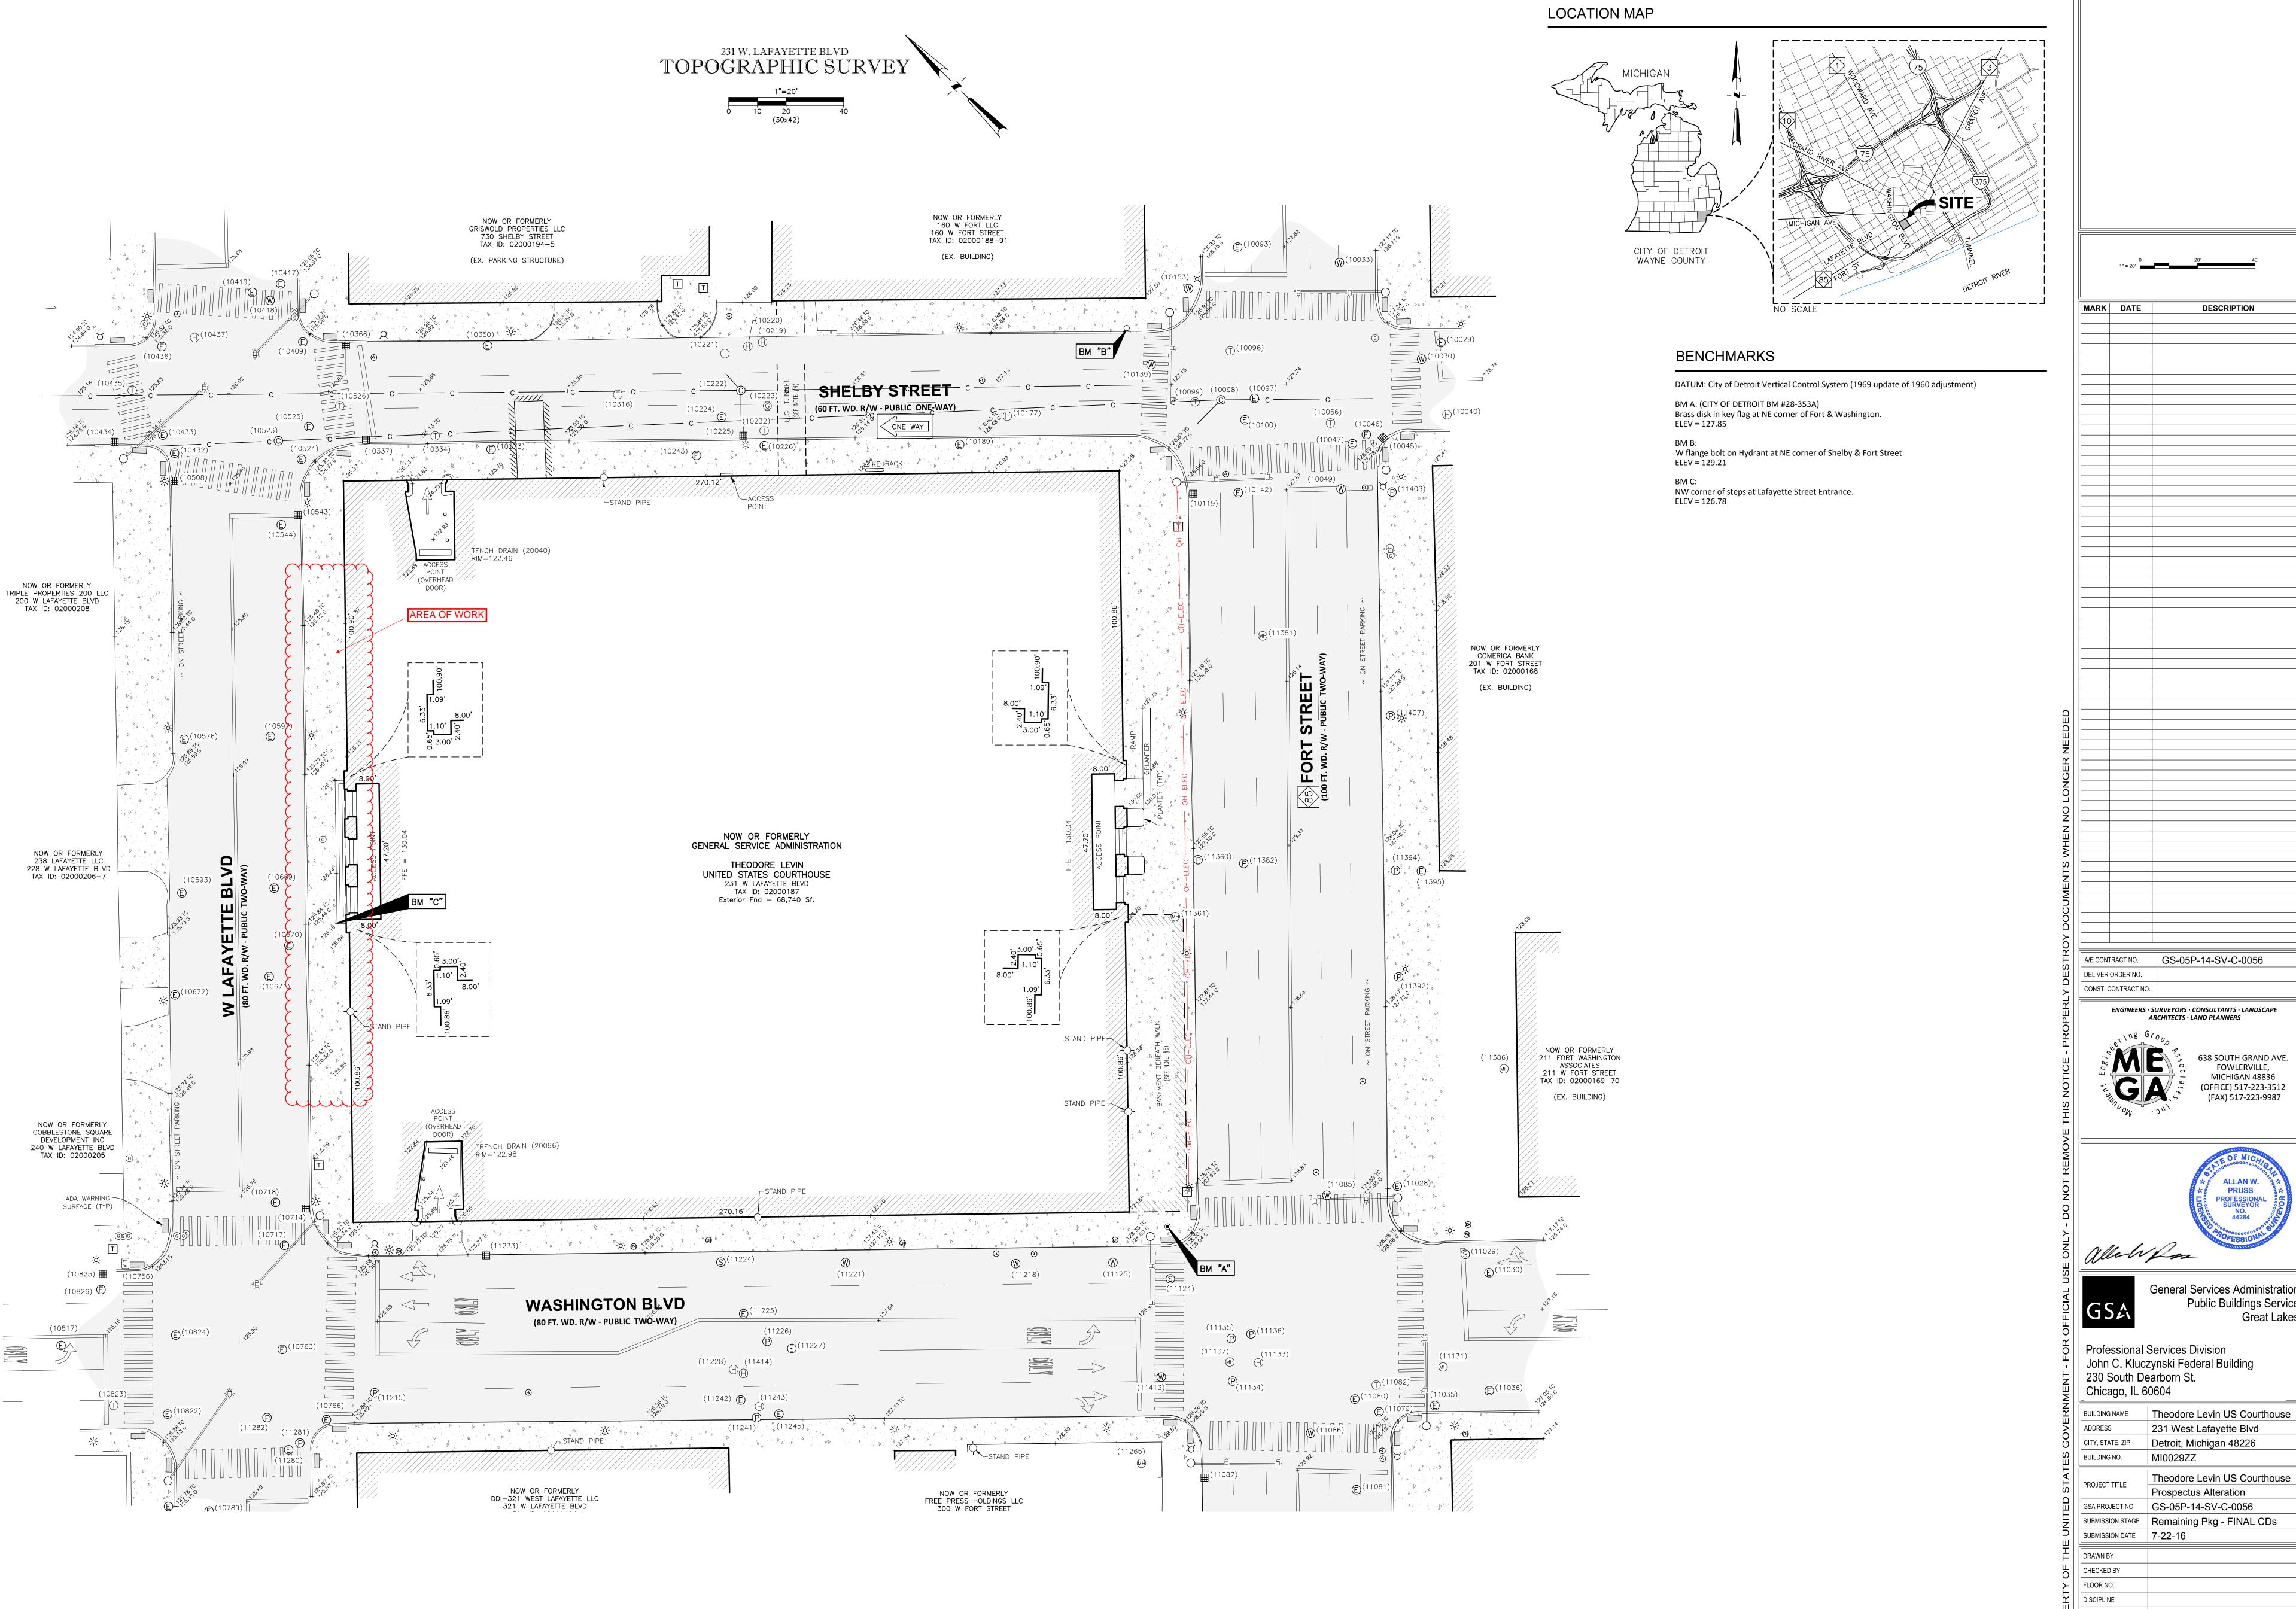

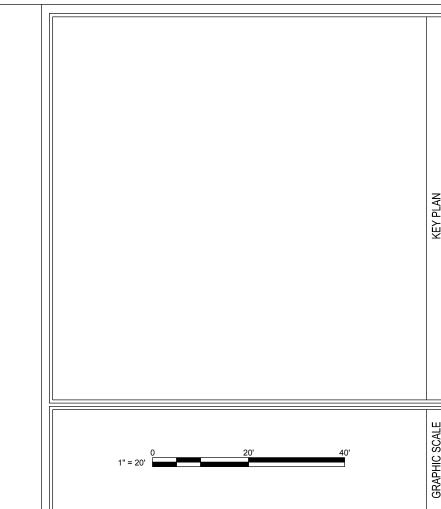


MARK	DATE	DESCRIPTION

CONST. CONTRACT NO. ENGINEERS · SURVEYORS · CONSULTANTS · LANDSCAPE ARCHITECTS · LAND PLANNERS



638 SOUTH GRAND AVE. FOWLERVILLE, MICHIGAN 48836 (OFFICE) 517-223-3512 (FAX) 517-223-9987

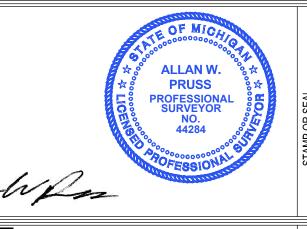


General Services Administration Public Buildings Service


Professional Services Division John C. Kluczynski Federal Building 230 South Dearborn St. Chicago, IL 60604

) K	ADDRESS	231 West Lafayette Blvd
9	CITY, STATE, ZIP	Detroit, Michigan 48226
ES	BUILDING NO.	MI0029ZZ
STAT	PROJECT TITLE	Theodore Levin US Courthouse
		Prospectus Alteration
	GSA PROJECT NO.	GS-05P-14-SV-C-0056
ENO	SUBMISSION STAGE	Remaining Pkg - FINAL CDs
	SUBMISSION DATE	7-22-16
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П	CHECKED BY		
<u>></u>	FLOOR NO.		
띮	DISCIPLINE		SHEET
PE	PLAN TYPE		ਲ
PRC	SHEET NUMBER AND FILENAME	REF V102	

KEYED NOTES DESCRIPTION NUMBER REMOVE AND PROTECT (1) GRANITE PANEL WITH FIRE DEPARTMENT CONNECTION INSET. STORE, SALVAGE AND CLEAN PANEL FOR REINSTALLATION. REMOVE AND RELOCATE FIRE DEPARTMENT CONNECTION AS REQUIRED FOR NEW WORK. REFER TO FIRE SUPPRESSION DRAWINGS. REMOVE EXISTING PLANTERS AS REQUIRED FOR NEW WORK, TYP. OF 6. COORDINATE WITH OWNER. REMOVE AND RESET EXISTING GRANITE CURB ON EXISTING CONCRETE CURB FOUNDATION. REMOVE AND PROTECT (1) GRANITE PANEL AS REQUIRED FOR RELOCATION OF FIRE DEPARTMENT CONNECTION. STORE, SALVAGE AND CLEAN PANEL FOR REINSTALLATION. REFER TO ELEVATIONS AND NEW WORK PLANS. 112 EXISTING SIGN AND POST TO REMAIN PROTECT EXISTING EXTERIOR GRANITE/STONE COLUMNS TO REMAIN. PROVIDE HARD PROTECTION AS REQUIRED DURING CONSTRUCTION. REMOVE EXISTING SIDEWALK TO BUILDING CORNERS. A TEMPORARY SIDEWALK TO BE PROVIDED DURING CONSTRUCTION.



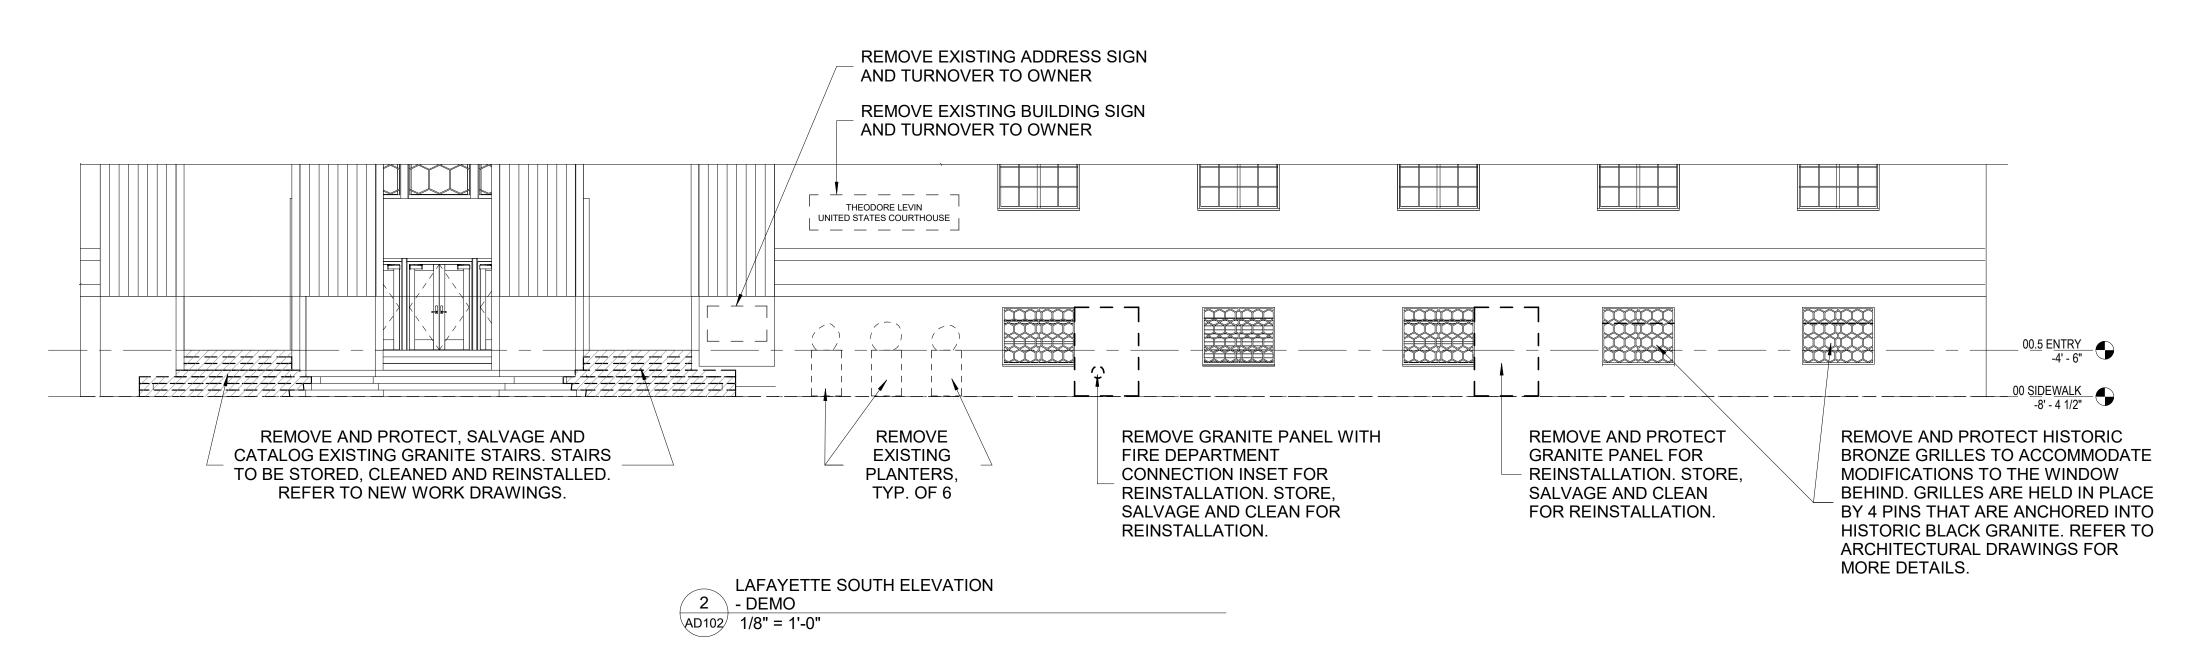

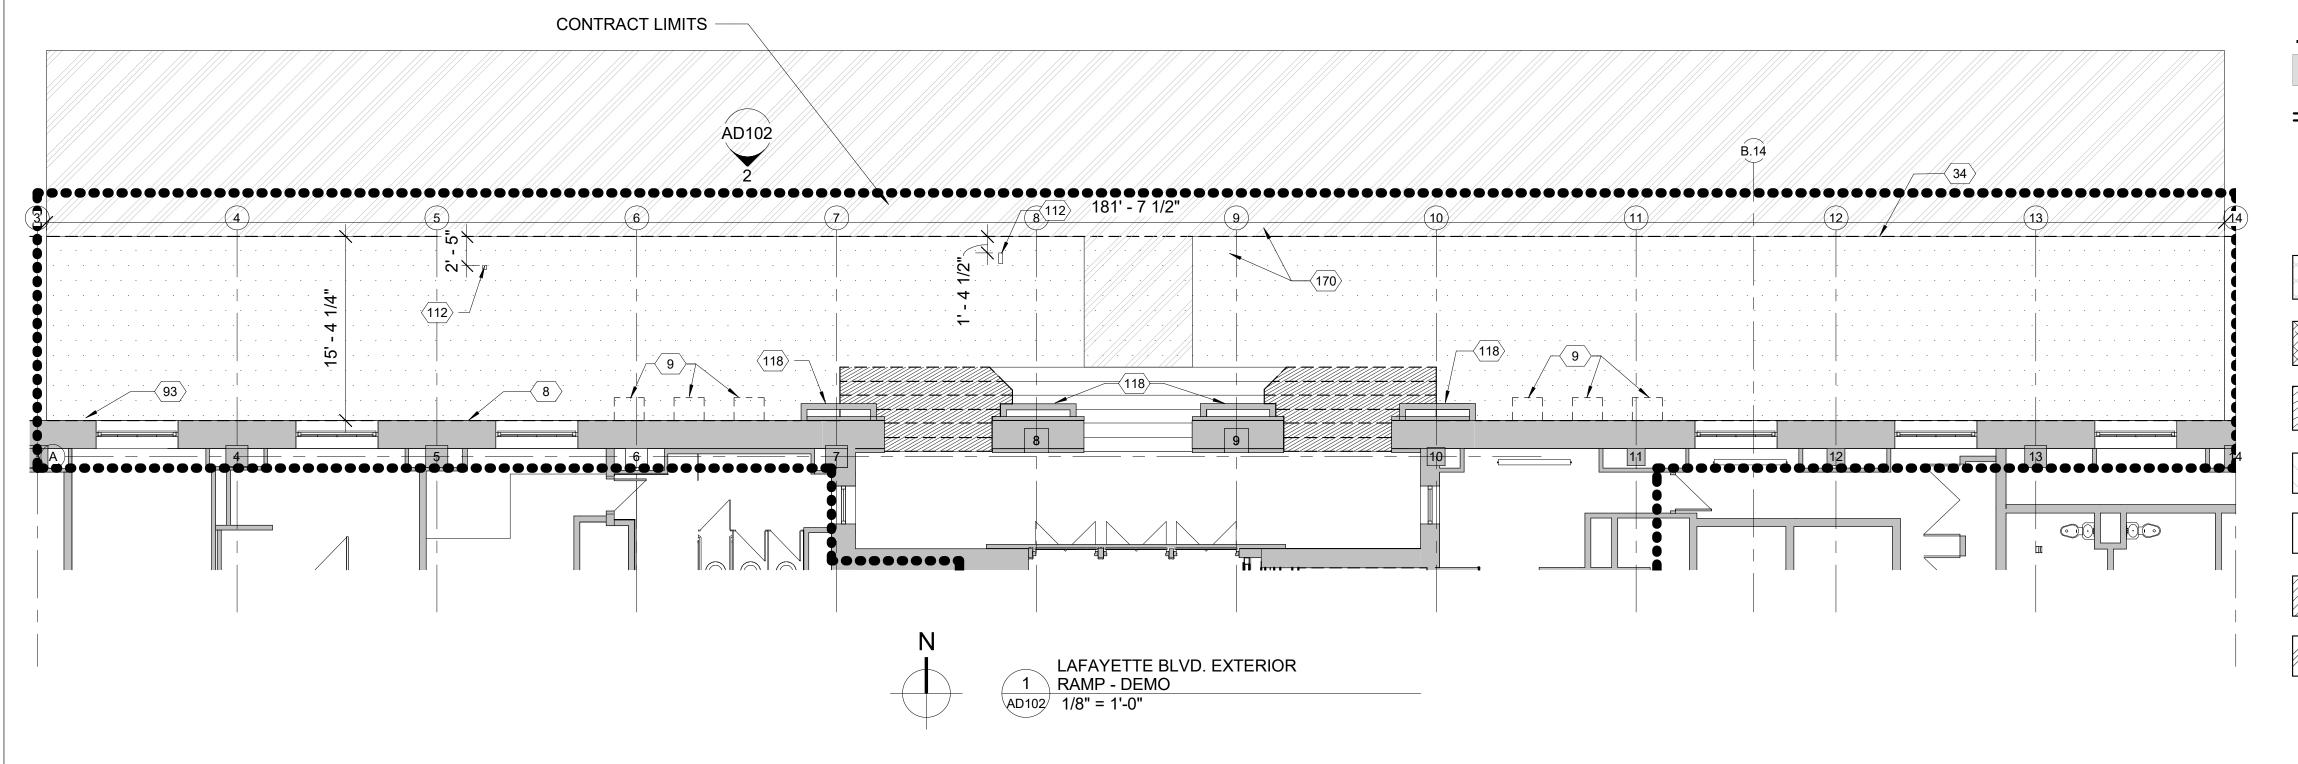GENERAL NOTES

- CONTRACTOR SHALL COMPLY WITH THE GOVERNMENTS RULES AND REGULATIONS.
- CONTRACTOR SHALL PROTECT ALL EXISTING
 CONSTRUCTION AND FINISHES TO REMAIN THROUGHOUT
 THE PREMISES AND IN ADJACENT AREAS. REFER TO
 SECTION 01 35 10 HISTORIC TREATMENT PROCEDURES.
- 3. EXISTING FINISHES ON COLUMNS AND CORE WALLS ARE TO REMAIN U.N.O.
- 4. DO NOT SCALE DRAWINGS OR MODEL TO OBTAIN REQUIRED DIMENSIONAL INFORMATION. CONTRACTOR TO FIELD VERIFY ALL DIMENSIONS. ALL EXISTING CONDITIONS ARE TO BE FIELD VERIFIED BY THE G.C. AND ANY DISCREPANCIES BROUGHT TO THE ARCHITECT'S ATTENTION.
- THE CONTRACTOR SHALL MAINTAIN EGRESS PATHS FROM THE CONSTRUCTION SITE AT ALL TIMES. PROVIDE TEMPORARY DOORS AND PARTITIONS AS REQUIRED WHERE DOORS TO GENERAL CORRIDORS ARE NOTED TO BE REPLACED.
- CONTRACTOR TO PROVIDE SIGNAGE, DUST PROTECTION, AND FLOOR PROTECTION AS REQUIRED FROM THE PROJECT AREA THROUGH PUBLIC CORRIDORS AND ELEVATOR LOBBIES TO PROTECT EXISTING FINISHES TO REMAIN. REFER TO SECTION 01 35 10 HISTORIC TREATMENT PROCEDURES.
- A HAZARDOUS MATERIALS ASSESSMENT OF THE EXISTING BUILDING IN RELATIONSHIP TO THE CONTRACT LIMITS HAS BEEN COMPLETED. REFER TO THE PREALTERATION AND ASSESSMENT REPORT WITHIN THE CONTRACT SPECIFICATIONS FOR ADDITIONAL INFORMATION.
- MAINTAIN ALL LIFE-SAFETY RELATED SYSTEMS IN FULLY OPERATIONAL STATE THROUGHOUT ALL DEMOLITION AND CONSTRUCTION WORK, INCLUDING BUT NOT LIMITED TO FIRE ALARM SYSTEM INCLUDING PANELS, SIGNAL/NOTIFICATION DEVICES, FIRE SUPPRESSION SYSTEM, AND EMERGENCY LIGHTING.
- 9. WORK OUTSIDE THE CONTRACT LIMITS MAY BE REQUIRED FOR TIE-INS AND CONNECTIONS. CONTRACTOR TO WORK OUTSIDE OF THE CONTRACT LIMITS AS REQUIRED TO COMPLETE THE ENTIRE SCOPE OF WORK FOR THE PROJECT.
- 10. COORDINATE WORK WITH ALL OTHER TRADES.
- 11. CMC SHALL COORDINATE WITH GSA PROPERTY
 MANAGEMENT REGARDING STORAGE LOCATIONS FOR
 ITEMS TO BE REMOVED, SALVAGED AND/OR STORED. CMC
 SHALL BE RESPONSIBLE FOR THE PHYSICAL MOVE OF
 ITEMS TO THEIR FINAL LOCATION AND SHALL SUBMIT AN
 INVENTORY LIST OF ITEMS TO BE RETAINED.
- 12. DEMOLITION SHALL BE EXECUTED IN ACCORDANCE WITH THE HISTORIC TREATMENT PLAN THAT IS SUBMITTED AND APPROVED BY THE CMC AND THEIR QUALIFIED CONSULTANTS.

LEGEND

EXISTING PARTITION TO REMAIN

= EXISTING PARTITION TO BE REMOVED (REFER TO KEYED NOTES AND LEGEND)

DOOR AND FRAME TO REMAIN

DOOR AND FRAME TO BE REMOVED

REMOVE EXISTING CONCRETE TOPPING OR
TOPPING AND SLAB AS REQUIRED FOR NEW WORK.

CMU PARTITION TO BE REMOVED

REFER TO STRUCTURAL.

REMOVE EXISTING WOOD TOPPING AS REQUIRED FOR NEW WORK.

COMPONENTS. REFER TO Q-SHEETS.

REMOVE CONCRETE SIDEWALK AS REQUIRED FOR


AS REQUIRED FOR NEW WORK.

REMOVE EXISTING ELEVATOR CAB AND

NEW WORK. COORDINATE WORK WITH CITY OF DETROIT AND PROJECT PHASING.

REMOVE EXISTING GRANITE STAIRS AND LANDING

TEMPORARY SIDEWALK PATH IN STREET AS REQUIRED FOR NEW WORK.

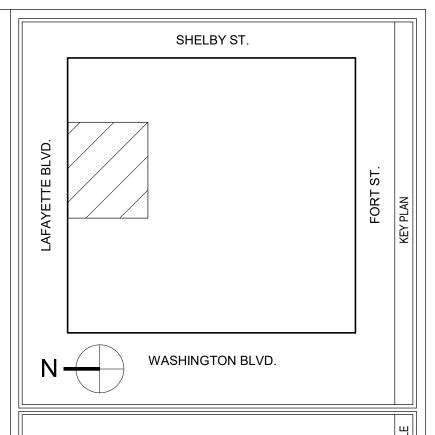


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A/E CONTRACT NO.	47PF0019D0019	\CT
DELIVER ORDER NO.	47PF0021F0822	NTR/
CONST. CONTRACT NO.		8



816 E 4th ST. Royal Oak, MI 48067 248.542.7866/www.ghfaa.com




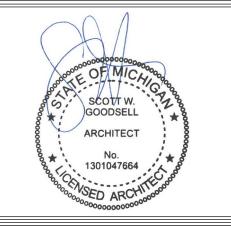

General Services Administration
Public Buildings Service
Great Lakes

Customer Projects Service Center John C. Kluczynski Federal Building 230 South Dearborn St. Room 3500 Chicago, IL 60604

BUILDING NAME	THEODORE LEVIN U.S. COURTHOUSE	
ADDRESS	231 WEST LAFAYETTE	- CN
CITY, STATE, ZIP	Detroit, Michigan 48226	_ E
BUILDING NO.	MI0029ZZ	<u>a</u>
DDO IFOT TITLE	CAPITAL SECURITY	
PROJECT TITLE	PROJECT	
GSA PROJECT NO.	VMI00051	PRO IECT
SUBMISSION STAGE		PRO
SUBMISSION DATE	12/09/2022	
DRAWN BY	SP	
CHECKED BY	SWG	
FLOOR NO.	EXTERIOR	
DISCIPLINE	ARCHITECTURAL	
PLAN TYPE	DEMO FLOOR PLAN	
SHEET NUMBER AND FILENAME	AD102	

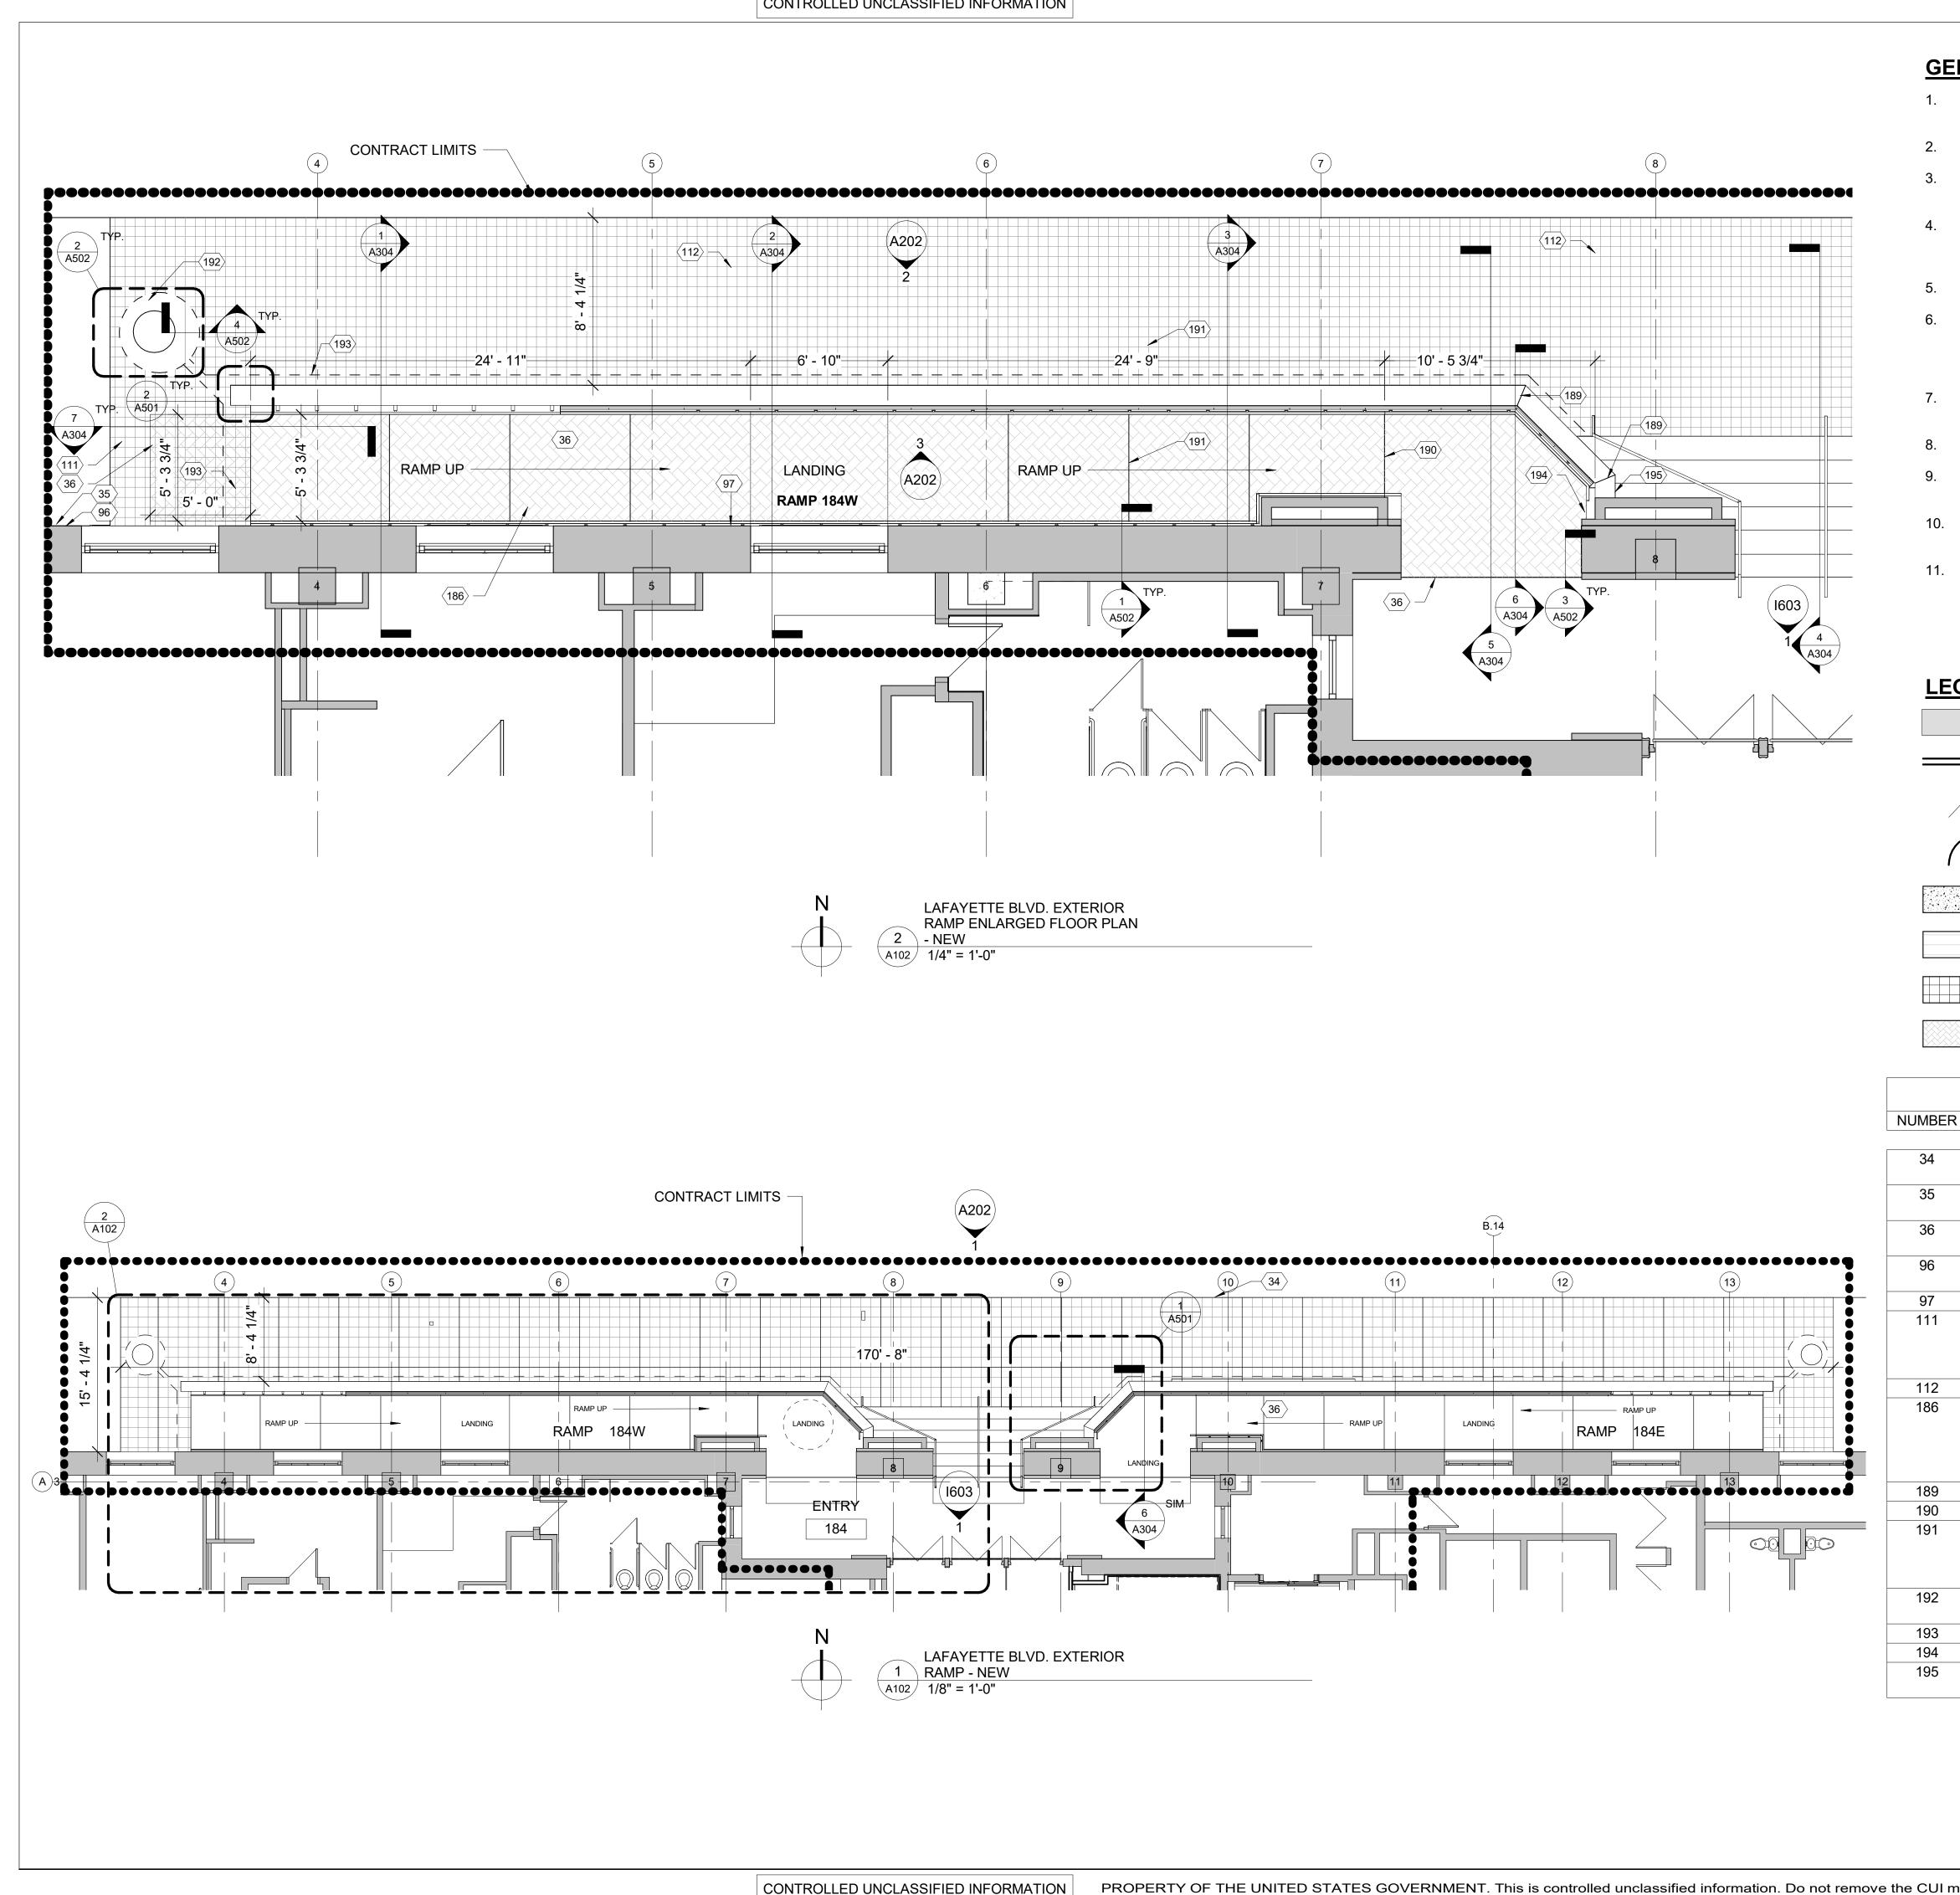

GENERAL NOTES

- CONTRACTOR SHALL COMPLY WITH THE GOVERNMENTS RULES AND REGULATIONS.
- DIMENSIONS ARE MEASURED TO THE FACE OF PARTITION U.N.O.
- ALL SWINGING DOORS WITHOUT KEY NUMBERS ARE EXISTING TO REMAIN. U.N.O.
- WHERE EVER THE TERMINOLOGY (ABAAS) OCCURS, REFERENCE IS MADE TO THE ARCHITECTURAL BARRIERS ACT ACCESSIBILITY STANDARDS.
- COORDINATE WORK WITH ALL OTHER TRADES.
- WORK OUTSIDE THE CONTRACT LIMITS MAY BE REQUIRED FOR TIE-INS AND CONNECTIONS. CONTRACTOR TO WORK OUTSIDE OF THE CONTRACT LIMITS AS REQUIRED TO COMPLETE THE ENTIRE SCOPE OF WORK FOR THE PROJECT.
- PATCH ANY OPENINGS, CORES, FASTENER HOLES, ETC. RESULTING FROM DEMOLITION.
- CONTRACTOR SHALL LAYOUT WALL LOCATIONS AND REVIEW WITH ARCHITECT PRIOR TO CONSTRUCTING ANY PARTITIONS.
- ALL DOORS REQUIRED CLEARANCE OF 18" PULL SIDE AND 12" PUSH SIDE U.N.O.
- PROVIDE IN-WALL BLOCKING FOR WALL STOPS. REFER TO DOOR SCHEDULE
- CONTRACTOR TO REVIEW AND COORDINATE WALLS TO DECK WITH DEVICES SUPPORTED FROM STRUCTURAL DECK ABOVE INCLUDING BUT NOT LIMITED TO FIRE ALARM CONDUIT, JUNCTION BOXES, MECHANICAL DUCTWORK, ETC. CONTRACTOR TO JOG WALLS ABOVE CEILING AS REQUIRED TO AVOID CONFLICTS.

LEGEND

EXISTING PARTITION TO REMAIN

NEW CONCRETE FLOORING

NEW PARTITION

EXISTING DOOR AND FRAME TO REMAIN

NEW DOOR AND FRAME

NEW CONCRETE SIDEWALK

NEW CONCRETE TOPPING AND/OR SLAB - REFER TO

STRUCTURAL

NEW CONCRETE EMBEDDED SNOW MELT SYSTEM

KEYED NOTES DESCRIPTION

REMOVE AND RESET EXISTING GRANITE CURB ON EXISTING CONCRETE CURB FOUNDATION.

RELOCATED FIRE DEPARTMENT CONNECTION AS REQUIRED FOR NEW WORK. REFER TO FIRE SUPPRESSION DRAWINGS. PROVIDE NEW CONCRETE EMBEDDED SNOWMELT SYSTEM.

REFER TO MEP DRAWINGS. INSTALL SALVAGED GRANITE PANEL WITH INSET FIRE

DEPARTMENT CONNECTION. INSTALL SALVAGED GRANITE PANEL.

NEW SIDEWALK AS REQUIRED. CONTRACTOR IS RESPONSIBLE TO COORDINATE WITH CITY OF DETROIT AS REQUIRED FOR WORK. PROVIDE PERMITS AS REQUIRED. REFER TO APPENDIX B FOR THE

GEOTECHNICAL REPORT. EXISTING SIGN AND POST TO REMAIN.

NEW CONCRETE EMBEDDED SNOW MELT SYSTEM EQUAL TO EMERSON WITH MCS1 CONTROLLER AND TS1 TEMPERATURE. SEPARATE SYSTEMS FOR EAST AND WEST RAMPS. 50W PER SF. EXTEND INTO FIRST FLAG OF SIDEWALK - MINIMUM 5 FEET FROM

END OF RAMP. INSULATE UNDERSIDE OF TOPPING SLAB.

MITER JOINT IN TOP OF SLOPED GRANITE PANEL.

EXPANSION JOINT AT EACH LEVEL TRANSITION - TYP. SAWCUT CONTROL JOINTS NOT LESS THAN EVERY 5 FEET BUT

NOT MORE THAN EVERY 7 FEET - TYP PER CITY OF DETROIT STANDARDS. DO NOT CUT JOINTS DEEPER THAN SNOW MELT

48" DIA X 60"D PRECAST CONCRETE DRY WELL AND FLAT CAP W/O TOP OPENING BENEATH CONCRETE SLAB. 4" DIA DRAIN TILE AT RAMP FOOTING - CONNECT TO DRY WELL.

PAVEMENT-MOUNTED MOISTURE SENSOR. TYP FOR EACH RAMP AERIAL MOISTURE SENSOR MOUNTED TO NEW RAMP WALL. TYP FOR EACH RAMP

SHELBY ST. WASHINGTON BLVD.

MARK DATE DESCRIPTION

A/E CONTRACT NO. 47PF0019D0019 DELIVER ORDER NO. 47PF0021F0822 CONST. CONTRACT NO.



816 E 4th ST. Royal Oak, MI 48067 248.542.7866/www.ghfaa.com



General Services Administration


Public Buildings Service


Great Lakes


GS*≿*

Customer Projects Service Center John C. Kluczynski Federal Building 230 South Dearborn St. Room 3500 Chicago, IL 60604

BUILDING NAME	THEODORE LEVIN U.S. COURTHOUSE	
ADDRESS	231 WEST LAFAYETTE	9
CITY, STATE, ZIP	Detroit, Michigan 48226	BUILDING
BUILDING NO.	MI0029ZZ	<u> </u>
DDO IECT TITLE	CAPITAL SECURITY	
PROJECT TITLE	PROJECT	
GSA PROJECT NO.	VMI00051	PROJECT
SUBMISSION STAGE		PRO
SUBMISSION DATE	12/09/2022	
DRAWN BY	SP	
CHECKED BY	SWG	
FLOOR NO.	EXTERIOR	
DISCIPLINE	ARCHITECTURAL	SHEET
PLAN TYPE	NEW FLOOR PLAN	ਠ
SHEET NUMBER AND FILENAME	A102	

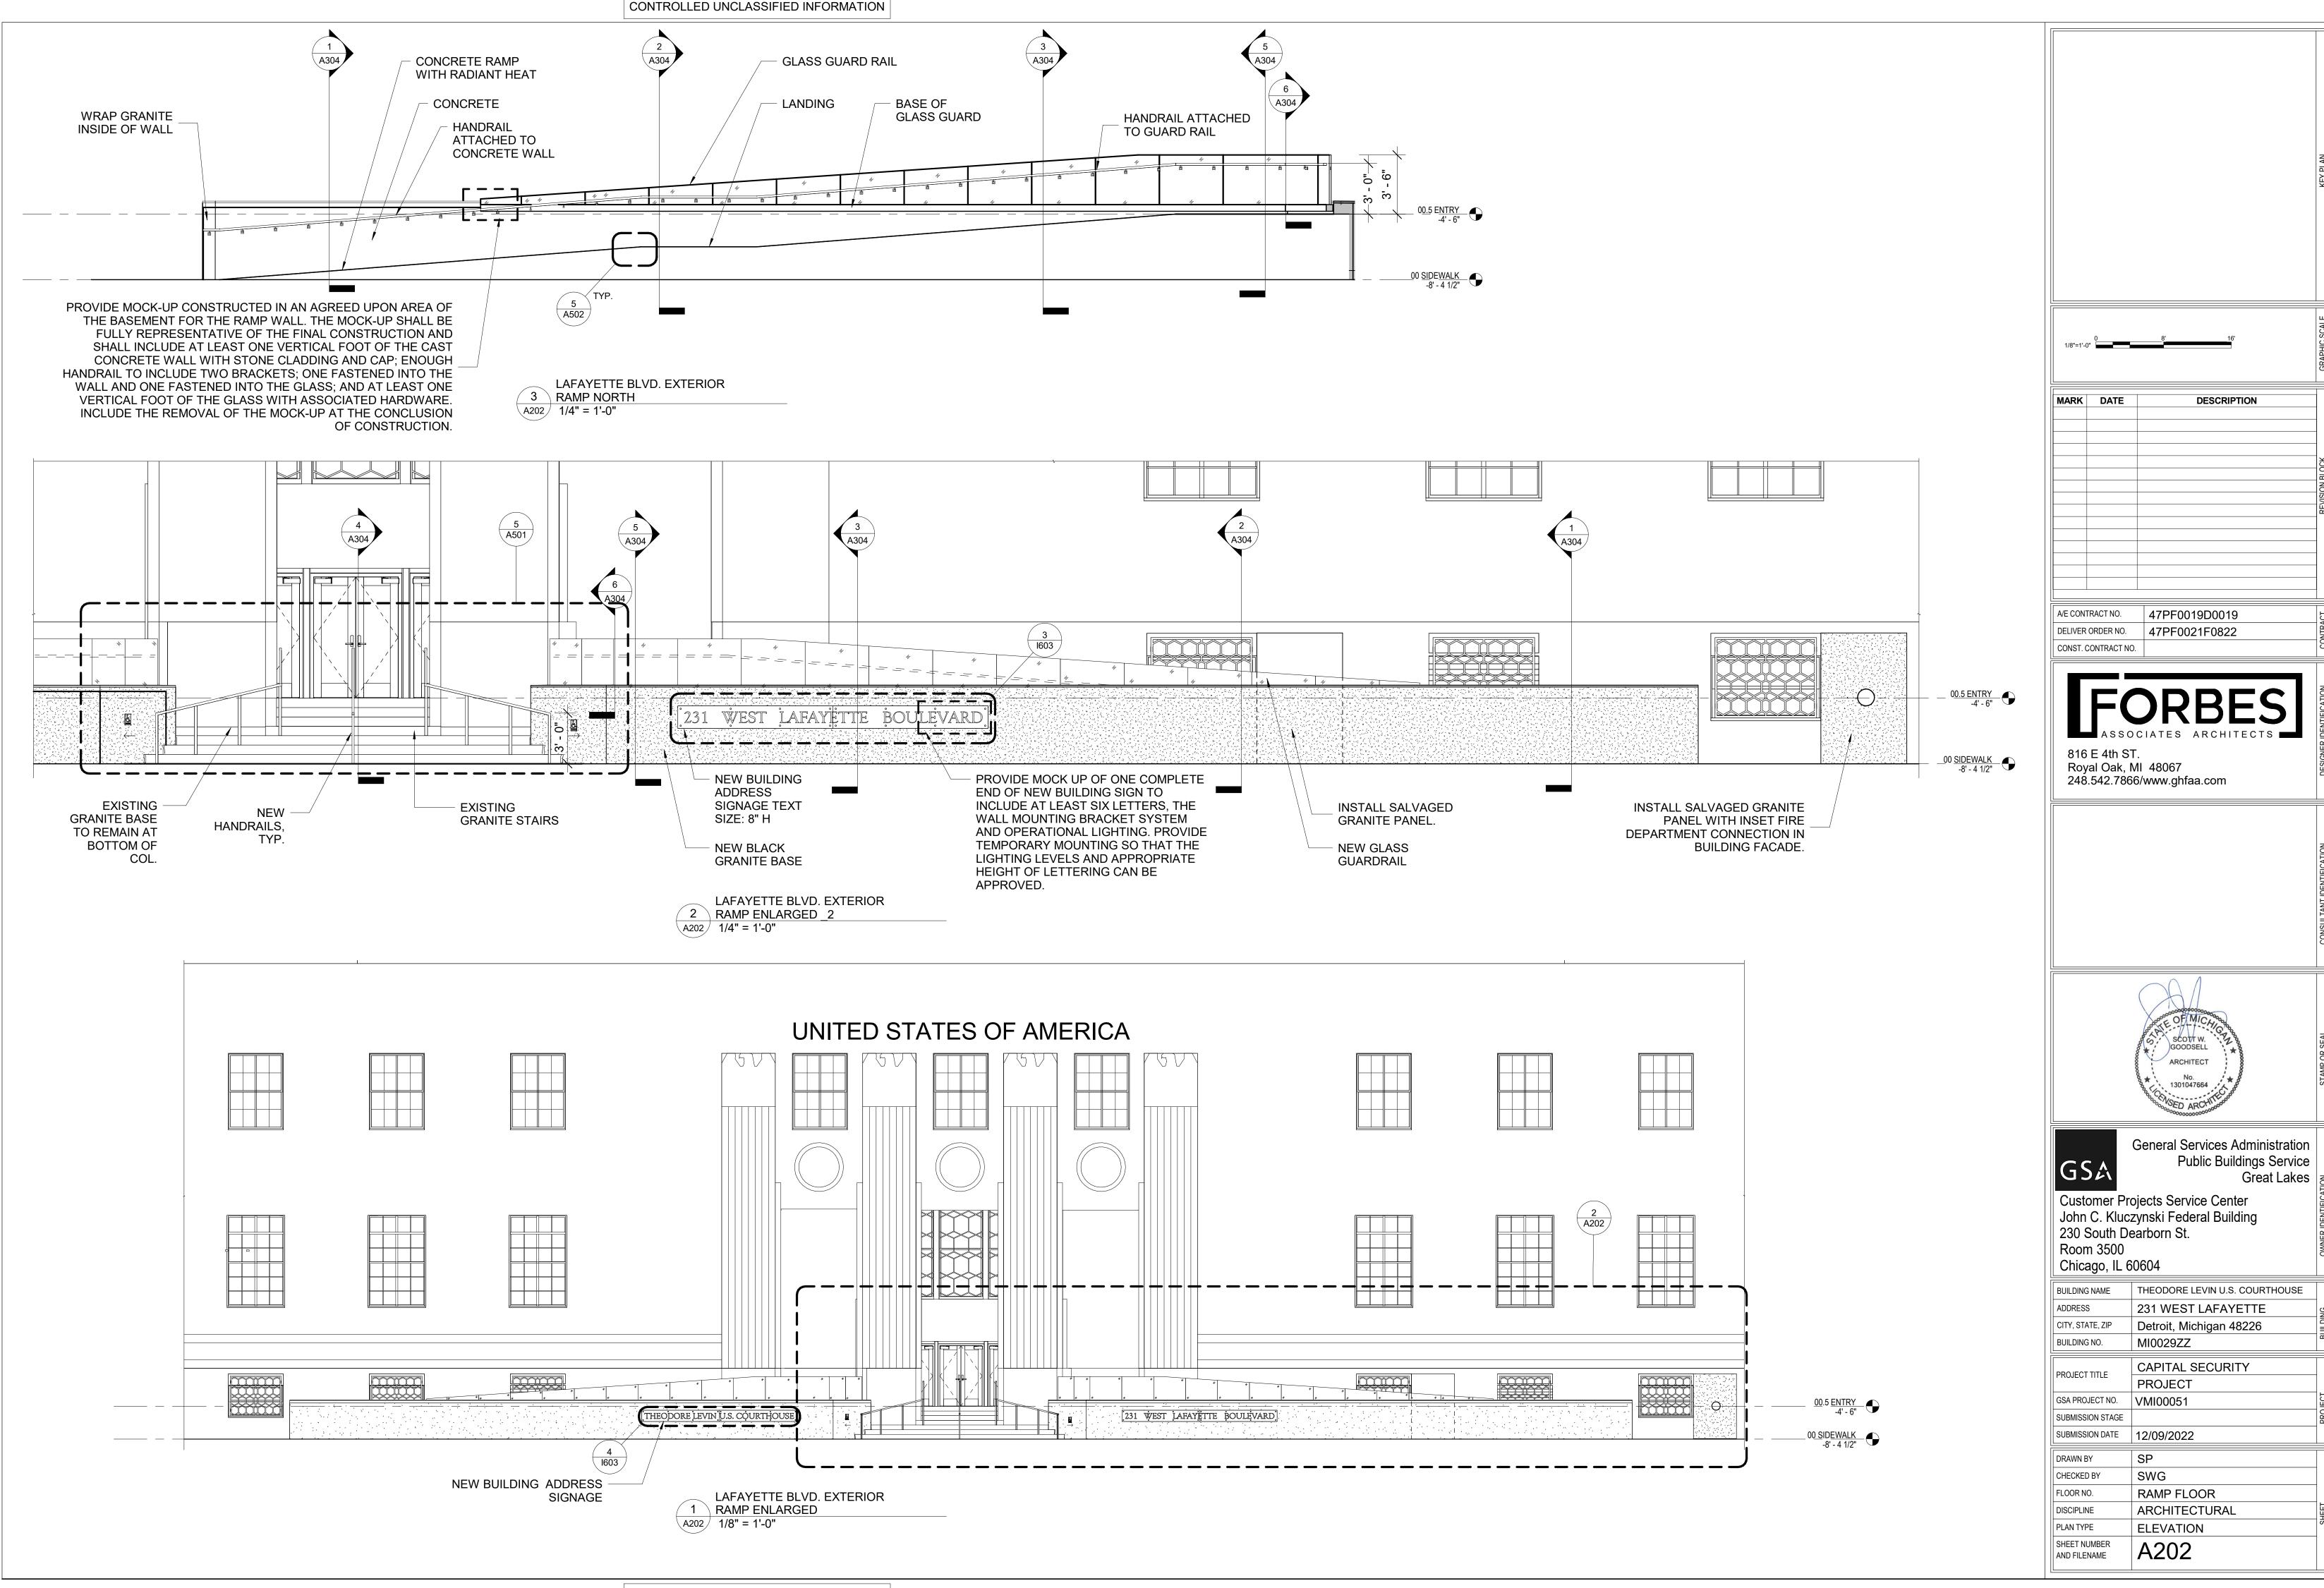

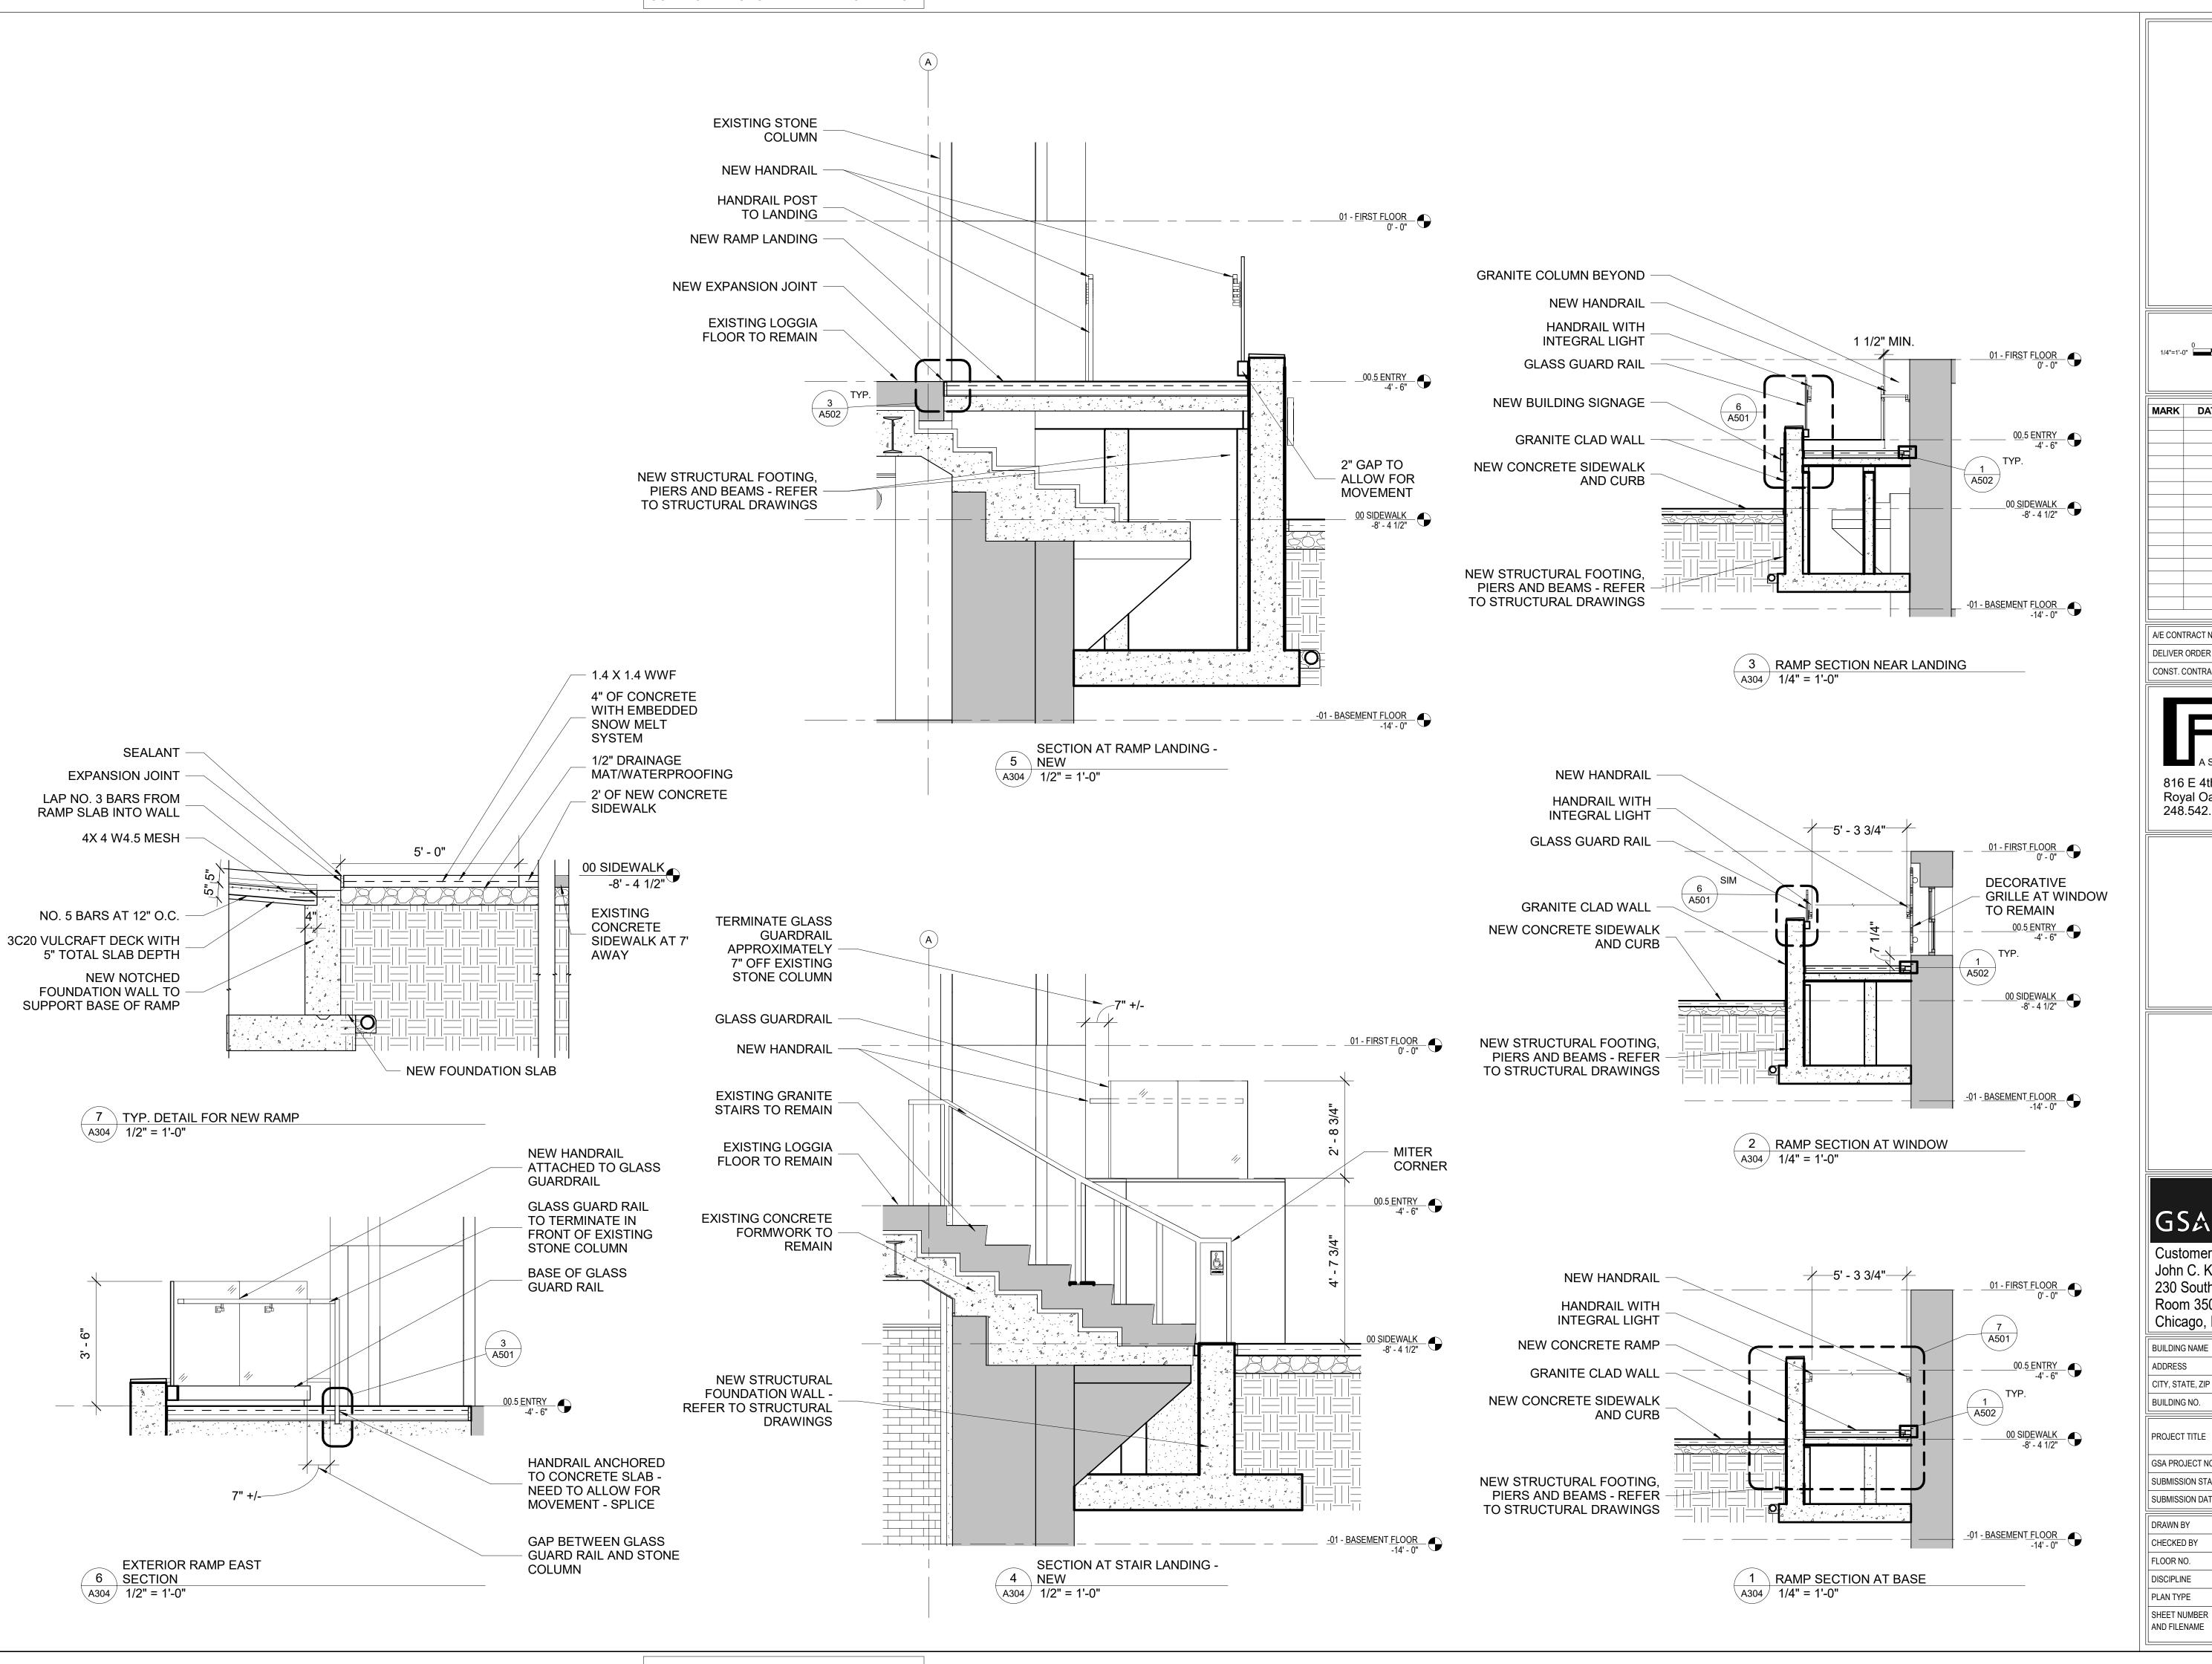


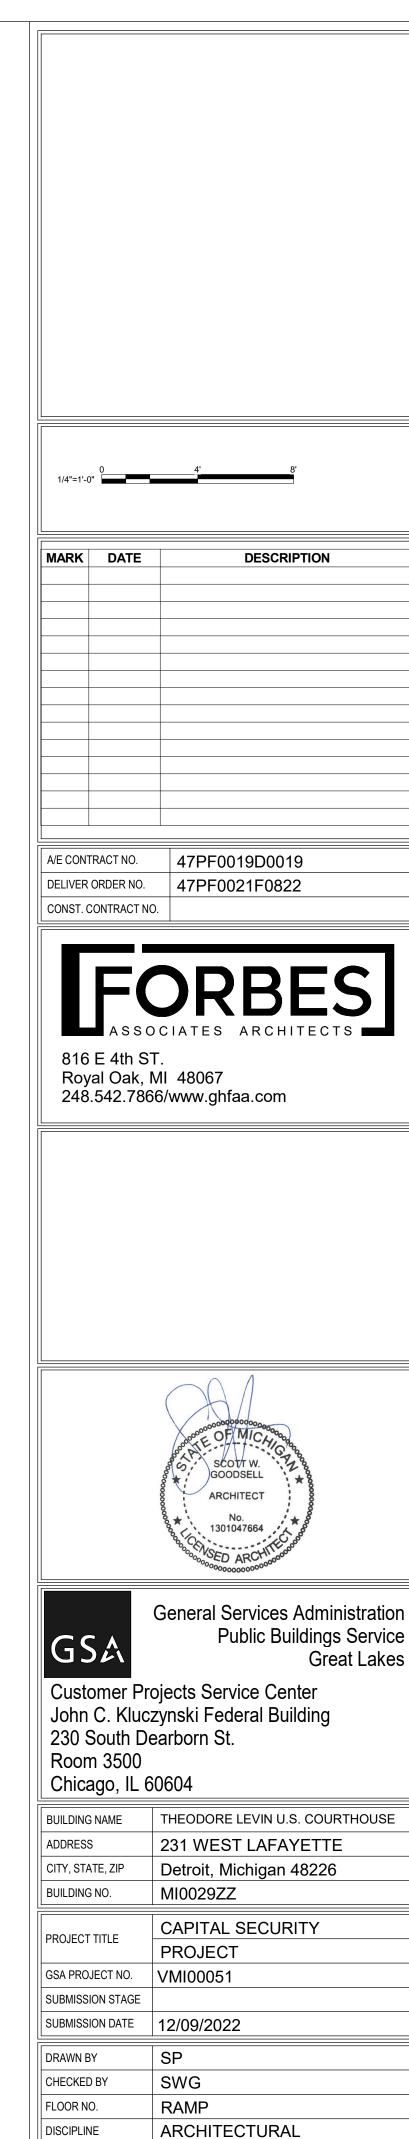



Great Lakes


SECTION

A304

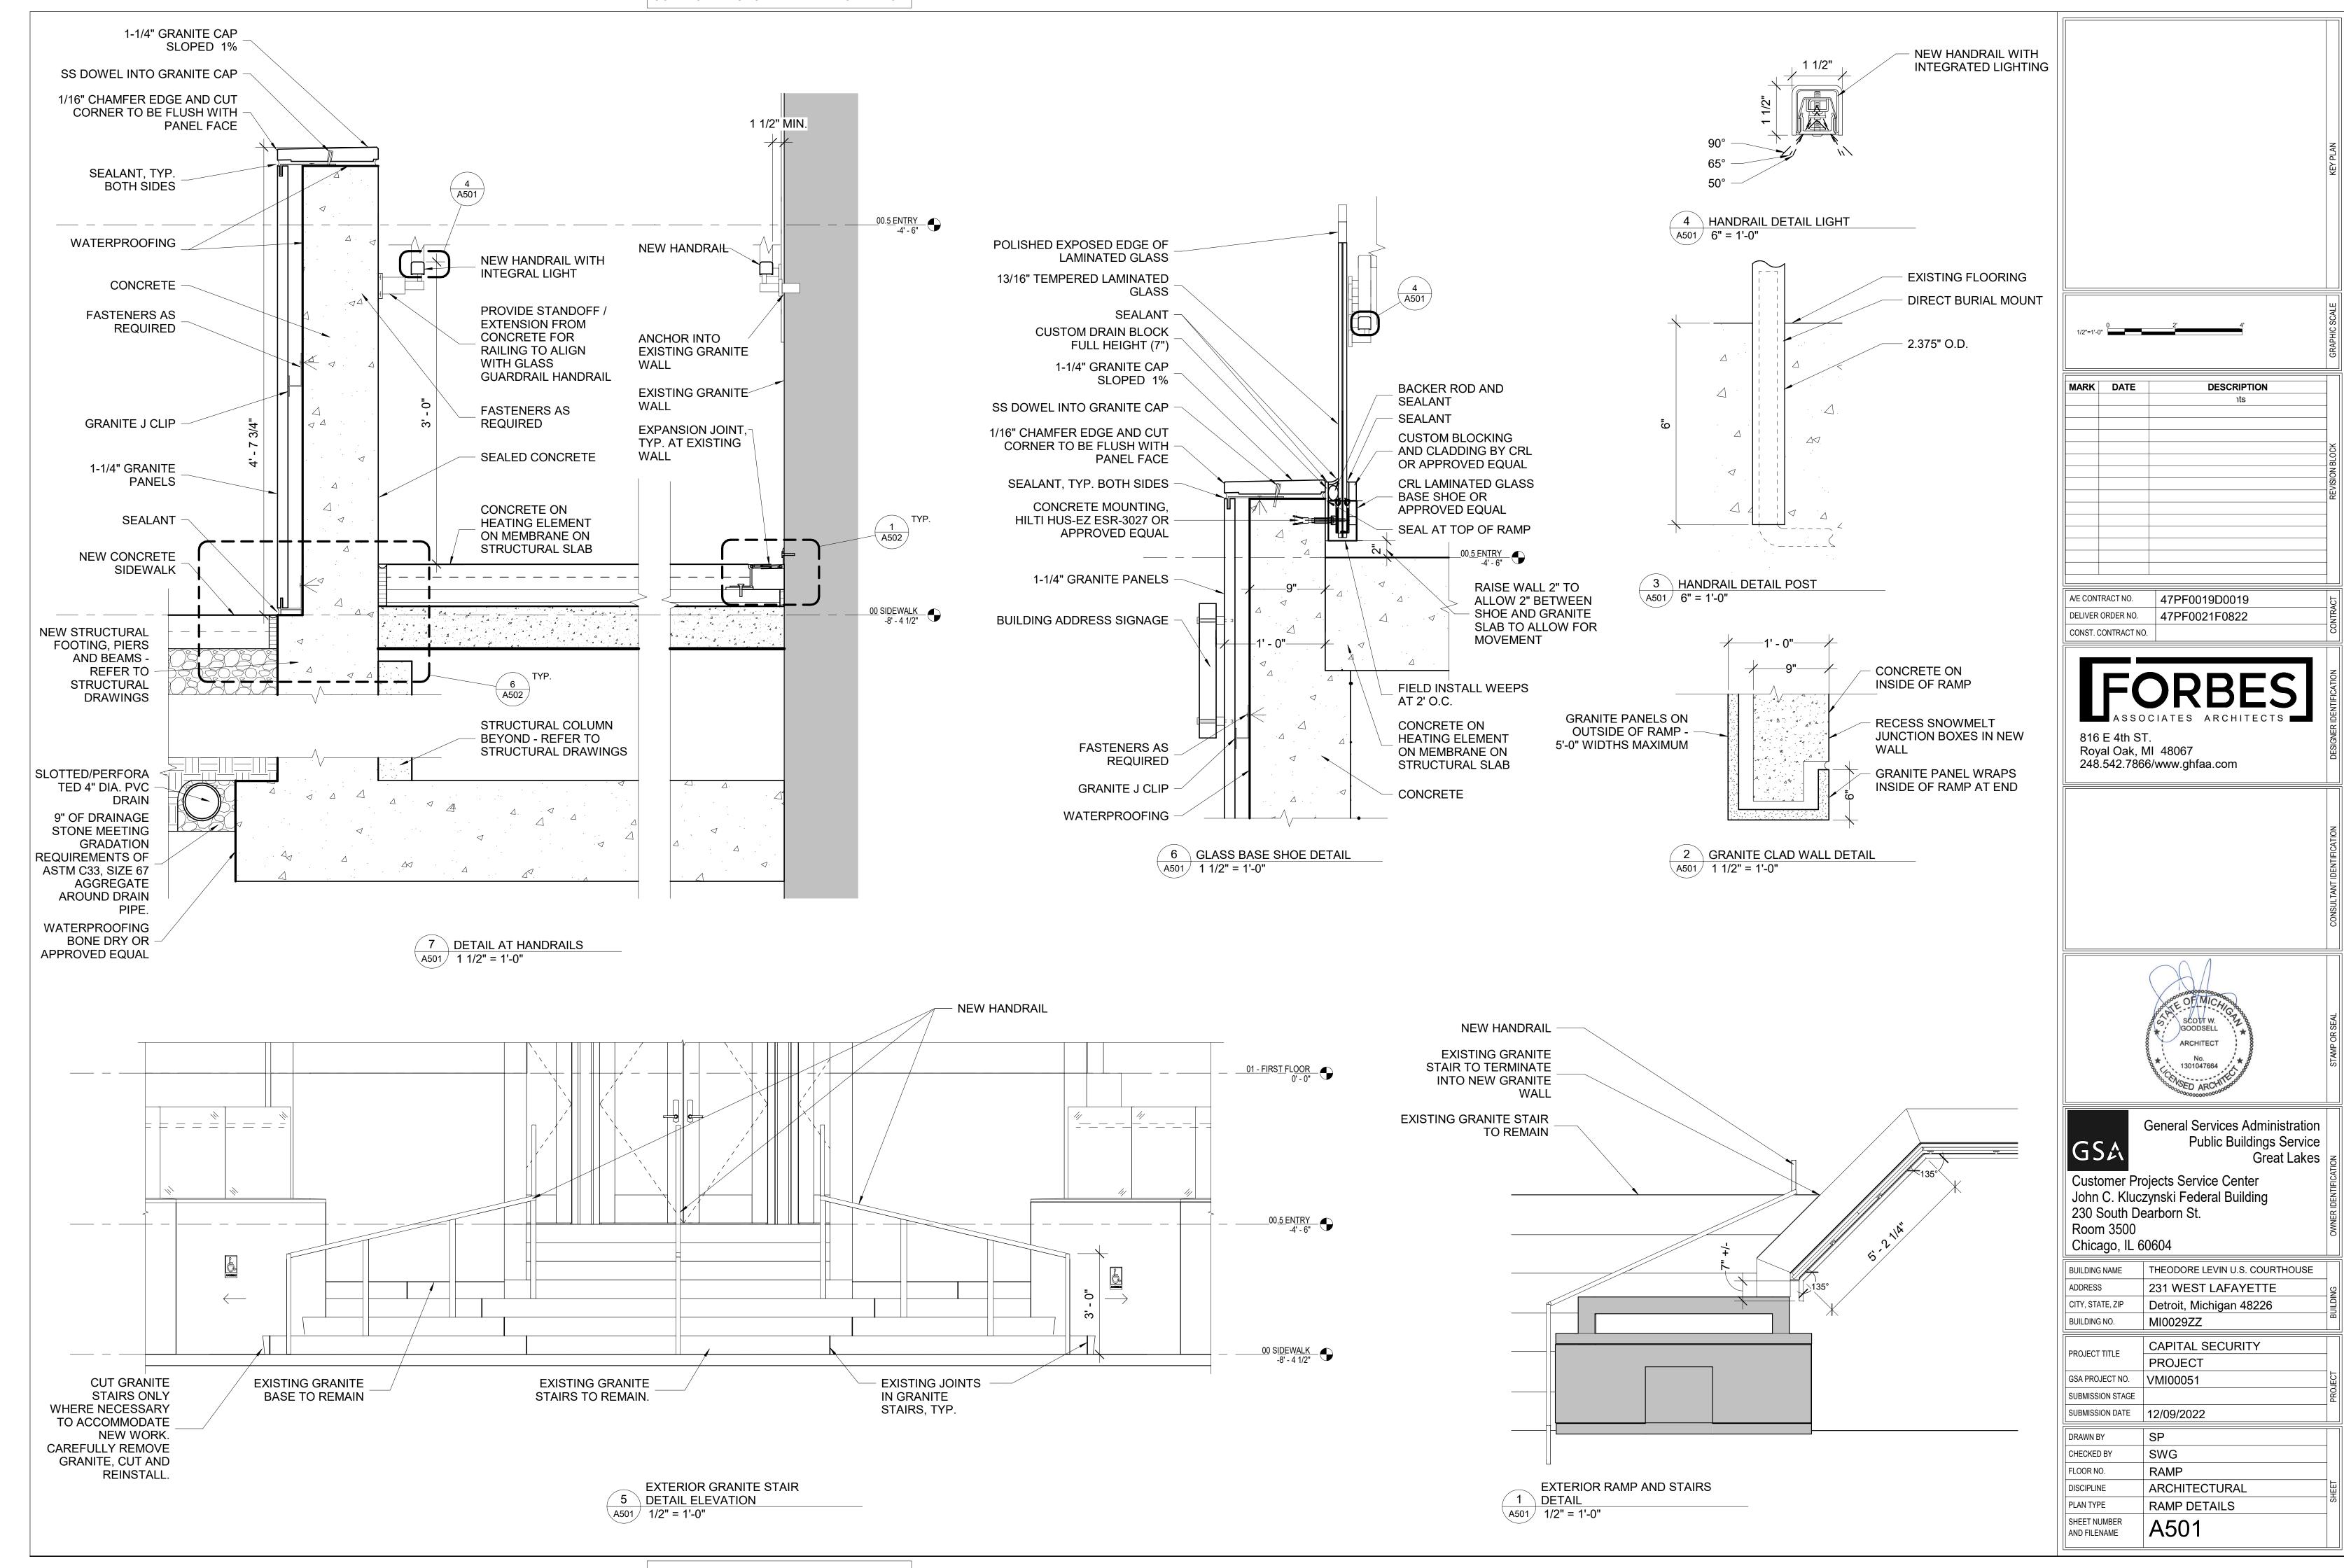

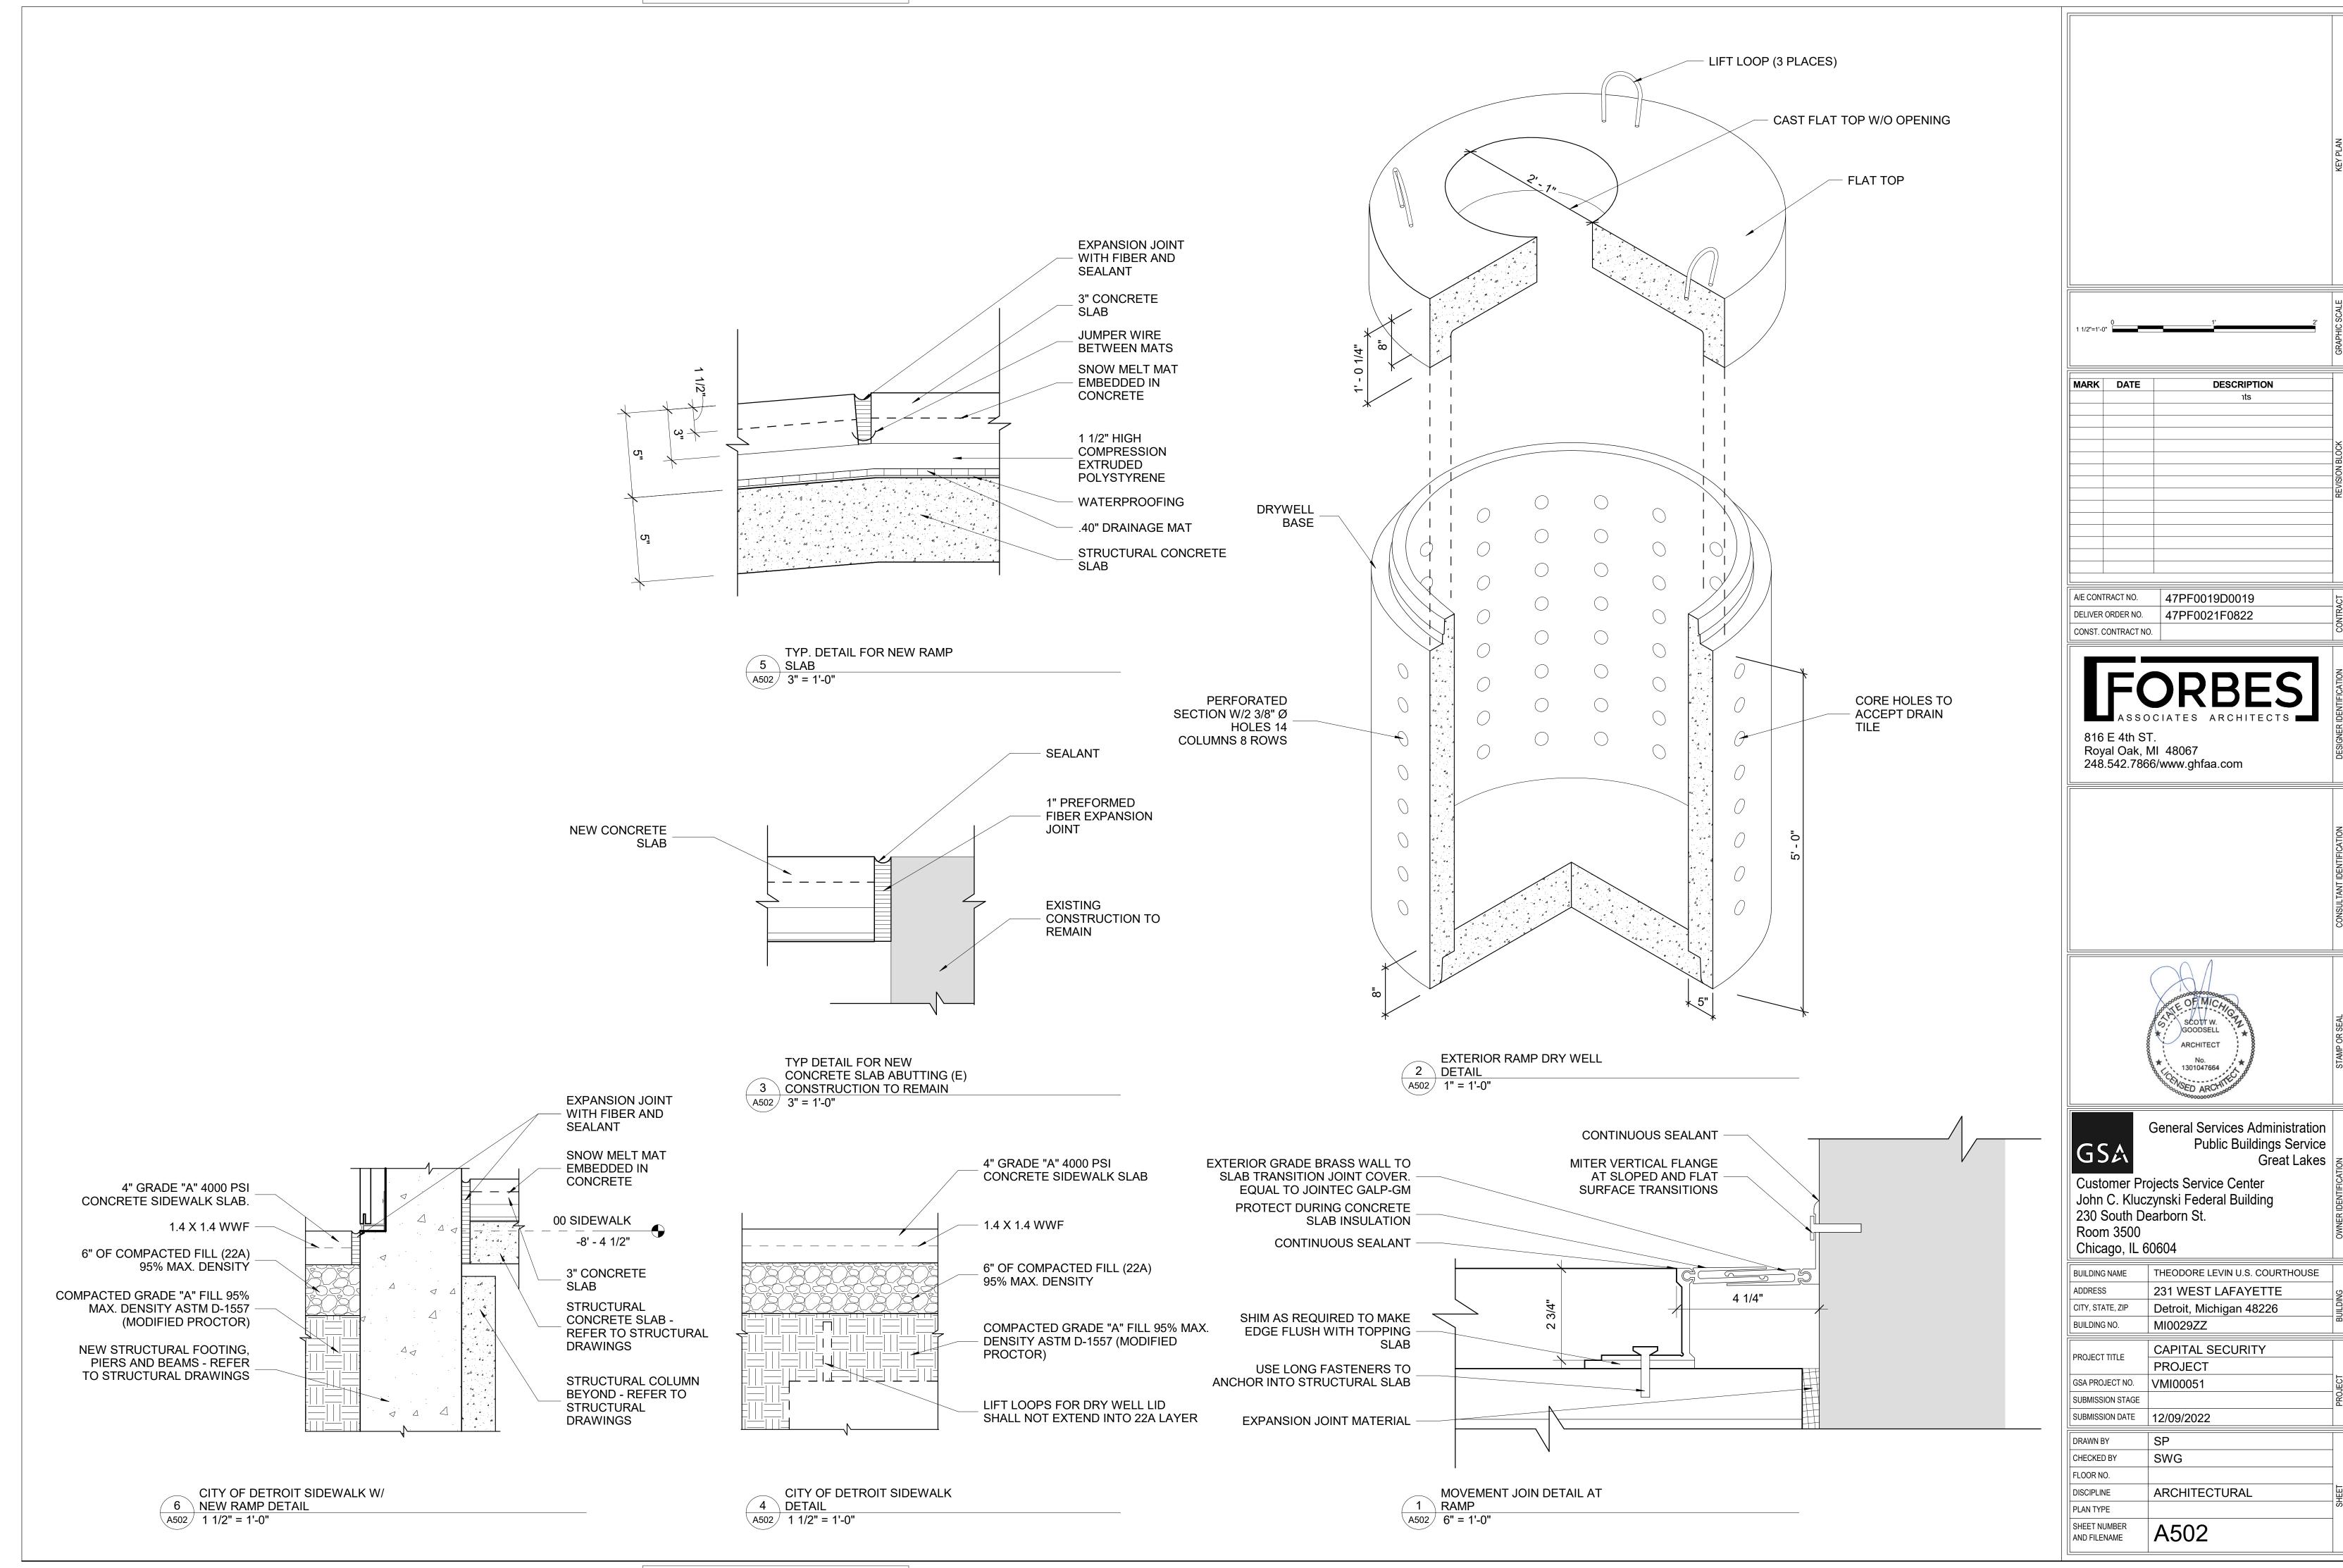

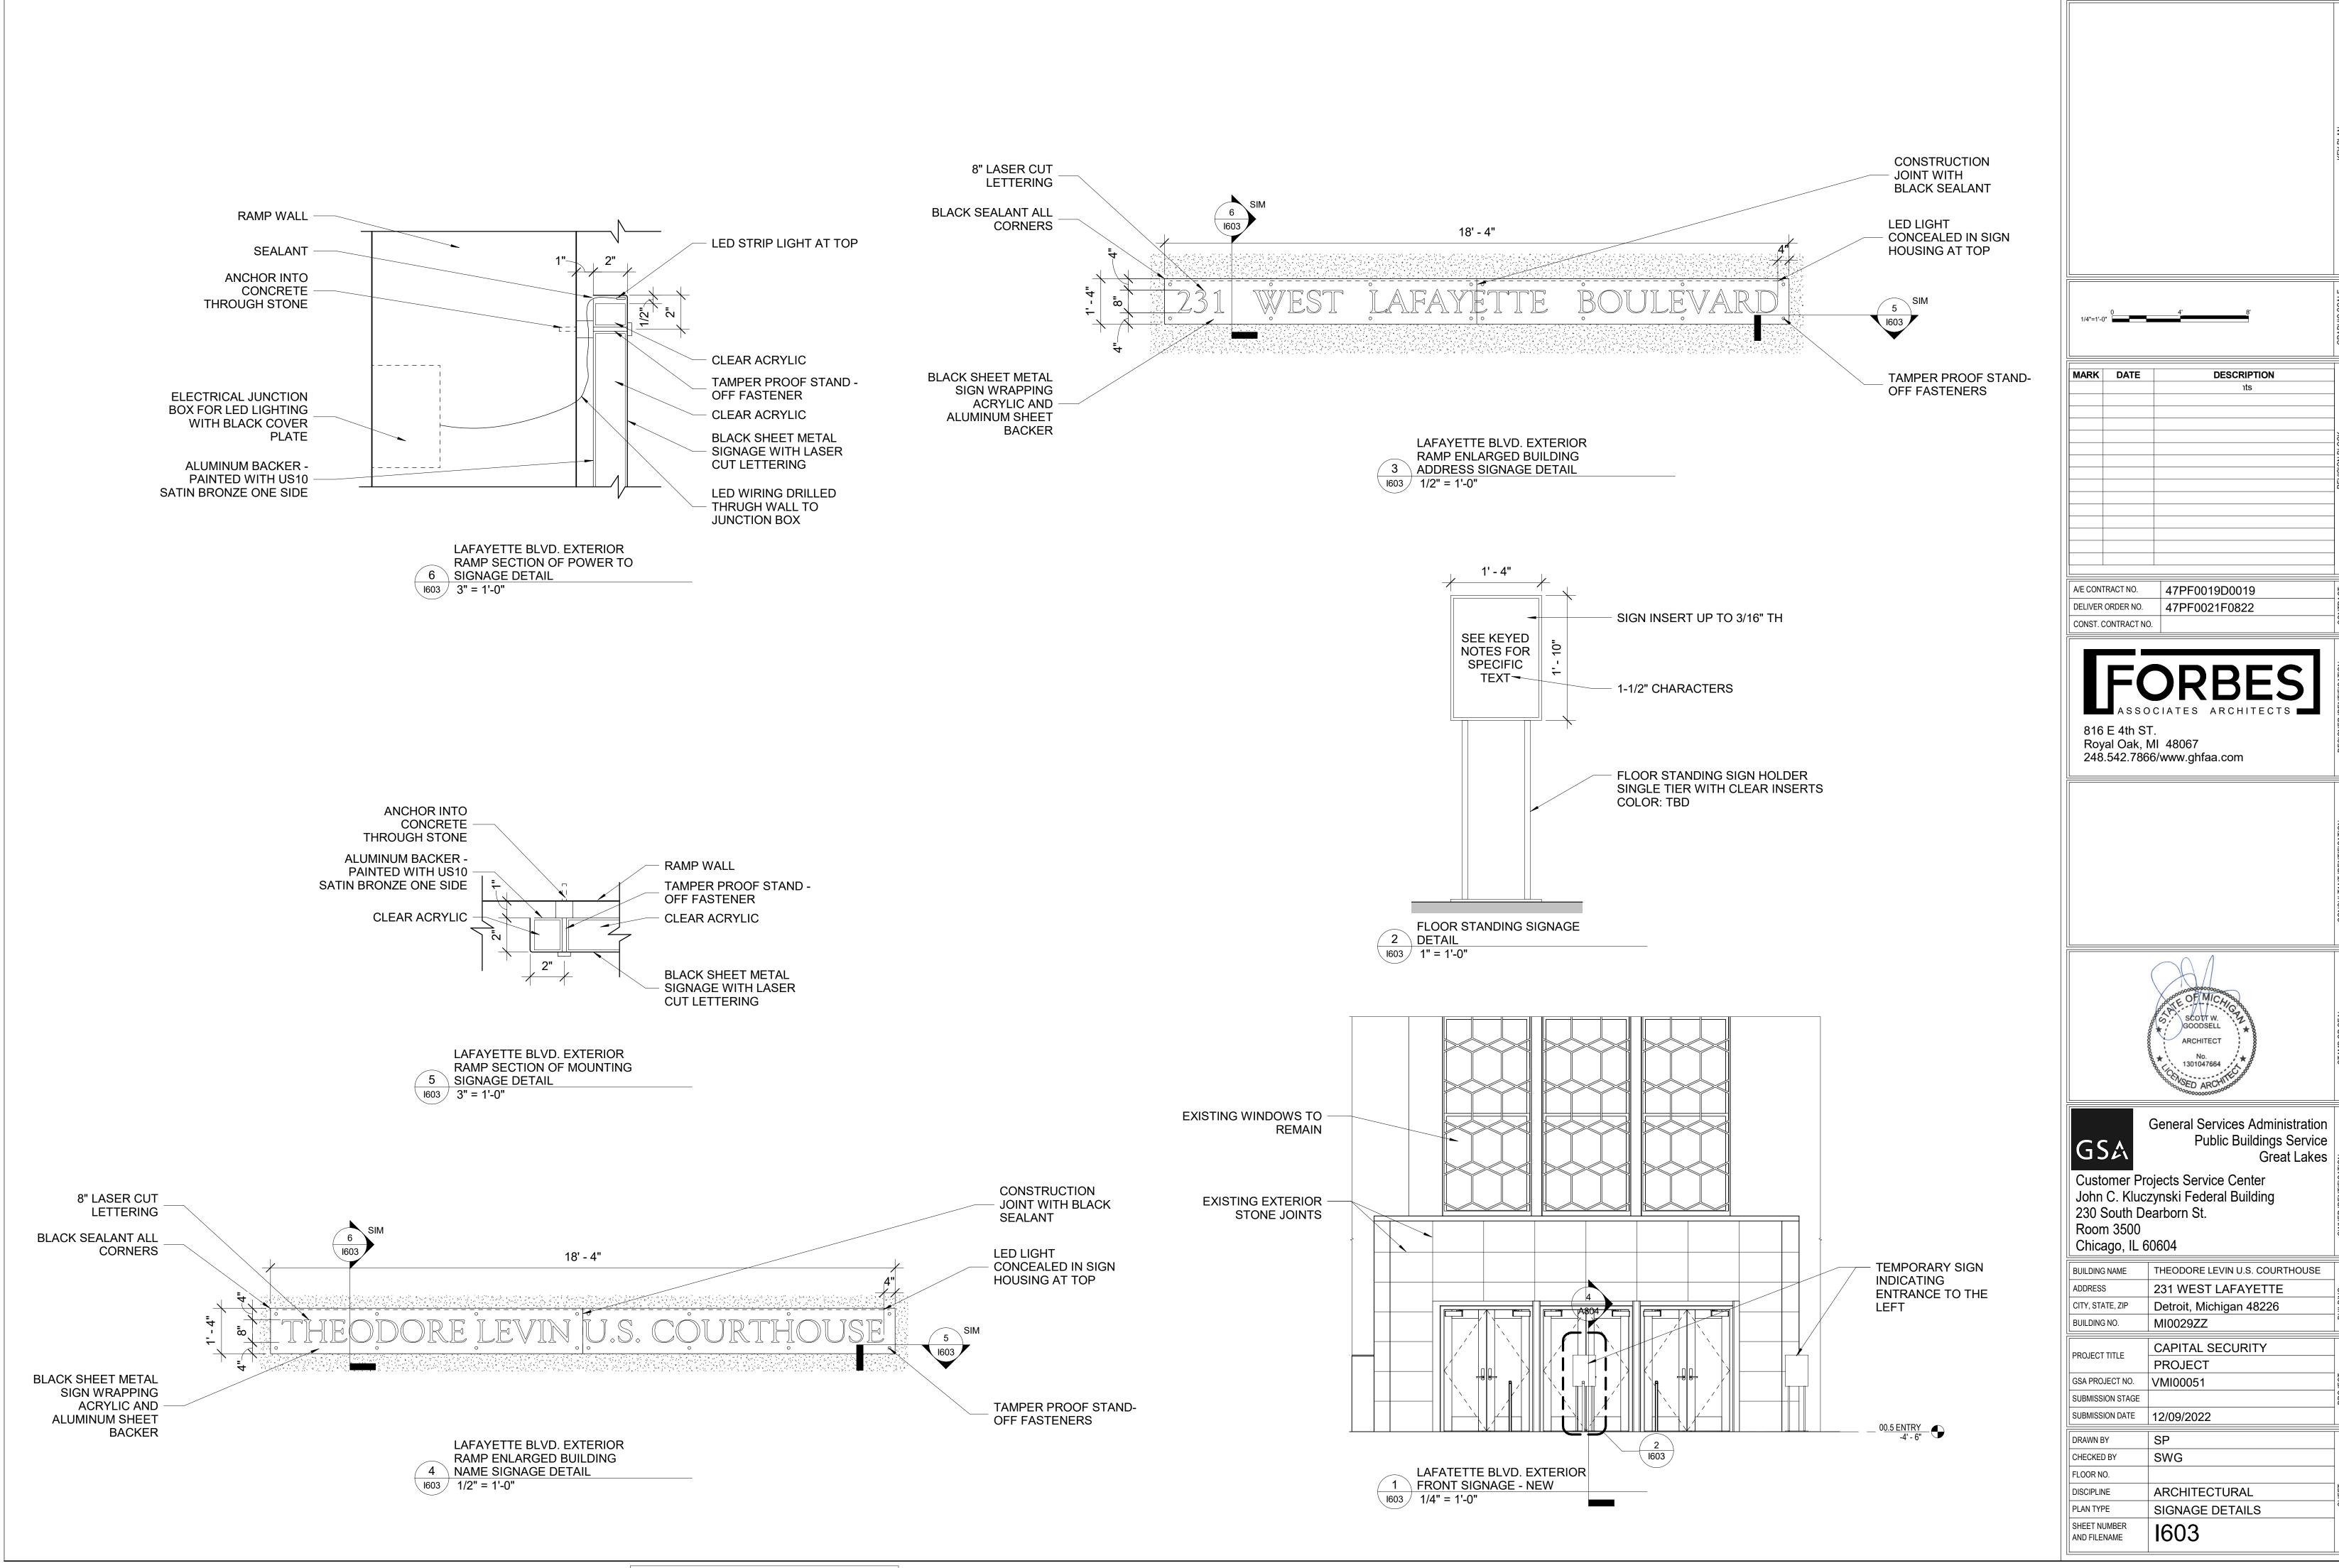

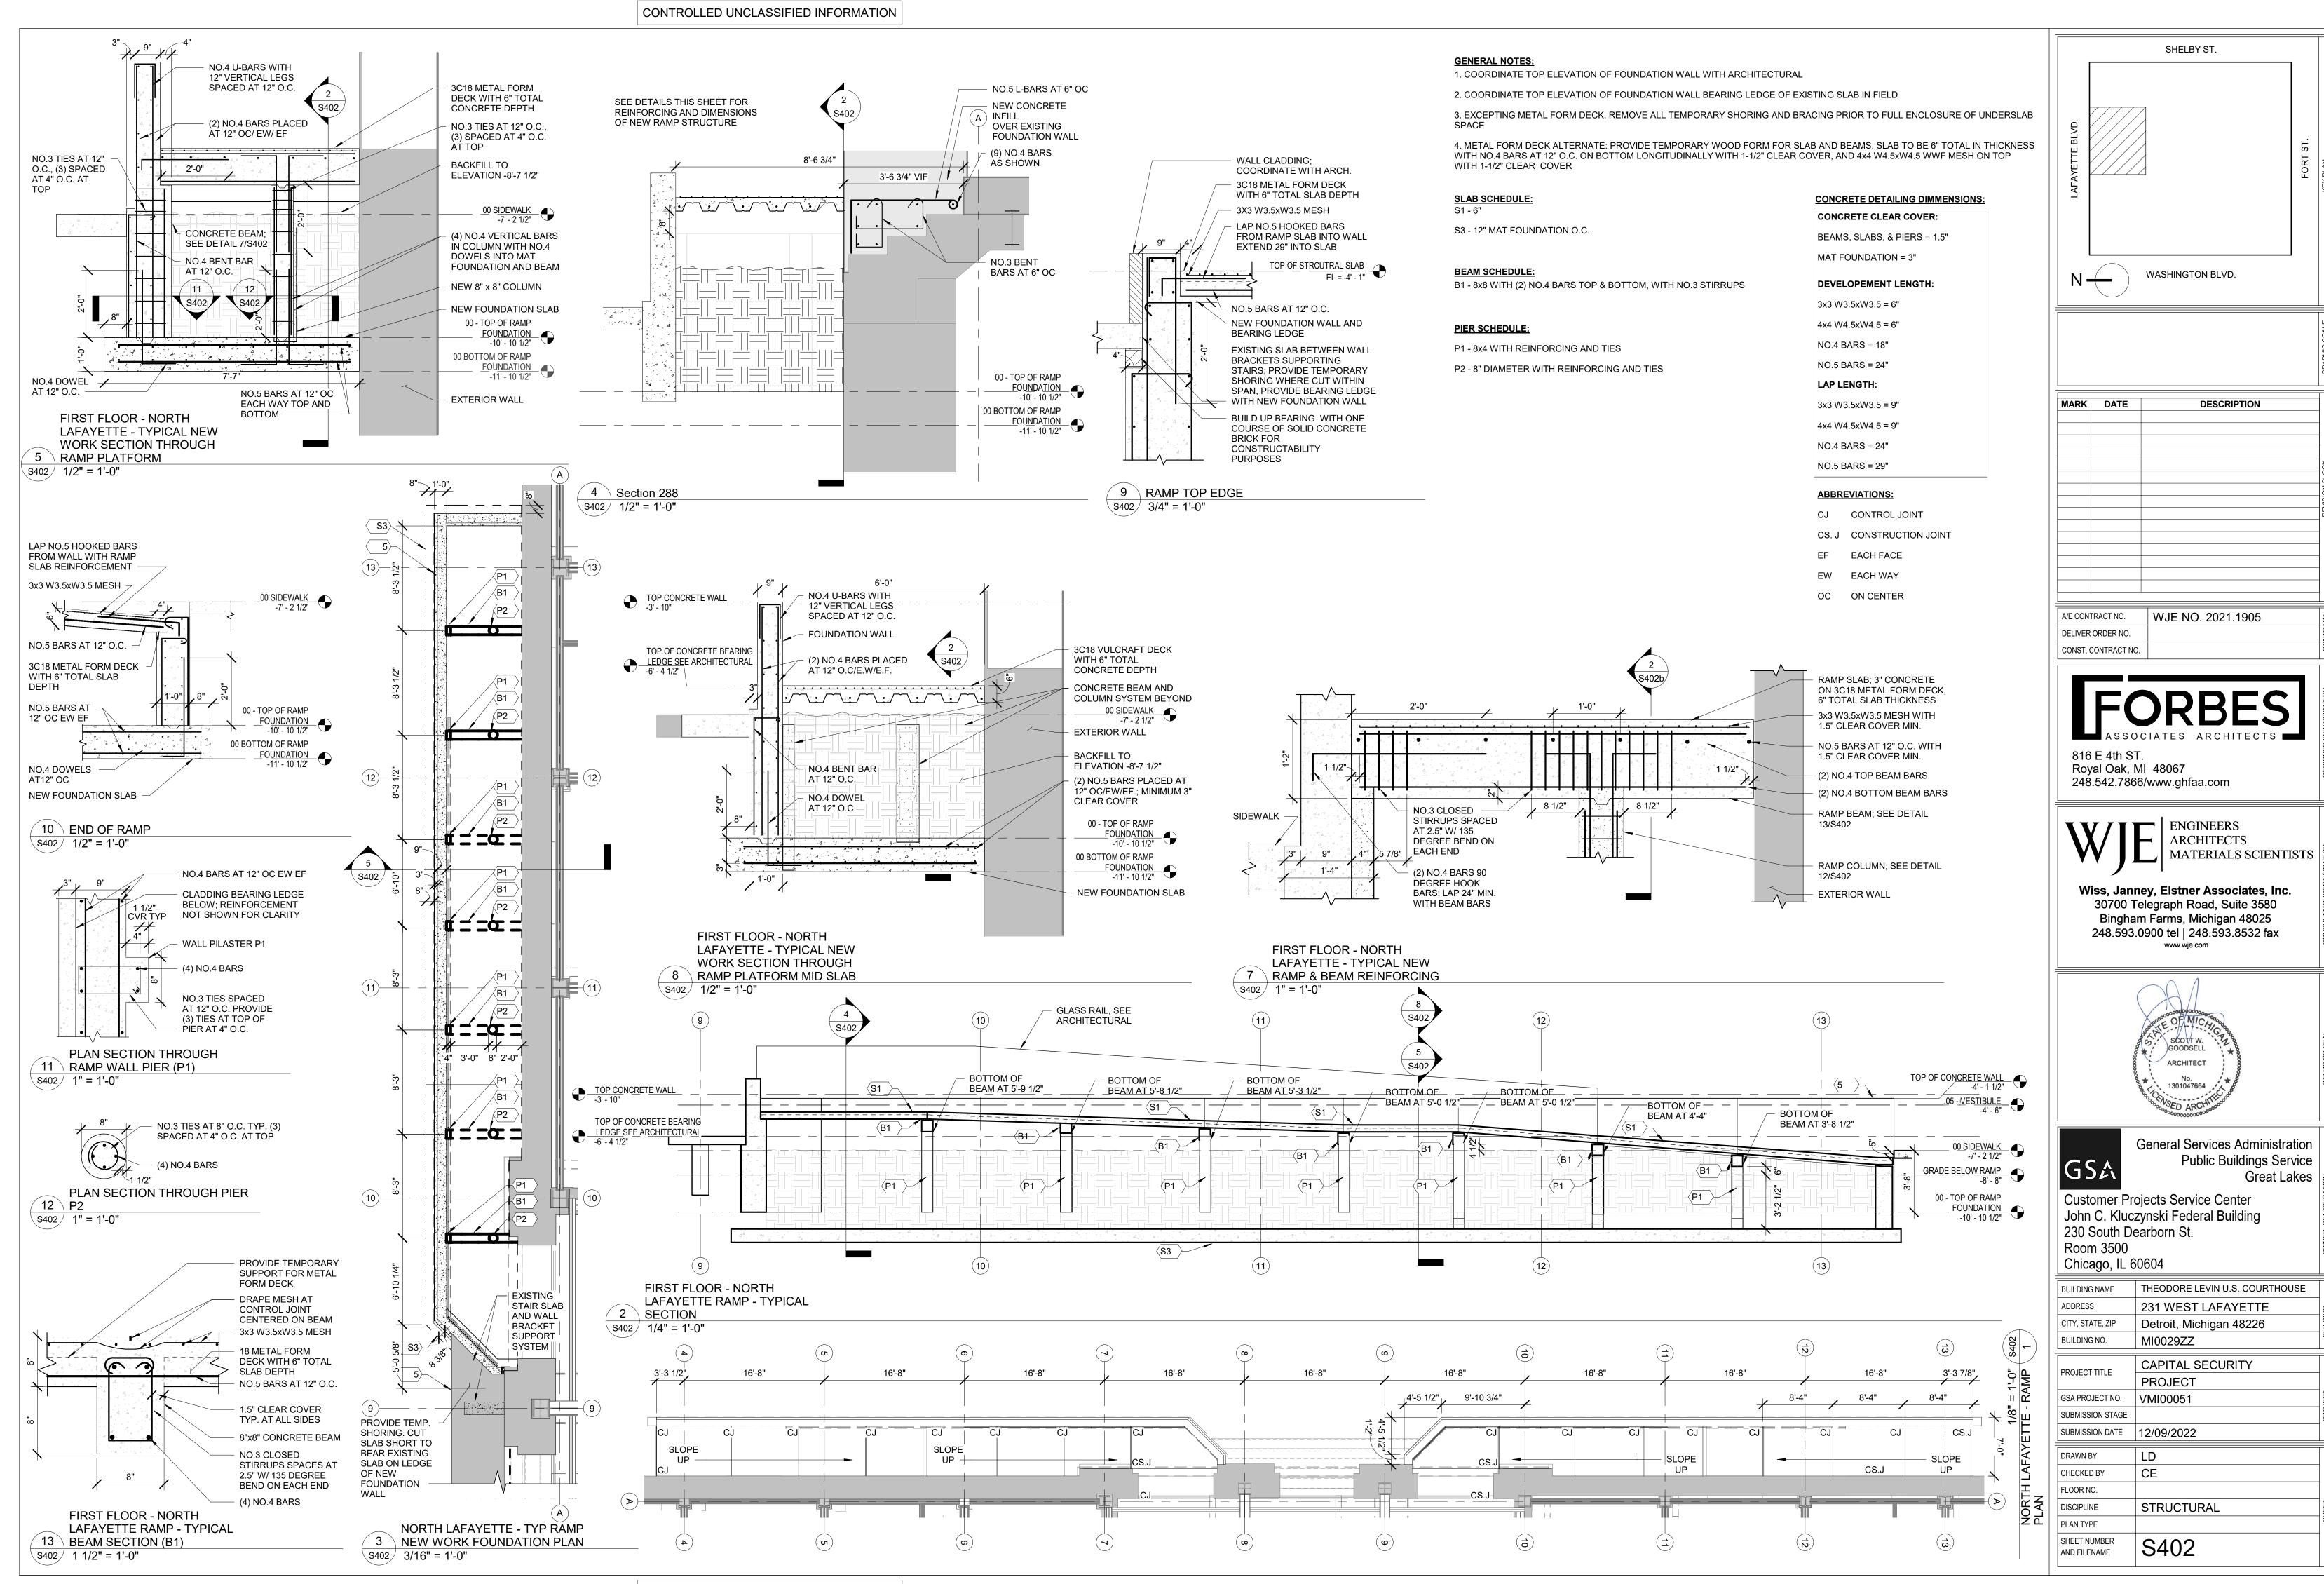

FIRST FLOOR - EXTERIOR RAMP MECHANICAL PLAN

SHEET METAL GENERAL NOTES:


- THESE DRAWINGS ARE DIAGRAMMATIC, AND REPRESENT THE GENERAL INTENT AND ARRANGEMENT OF SYSTEMS. THEY ARE NOT TO BE CONSIDERED FABRICATION/COORDINATION/SHOP DRAWINGS. COORDINATION WITH OTHER TRADES IS REQUIRED. PROVIDE THE ADDITIONAL FITTINGS AND OFFSETS THAT WILL BE REQUIRED TO COMPLETE EACH SYSTEM AND TO AVOID INTERFERENCES WITH ALL OTHER SYSTEMS INCLUDING THE STRUCTURE, PIPING SYSTEMS, ELECTRICAL CONDUITS, BUS DUCTS, CABLE TRAY, LIGHT FIXTURES, ETC. AND/OR OTHER SPACE CONSTRAINTS.
- 2 INSTALL SYSTEMS SUCH THAT REQUIRED CLEARANCE AND SERVICE ACCESS SPACE IS PROVIDED AROUND ALL MECHANICAL AND ELECTRICAL EQUIPMENT, AND AROUND ANY COMPONENTS WHICH REQUIRE SERVICE ACCESS.
- 3 PIPING AND DUCTWORK SHALL NOT BE INSTALLED ABOVE ELECTRICAL TRANSFORMERS, SWITCHBOARDS, PANELBOARDS OR MOTOR CONTROL
- 4 COORDINATE AND PROVIDE ACCESS DOORS WITHIN INACCESSIBLE CEILING, SHAFT, AND CHASE AREAS FOR ALL COMPONENTS WHICH REQUIRE SERVICE ACCESS. REFER TO ARCHITECTURAL DRAWINGS FOR CEILING TYPES.
- 5 PROVIDE SUPPLEMENTARY STEEL AS REQUIRED FOR THE PROPER SUPPORT OF ALL SYSTEMS.
- 6 REFER TO ARCHITECTURAL REFLECTED CEILING PLANS FOR DIMENSIONED LOCATION OF GRILLES, REGISTERS, AND DIFFUSERS.
- 7 REFER TO TEMPERATURE CONTROLS STANDARD MOUNTING HEIGHTS DETAIL FOR ELEVATIONS OF WALL MOUNTED TEMPERATURE CONTROL DEVICES

HVAC PIPING GENERAL NOTES:

- THESE DRAWINGS ARE DIAGRAMMATIC, AND REPRESENT THE GENERAL INTENT AND ARRANGEMENT OF SYSTEMS. THEY ARE NOT TO BE CONSIDERED FABRICATION/COORDINATION/SHOP DRAWINGS. COORDINATION WITH OTHER TRADES IS REQUIRED. PROVIDE THE ADDITIONAL FITTINGS AND OFFSETS THAT WILL BE REQUIRED TO COMPLETE EACH SYSTEM AND TO AVOID INTERFERENCES WITH ALL OTHER SYSTEMS INCLUDING THE STRUCTURE, SHEET METAL, OTHER PIPING SYSTEMS, ELECTRICAL CONDUITS, BUS DUCTS, CABLE TRAY, LIGHT FIXTURES, ETC. AND/OR OTHER SPACE CONSTRAINTS.
- 2 INSTALL SYSTEMS SUCH THAT REQUIRED CLEARANCE AND SERVICE ACCESS SPACE IS PROVIDED AROUND ALL MECHANICAL AND ELECTRICAL EQUIPMENT, AND AROUND ANY COMPONENTS WHICH REQUIRE SERVICE ACCESS.
- 3 PIPING AND DUCTWORK SHALL NOT BE INSTALLED ABOVE ELECTRICAL TRANSFORMERS, SWITCHBOARDS, PANELBOARDS OR MOTOR CONTROL
- 4 COORDINATE AND PROVIDE ACCESS DOORS WITHIN INACCESSIBLE CEILING, SHAFT, AND CHASE AREAS FOR ALL COMPONENTS WHICH REQUIRE SERVICE ACCESS. REFER TO ARCHITECTURAL DRAWINGS FOR CEILING TYPES.
- 5 PROVIDE SUPPLEMENTARY STEEL AS REQUIRED FOR THE PROPER SUPPORT OF ALL SYSTEMS.
- 6 SUBMIT PROPOSED METHODS OF ANCHORING AND GUIDING PIPING SYSTEMS TO STRUCTURAL ENGINEER FOR APPROVAL.
- 7 COORDINATE LOCATION OF DUCT-MOUNTED HYDRONIC DEVICES WITH SHEET METAL TRADES.
- BRANCH PIPING SERVING TERMINAL UNIT HEATING COILS OR RADIANT CEILING PANELS SHALL BE 3/4" UNLESS OTHERWISE NOTED. BRANCH PIPING SERVING MORE THAN ONE TERMINAL UNIT HEATING COIL SHALL BE 1" UNLESS OTHERWISE NOTED. BRANCH PIPING SERVING HOT WATER UNIT HEATERS AND CABINET UNIT HEATERS SHALL BE 1" UNLESS OTHERWISE NOTED.
- 9 REFER TO TEMPERATURE CONTROLS STANDARD MOUNTING HEIGHTS DETAIL FOR ELEVATIONS OF WALL MOUNTED TEMPERATURE CONTROL DEVICES.

CONSTRUCTION KEYED NOTES:

- PROVIDE DUCT MOUNTED MAN BARS AT WALL PENETRATION. REFER TO RETURN/SUPPLY AIR DUCT PENETRACTION AND HVAC DUCT MANBAR ELEVATION ON M603.
- 2 SLAB SENSOR FOR SNOWMELT SYSTEM, COORDINATE LOCATION WITH SNOW/ICE SENSOR AND INSTALL PER MANUFACTURERS GUIDELINES.
- 3 SNOW/ICE SENSOR COORIDNATION LOCAITON WITH SLAB SENSOR. INSTALL SENSOR PER MANUFACTURERS GUIDELINES.
- 4 ROUTE 3 CONDUCTOR, 18 GA WIRE FROM APC-4C IN AREA B TO SC-40 CONTROLLER IN AREA A.
- FOUTE 3 CONDUCTOR, 18 GA WIRE FROM APC-4C IN AREA B OF BASEMENT TO AERIAL SNOW SENSOR ON 3RD FLOOR MECHANICAL ROOM ROOF, REFER TO M103.

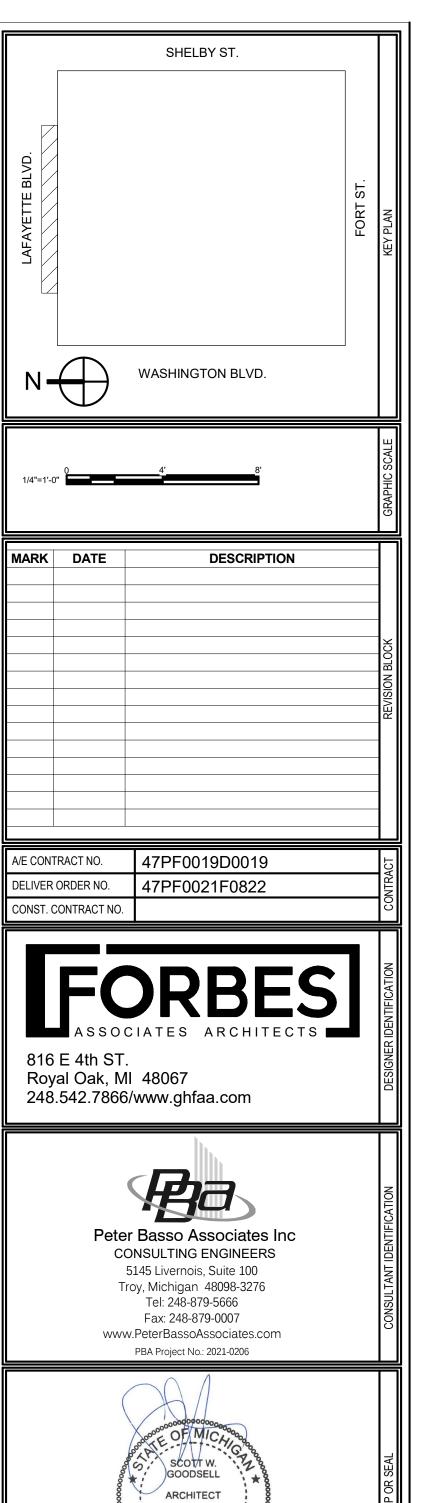



THEODORE LEVIN U.S. COURTHOUSE

Public Buildings Service

General Services Administration
Public Buildings Service
Great Lakes

Customer Projects Service Center John C. Kluczynski Federal Building 230 South Dearborn St. Room 3500 Chicago, IL 60604

BUILDING NAME

SHEET NUMBER

AND FILENAME

ADDRESS	231 WEST LAFAYETTE	9
CITY, STATE, ZIP	Detroit, Michigan 48226	BUILDING
BUILDING NO.	MI0029ZZ	<u> </u>
PROJECT TITLE	CAPITAL SECURITY	$\overline{\prod}$
PROJECT TITLE	PROJECT	
GSA PROJECT NO.	VMI00051	PROJECT
SUBMISSION STAGE		PRO
SUBMISSION DATE	12/09/2022	
DRAWN BY	RLT	
CHECKED BY	DC	
FLOOR NO.	FIRST FLOOR]
DISCIPLINE	MECHANICAL	SHEET
PLAN TYPE	FLOOR PLAN	S
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M101C




LIGHTING GENERAL NOTES:

- THESE DRAWINGS REPRESENT THE GENERAL EXTENT AND ARRANGEMENT OF SYSTEMS, BUT ARE NOT TO BE CONSIDERED FABRICATION DRAWINGS. COORDINATE WITH OTHER TRADES, AND PROVIDE EACH SYSTEM COMPLETE, INCLUDING ALL NECESSARY COMPONENTS, FITTINGS, AND OFFSETS.
- PROVIDE SUPPLEMENTARY STEEL AS REQUIRED FOR THE PROPER SUPPORT OF ALL SYSTEMS.
- COORDINATE THE MOUNTING HEIGHTS OF DEVICES WITH ARCHITECTURAL ELEVATIONS AND THE TRADES INSTALLING THE WORK.
- CIRCUIT EXIT LIGHT FIXTURES TO ADJACENT NORMAL POWER CIRCUIT IN AREA SERVED.
- REFER TO DEMOLITION PLANS FOR AREAS OF NEW WORK ASSOCIATED WITH CEILING REMOVAL AND REPLACEMENT.
- 6 WHERE APPLICABLE, EXISTING CONDUIT AND CIRCUITING TO BE REUSED FOR NEW LIGHT FIXTURES.
- WHEN NECESSARY TO ACCOMODATE FIXTURE ACCORDING TO MANUFACTURER'S INSTALLATION INSTRUCTIONS, CEILING PATCHING SHALL BE PERFORMED TO MATCH ADJACENT UNDISTURBED CEILING.
- REFER TO TEMPERATURE CONTROLS SHEETS FOR REQUIRED FIRE ALARM CONTROL MODULES, DUCT SMOKE DETECTORS, AND MOTOR CONTROLLERS. PROVIDE ALL ACCESSORIES INDICATED.
- THE FIRE ALARM DEVICES SHOWN ON PLAN ARE A PARTIAL REPRESENTATION OF THE FIRE ALARM SYSTEM. PROVIDE THE DESIGN AND INSTALLATION OF A COMPLETE AND FUNCTIONAL FIRE ALARM SYSTEM IN ACCORDANCE WITH THE SPECIFICATIONS. DRAWINGS, AND ALL APPLICABLE CODES. THE FIRE ALARM VENDOR SHALL PROVIDE LAYOUT DRAWINGS INDICATING THE REQUIRED QUANTITIES AND LOCATIONS OF MANUAL PULL STATIONS, NOTIFICATION APPLIANCES, SMOKE AND HEAT DETECTORS, CONTROL MODULES, INTERFACE MODULES, MODULES FOR SPRINKLER FLOW AND TAMPER SWITCHES, ALL CONTROL PANELS, POWER SUPPLIES, AND ADDITIONAL DEVICES AND EQUIPMENT REQUIRED. COORDINATE LOCATIONS OF DEVICES WITH ARCHITECTURAL FINISHES AND REFLECTED CEILING PLANS, INCLUDING ADDITIONAL SMOKE AND HEAT DETECTORS REQUIRED FOR NON-SMOOTH CEILING APPLICATIONS. INCLUDE ALLOWANCES FOR ADJUSTMENT OF DEVICES BY THE ARCHITECT AT THE TIME OF SUBMITTAL TO COORDINATE WITH BUILDING FINISHES AND OTHER CEILING ELEMENTS.
- REFER TO LIGHTING CONTROL SCHEDULE FOR ROOM CONTROL AND EMERGENCY LIGHTING CIRCUIT CONTROL REQUIREMENTS. DESIGNATION FOR ROOM IS INDICATED AS A LETTERED OVAL SYMBOL.
- ALL FIRE ALARM DEVICES SHALL BE COMPATIBLE WITH EXISTING FIRE ALARM SYSTEM. PROVIDE NECESSARY COMPONENTS, MODULES, ETC. AS REQUIRED FOR A FULLY FUNCTIONAL SYSTEM. RE-TEST AND CERTIFY EXISTING FIRE ALARM SYSTEM AT COMPLETION OF PROJECT.

CONSTRUCTION KEYED NOTES:

- NOT USED.
- PROVIDE (1) MOLDED POLYCARBONATE ENCLOSURE FOR EACH LIGHTED RAIL TO HOUSE 2 DRIVERS REQUIRED FOR RAIL LIGHTING, LOCATE IN BASEMENT WITHIN 29' OF RAIL CONNECTION POINT. PROVIDE 16AWG WIRE GAUGE. CONCEAL CONDUIT WITHIN RAMP AND STUB UP AT POLE CONNECTION. PROVIDE INSTALLATION SHOP DRAWINGS OF HANDRAIL FOR REVIEW.
- LIGHTED HANDRAIL FIXTURE TYPE L9. COORDINATE EXACT LOCATIONS AND HEIGHTS WITH ARCHITECTURAL ELEVATIONS. PROVIDE INSTALLATION SHOP DRAWINGS OF HANDRAIL FOR REVIEW.
- REPLACE COVE LIGHTING IN COVE ABOVE WITH FIXTURE TYPE L4 TAPE LIGHT. VERIFY EXACT LENGTHS REQUIRED IN FIELD.
- EMERGENCY LIGHTING NOTATED WITH E SUFFIX. EMERGENCY LIGHTING TO BE CIRCUITED TO EXISTING AREA EMERGENCY LIGHTING CIRCUIT. VERIFY IN FIELD.
- ALL LIGHTING IN PRISONER AREAS SHALL BE CONTROLLED FROM COMMAND AND CONTROL CENTER. CONTROLS TO BE MANUAL ON/OFF. CIRCUIT NEW FIXTURES TO INDICATED NORMAL CIRCUIT. ALL LIGHTING IN PRISONER AREAS SHALL INCLUDE INTEGRAL EMERGENCY BATTERY BACKUP.
- COORDINATE PLACEMENT OF L10E FIXTURES WITH EXISTING AND NEW PIPING, DUCTWORK, STRUCTURE, AND CONDUIT AS REQUIRED. MAINTAIN FOOTCANDLE LEVEL OF 46 THROUGHOUT SALLYPORT AREA.
- CONNECT NEW LIGHTING FIXTURES TO EXISTING LIGHTING BRANCH CIRCUIT.
- 9 CENTER TYPE L11 FIXTURE WITHIN SLANTED CEILING. AIM FIXTURE IN FIELD TO OPTIMAL ANGLE TO LIGHT LIFT BELOW.
- LIGHTED SIGNAGE, REFER TO ARCHITECTURAL ELEVATIONS FOR MOUNTING HEIGHTS. PROVIDE TYPE L13 FIXTURE TYPE ON BOTH TOP AND BOTTOM OF SIGN. CONDUIT AND WRING TO BE ROUTED UNDER RAMP AND TO ACCESS PANEL LOCATED AT RAMP WALL BEHIND SIGNAGE. PROVIDE INSTALLATION SHOP DRAWINGS OF LIGHTED SIGNAGE FOR REVIEW.

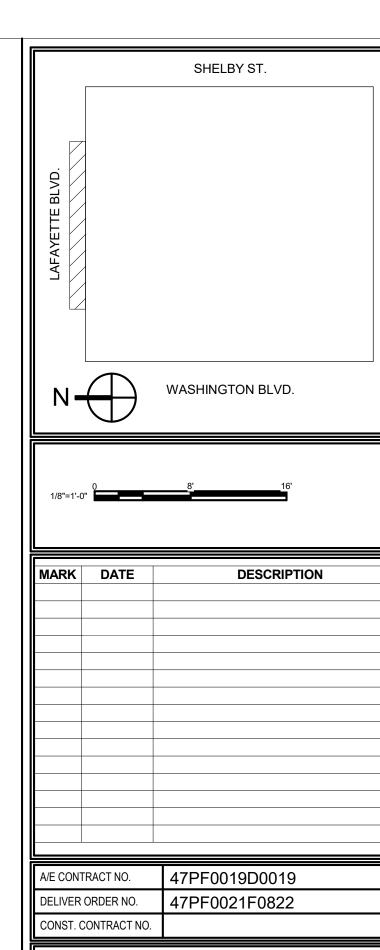

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Public Buildings Service

Great Lakes

General Services Administration

Chicago, IL 60604

Customer Projects Service Center John C. Kluczynski Federal Building 230 South Dearborn St. Room 3500

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SUBMISSION DATE	12/09/2022	
SUBMISSION STAGE		5
GSA PROJECT NO.	VMI00051	ļ
PROJECT TITLE	PROJECT	
	CAPITAL SECURITY	Ī
BUILDING NO.	MI0029ZZ	٥
CITY, STATE, ZIP	Detroit, Michigan 48226	
ADDRESS	231 WEST LAFAYETTE	٤
BUILDING NAME	THEODORE LEVIN U.S. COURTHOUSE	

DRAWN BY **EMG** CHECKED BY FLOOR NO. FIRST FLOOR DISCIPLINE **ELECTRICAL** PLAN TYPE **CEILING PLAN** SHEET NUMBER L104 AND FILENAME