10/08/2021

250 N HARTFORD AVE COLUMBUS, OHIO 43222 PHONE: 614.589.0087


METRO ENGINEERING SOLUTIONS

33900 SCHOOLCRAFT RD LIVONIA, MICHIGAN 48150 PHONE: 734.483.1427 FAX: 734.483.3431 www.metroes.net



October 7, 2021

CONTRACTOR/AS-BUILT

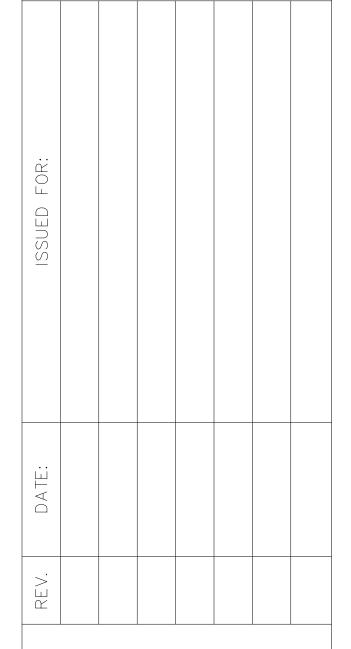

SITE NAME:

DET-003

SHELBY & GRISWOLD

JOB: 1035-21-1595_DS

DRAW DATE: 09/29/21

PLOT DATE: 10/7/21

DRAWN BY: JRG

TITLE: COVER

SHEET: 01 OF 11

Lot G - 151 Adams Ave. Clifford-St Parking Library Park Grand River Ave Lot 7 Capitol Michigan Ave n Ave Campus Martius

OWNER
IKE SMART CITY
250N HARTFORD AVE
COLUMBUS, OH 43222
CONTACT: HARDIN, MATTHEW
PHONE: (614) 209-6400
EMAIL: MHARDIN@IKESMARTCITY.COM

KIOSK MANUFACTURER
DISPLAY DEVICE INC.
21075 WESTGATE RD
GOLDEN, CO 80403
CONTACT: PERKINS, ERIC
PHONE: (303)929-4071

ENGINEER
METRO ENGINEERING SOLUTIONS
33900 SCHOOLCRAFT RD
LIVONIA, MI 48150
CONTACT: GAMBLE, JUSTIN
PHONE: (734)308-4886

EMAIL: JGAMBLE@METROES.NET

DRAWING INDEX

NO. DESCRIPTION
01 TITLE
02 CITY OF DETROIT SPECS

03 PLAN VIEW
04 RESTORATION PLAN
05-06 IKE KIOSK SPECS
07 FOUNDATION SPECS
08 ADA SPECS


09 CONSTRUCTION NOTES

10-11 M.O.T.

Know what's below.
Call before you dig.

CONSTRUCTION SITE SAFETY IS THE RESPONSIBILITY OF THE CONTRACTOR. NEITHER THE OWNER NOR THE ENGINEER SHALL BE EXPECTED TO ASSUME ANY RESPONSIBILITY FOR SAFETY OF THE WORK, OF PERSONS ENGAGED IN THE WORK, OF ANY NEARBY STRUCTURES OR OF ANY OTHER PERSONS

THE LOCATIONS OF EXISTING UNDERGROUND UTILITIES ARE SHOWN IN AN APPROXIMATE WAY ONLY AND HAVE NOT BEEN INDEPENDENTLY VERIFIED. THE CONTRACTOR SHALL DETERMINE THE EXACT LOCATION OF ALL EXISTING UTILITIES BEFORE COMMENCING WORK, AND AGREES TO BE FULLY RESPONSIBLE FOR ANY AND ALL DAMAGES WHICH MIGHT BE OCCASIONED BY THE CONTRACTOR'S FAILURE TO EXACTLY LOCATE AND PRESERVE ANY AND ALL UNDERGROUND UTILITIES.

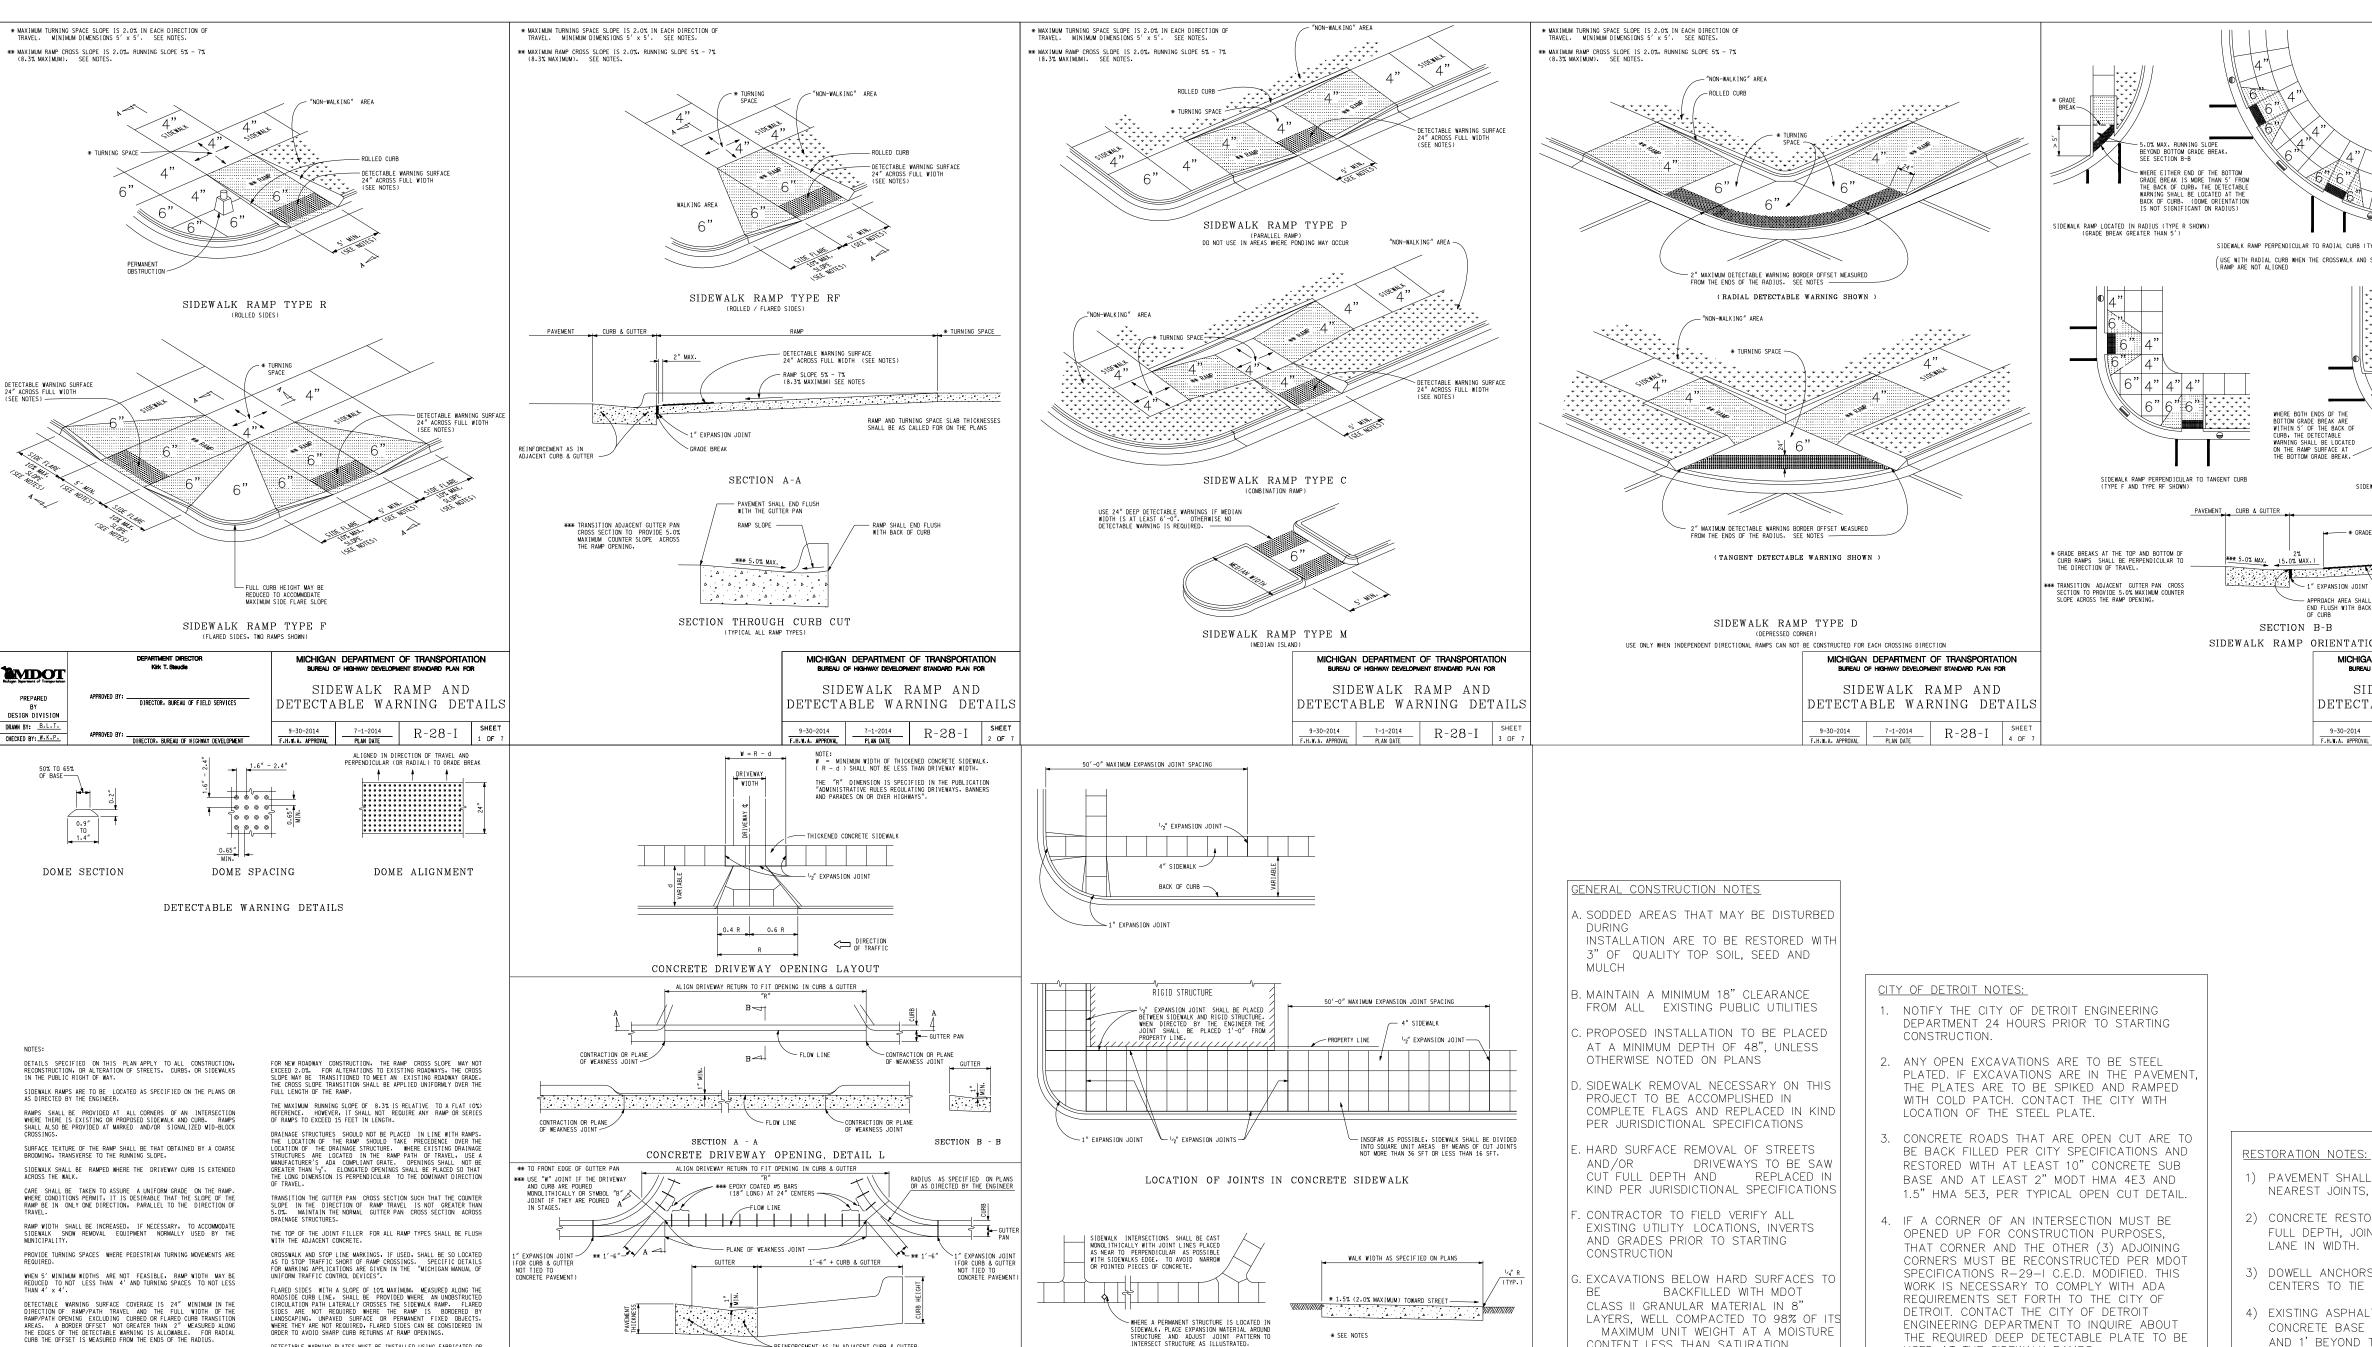

WHERE A PERMANENT STRUCTURE IS LOCATED IN SIDEWALK, PLACE EXPANSION MATERIAL AROUND STRUCTURE AND ADJUST JOINT PATTERN TO INTERSECT STRUCTURE AS ILLUSTRATED.

APPROVED BY: ________DIRECTOR, BUREAU OF FIELD SERVICES

TYPICAL SIDEWALK JOINT LAYOUTS

MDOT

DESIGN DIVISION

SHEET DRAWN BY: B.L.T.

7-1-2014 R-29-I SHEET UTAM UT. CHECKED BY: W.K.P.

* SEE NOTES


4" CONCRETE SIDEWALK

MICHIGAN DEPARTMENT OF TRANSPORTATION BUREAU OF HIGHWAY DEVELOPMENT STANDARD PLAN FOR

DRIVEWAY OPENINGS

& APPROACHES,

AND CONCRETE SIDEWALK

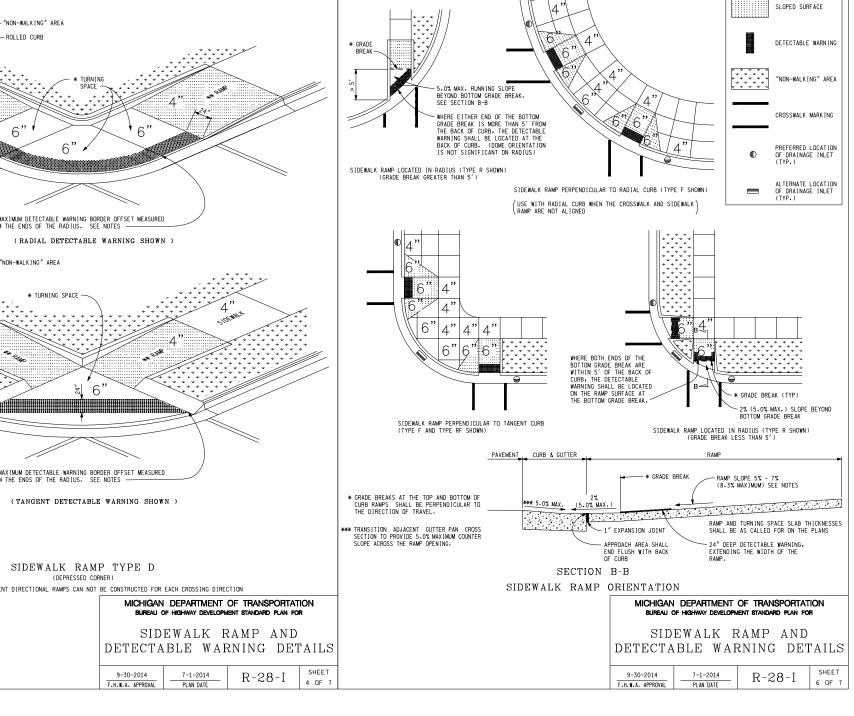

ENGINEERING DEPARTMENT TO INQUIRE ABOUT

5. THE CITY OF DETROIT REQUIRES ALL CONCRETE

SEE THE CITY OF DETROIT CONSTRUCTION

WORK TO BE STAMPED WITH A CONTRACTORS

SPECIFICATIONS MANUAL FOR STANDARDS THAT

USED AT THE SIDEWALK RAMPS.

FIT YOUR SPECIFIC JOB NEEDS.

IDENTIFICATION STAMP.

THE REQUIRED DEEP DETECTABLE PLATE TO BE

- 1) PAVEMENT SHALL BE MILLED DOWN TO LOCATE NEAREST JOINTS, AT FULL LANE WIDTH.
- 2) CONCRETE RESTORATION SHALL BE PERFORMED AT FULL DEPTH, JOINT TO JOINT, AND AT LEAST (1)

LEGEND


- 3) DOWELL ANCHORS SHALL BE INSTALLED AT 18" CENTERS TO TIE INTO EXISTING PAVEMENT.
- 4) EXISTING ASPHALT SHALL BE MILLED DOWN TO CONCRETE BASE 1' BEYOND CONCRETE RESTORATION, AND 1' BEYOND THAT TO A DEPTH OF 1.5"
- 5) RESTORATION OF ASPHALT SHALL BE PERFORMED IN 2 LIFTS. a) FIRST LIFT SHALL CONSIST OF 2" OF
- MDOT 4E3 LEVELING MIX. b) SECOND LIFT SHALL CONSIST OF 1.5" OF MDOT 5E3 SURFACING MIX, AND SHALL BRING RESTORATION TO GRADE

COLUMBUS, OHIO 43222 PHONE: 614.589.0087 **METRO ENGINEERING SOLUTIONS** 33900 SCHOOLCRAFT RD

LIVONIA, MICHIGAN 48150

PHONE: 734.483.1427 FAX: 734.483.3431 www.metroes.net

250 N HARTFORD AVE

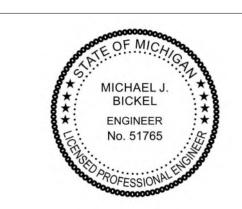

October 7, 2021 CONTRACTOR/AS-BUILT

SITE NAME: DET-003 SHELBY & GRISWOLD

1035-21-1595_DS JOB: DRAW DATE: 09/29/21 PLOT DATE: 10/7/21 DRAWN BY: JRG TITLE: DETROIT SPEC SHEET: 02 OF 11

CONSTRUCTION SITE SAFETY IS THE RESPONSIBILITY OF THE CONTRACTOR. NEITHER THE OWNER NOR THE ENGINEER SHALL BE EXPECTED TO ASSUME ANY RESPONSIBILITY FOR SAFETY OF THE WORK, OF PERSONS ENGAGED IN THE WORK, OF ANY NEARBY STRUCTURES, OR OF ANY OTHER PERSONS.

DETECTABLE WARNING PLATES MUST BE INSTALLED USING FABRICATED OR FIELD CUT UNITS CAST AND/OR ANCHORED IN THE PAVEMENT TO RESIST SHIFTING OR HEAVING.

MICHIGAN DEPARTMENT OF TRANSPORTATION BUREAU OF HIGHWAY DEVELOPMENT STANDARD PLAN FOR

SIDEWALK RAMP AND

DETECTABLE WARNING DETAILS

9-30-2014 7-1-2014 R-28-I SHEET 7 OF

COPYRIGHT (C) 2021 METRO ENGINEERING SOLUTIONS; ALL RIGHTS RESERVED.

THE LOCATIONS OF EXISTING UNDERGROUND UTILITIES ARE SHOWN IN AN APPROXIMATE WAY ONLY AND HAVE NOT BEEN INDEPENDENTLY VERIFIED. THE CONTRACTOR SHALL DETERMINE THE EXACT LOCATION OF ALL EXISTING UTILITIES BEFORE COMMENCING WORK, AND AGREES TO BE FULLY RESPONSIBLE FOR ANY AND ALL DAMAGES WHICH MIGHT BE OCCASIONED BY THE CONTRACTOR'S FAILURE TO EXACTLY LOCATE AND PRESERVE ANY AND ALL UNDERGROUND UTILITIES.

MAXIMUM UNIT WEIGHT AT A MOISTURE

CONTENT LESS THAN SATURATION

.TEST HOLES TO BE CONSTRUCTED AS A

REMOVED USING A VACUUM TRUCK. HOLE

TO BE BACKFILLED USING A GRANULAR

EXISTING PAVEMENT. PAVEMENT TO BE

12" CYLINDRICAL HOLE. SOIL TO BE

MATERIAL TO THE BOTTOM OF THE

REPLACED IN KIND PER MDOT

SPECIFICATIONS



REINFORCEMENT AS IN ADJACENT CURB & GUTTER

MICHIGAN DEPARTMENT OF TRANSPORTATION BUREAU OF HIGHWAY DEVELOPMENT STANDARD PLAN FOR

DRIVEWAY OPENINGS

& APPROACHES,

AND CONCRETE SIDEWALK

SECTION A - A

CONCRETE DRIVEWAY OPENING, DETAIL M

NUIL:
FOR ROADWAYS WITH CONCRETE PAVEMENTS, LONGITUDINAL LANE TIES WILL
BE CONTINUOUS THROUGH THE OFFICENCY OPENING AND THE SPACING OF THE
#5 BARS IN CONCRETE DRIVEWAYS SHALL BE ADJUSTED TO AVOID CONFLICT
WITH THE LONGITUDINAL LANE TIES.



- 1. IT IS THE CONTRACTOR'S RESPONSIBILITY TO VERIFY ALL LOCATIONS, ELEVATIONS, AND DIMENSIONS OF ADJACENT AND/OR CONFLICTING UTILITIES SUFFICIENTLY IN ADVANCE OF CONSTRUCTION SO THAT ADJUSTMENTS CAN BE MADE TO PROVIDE ADEQUATE CLEARANCES. ANY DISCREPANCY FOUND SHALL BE BROUGHT TO THE OWNER AND ENGINEER BEFORE CONSTRUCTION HAS COMMENCED. THE CONTRACTOR SHALL PRESERVE AND PROTECT PUBLIC UTILITIES AT ALL TIMES DURING CONSTRUCTION. ANY DAMAGE TO UTILITIES RESULTING FROM CONTRACTOR'S OPERATIONS SHALL BE RESTORED AT THE CONTRACTOR'S EXPENSE.
- 2. ONCE THE FOUNDATION HAS BEEN LOCATED, THE CONTRACTOR SHALL RECEIVE SPOT—PAINT THE FOUR CORNERS OF THE FOUNDATION ON THE GROUND SURFACE FOR REVIEW BY THE OWNER. THE CONTRACTOR SHALL NOT EXCAVATE FOR THE FOUNDATION UNTIL AUTHORIZED BY THE OWNER'S REPRESENTATIVE.
- THE FIELD PRIOR TO COMMENCING CONSTRUCTION AND NOTIFY THE OWNER AND ENGINEER OF ANY CONFLICTS. 4. ALL AREAS DISTURBED DURING CONSTRUCTION SHALL BE RESTABILIZED PER THE PLANS. THE CONTRACTOR SHALL TAKE ALL NECESSARY PRECAUTIONS TO KEEP DRAINAGE AND SILT FROM WASHING ONTO ADJACENT PROPERTY OR CROSSING ADJACENT STREETS. CONTRACTOR SHALL IMMEDIATELY REMOVE SILT/DEBRIS THAT WASHES OFF-SITE OR
- 5. REFER TO OVERALL SITE PLAN FOR PAVEMENT REPAIR INFORMATION.
- 6. POWER TYPE: 120/240, 1P / INTERNET CONNECTION: 4GLTE.

INTO EXISTING STORM DRAIN SYSTEMS.

- 7. THE CONTRACTOR AND/OR THE CONTRACTOR'S INDEPENDENTLY RETAINED EMPLOYEE OR STRUCTURAL DESIGN/GEOTECHNICAL/SAFETY/EQUIPMENT CONSULTANT, IF ANY, SHALL REVIEW THESE PLANS AND AVAILABLE GEOTECHNICAL INFORMATION AND THE ANTICIPATED INSTALLATION SITE(S) WITHIN THE PROJECT WORK AREA IN ORDER TO IMPLEMENT THE CONTRACTOR'S TRENCH EXCAVATION SAFETY PROTECTION SYSTEMS, PROGRAMS, AND/OR PROCEDURES FOR THE PROJECT DESCRIBED IN THE CONTRACT DOCUMENTS. THE CONTRACTOR'S IMPLEMENTATION OF THESE SYSTEMS, AND/OR PROCEDURES SHALL PROVIDE FOR ADEQUATE TRENCH EXCAVATION SAFETY PROTECTION THAT COMPLY WITH, AS A MINIMUM, OSHA STANDARDS FOR TRENCH EXCAVATIONS. SPECIFICALLY, THE CONTRACTOR AND/OR THE CONTRACTOR'S INDEPENDENTLY RETAINED EMPLOYEE OR SAFETY CONSULTANT SHALL IMPLEMENT A TRENCH SAFETY PROGRAM IN ACCORDANCE WITH OSHA STANDARDS GOVERNING THE PRESENCE AND ACTIVITIES OF INDIVIDUALS WORKING IN AND AROUND TRENCH EXCAVATION.
- 8. PROPOSED CONDUIT SHALL HAVE A MINIMUM OF 30 INCHES OF COVER AND SHALL MAINTAIN A MINIMUM CLEARANCE OF 12 INCHES FROM OTHER UTILITIES. IN CASE OF VERTICAL CONFLICT WITH EXISTING UTILITIES, THE CONTRACTOR MAY LOWER PROPOSED CONDUIT AT CROSSINGS TO MAINTAIN A 12 INCHES SEPARATION.
- 9. THE CONTRACTOR SHALL MAINTAIN 2 FEET OF CLEARANCE FROM ANY UNDERGROUND WATER OR SEWER INFRASTRUCTURE AND 4 FEET OF CLEARANCE FROM ANY ABOVE GROUND APPURTENANCES SUCH AS METERS, VALVE BOXES, MANHOLES, ETC.


- 1. ALL CONSTRUCTION ACTIVITIES SHALL BE COMPLETED IN FULL COMPLIANCE WITH THE AMERICANS WITH DISABILITIES
- 2. PROPOSED CLEAR FLOOR OR GROUND SPACE IN FRONT OF THE PROPOSED KIOSK SHALL BE SLOPED A MAX OF 1.50% (+/-0.50%) IN ALL DIRECTIONS AWAY FROM THE KIOSK. 3. THE MINIMUM WHEELCHAIR PASSAGE WIDTH OR CLEAR SPACE WIDTH FOR SINGLE WHEELCHAIR PASSAGE SHALL BE

32" AT A POINT AND 36" CONTINUOUSLY PER PROWAG 2011 STANDARD SECTION R404

(HTTPS: //WWW.ACCESS-BOARD.GOV/GUIDELINES-AND-STANDARDS/STREETS-SIDEWALKS/PUBLIC-RIGHTS-OF-WAY). 4. THE MINIMUM CLEAR FLOOR OR GROUND SPACE IN FRONT OF PROPOSED KIOSK REQUIRED TO ACCOMMODATE A SINGLE, STATIONARY WHEELCHAIR AND OCCUPANT IS 30" BY 48". THE MINIMUM CLEAR FLOOR OR GROUND SPACE MAY BE POSITIONED FOR FORWARD OR PARALLEL APPROACH. CLEAR FLOOR OR GROUND SPACE FOR WHEELCHAIRS SHALL BE CENTERED ON THE ELEMENT IT SERVES AND MAY BE PART OF THE KNEE SPACE REQUIRED UNDER

SOME OBJECTS.

1. INITIAL OPERATION FOR THE KIOSK WILL HAVE 4GLTE CONNECTION TO THE INTERNET

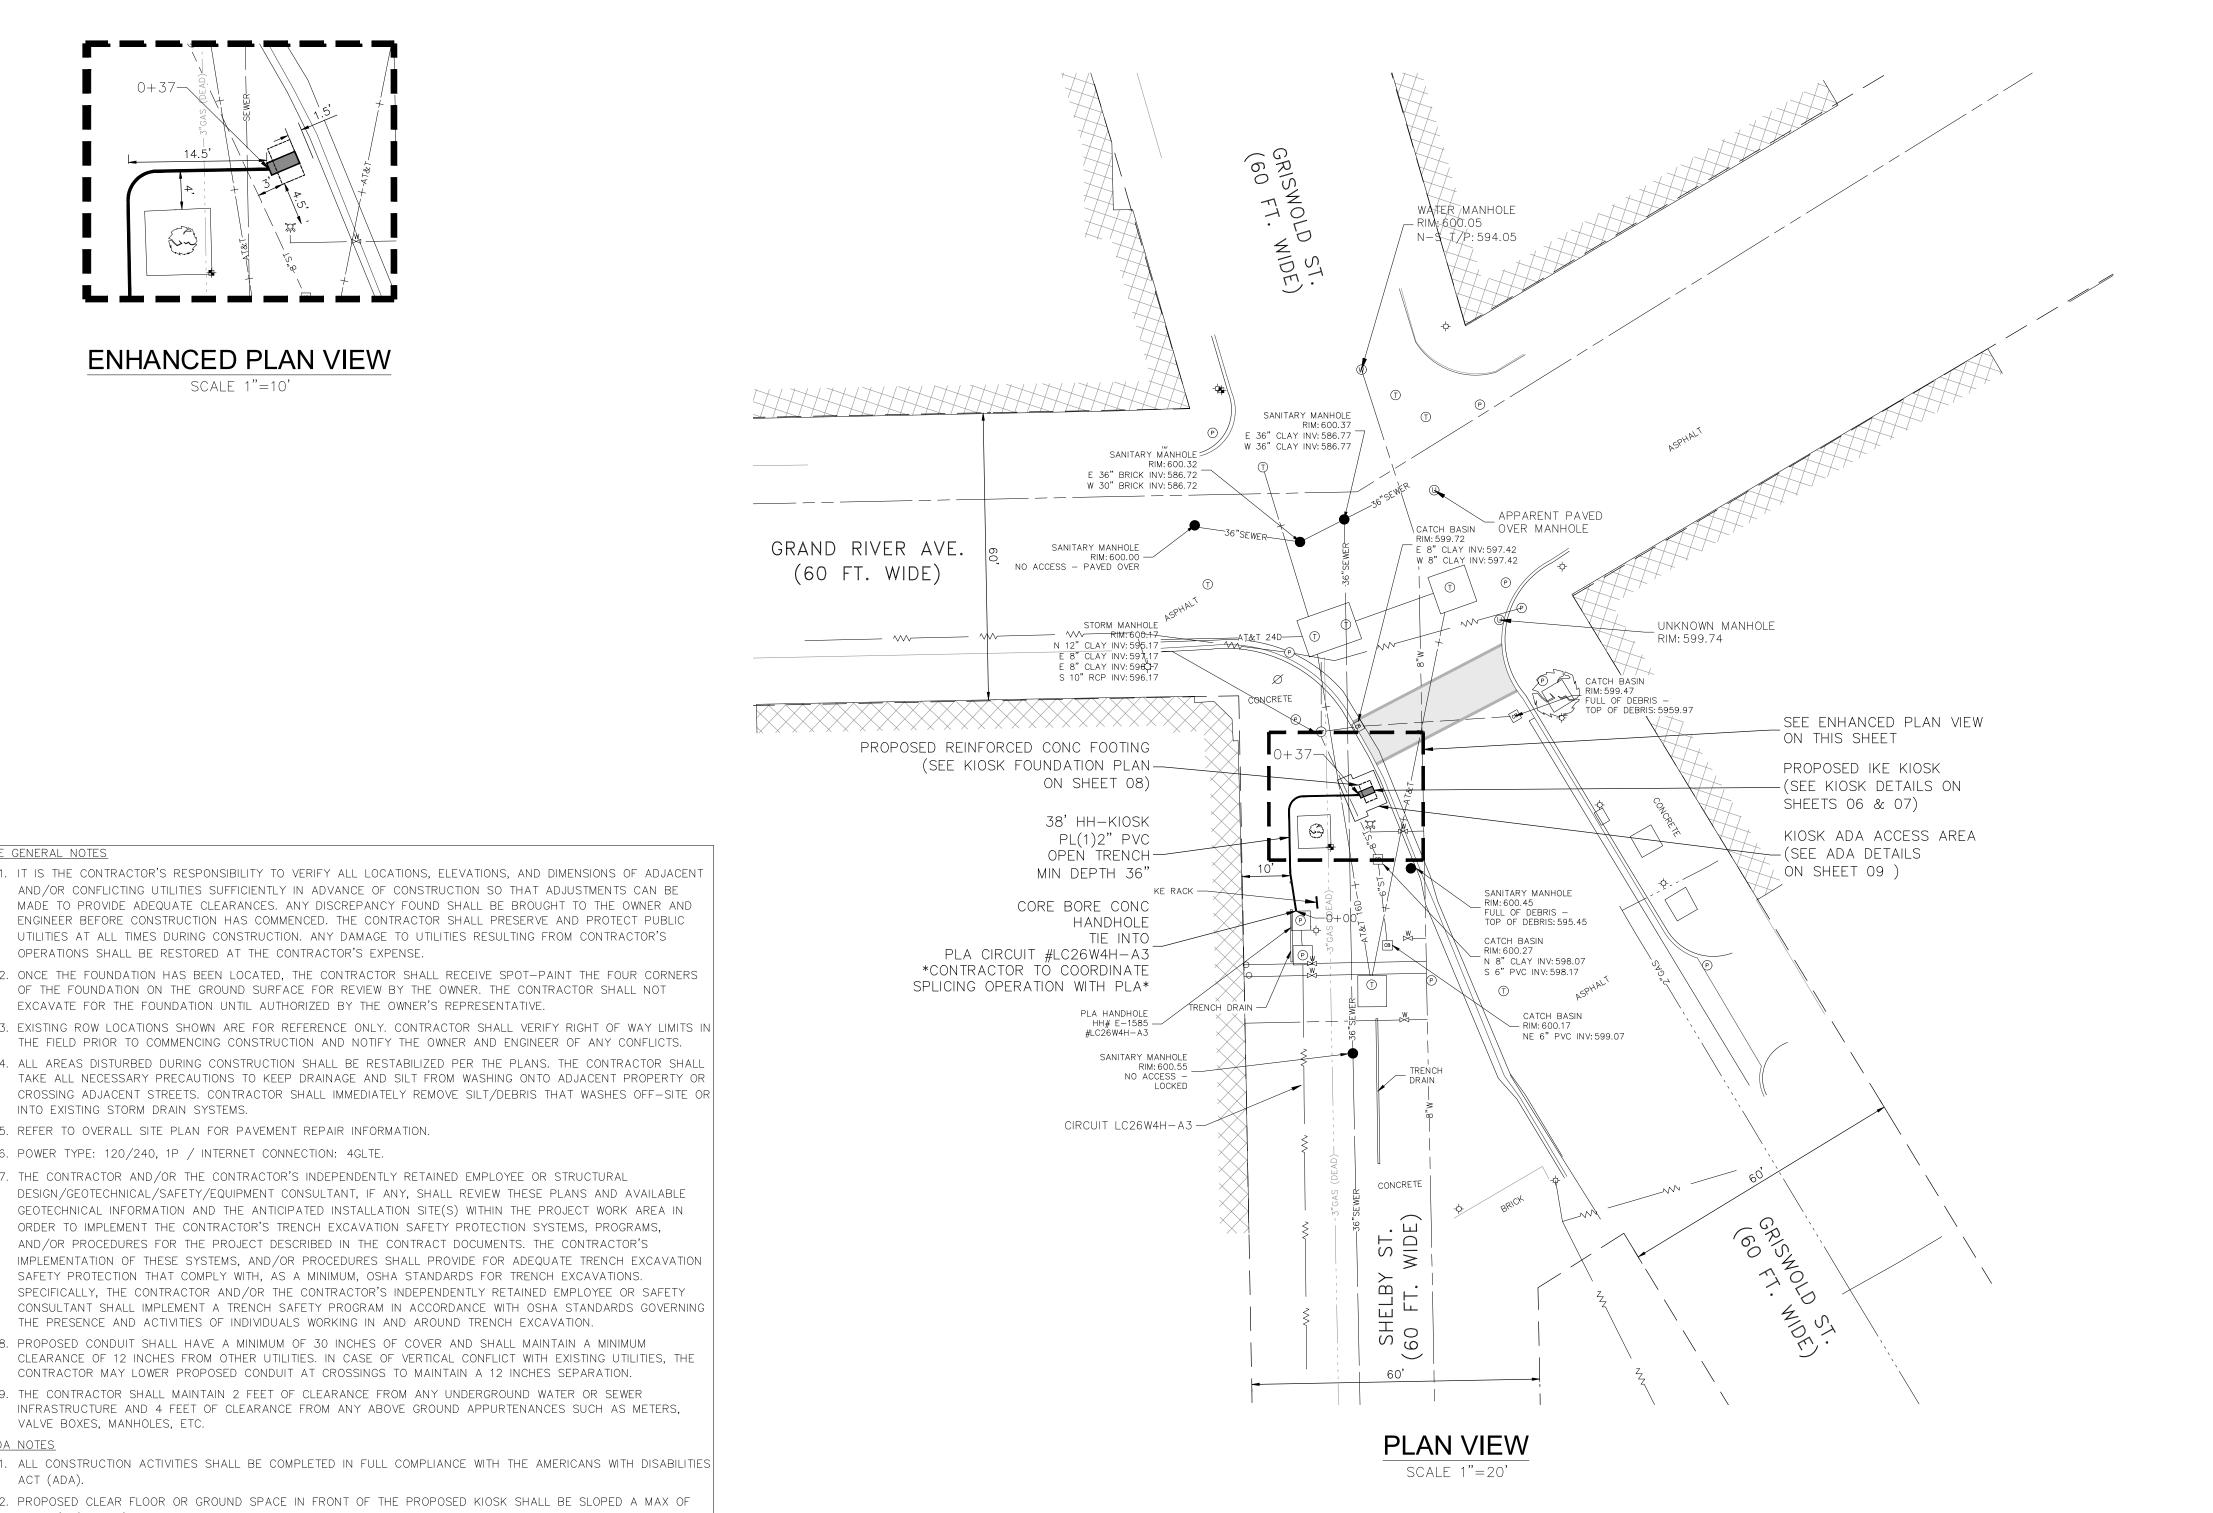

LEGEND		
× 656.5 652 	EX. SPOT ELEVATION EX. CONTOUR EX. WETLAND LIMITS EX. RIGHT OF WAY EX. EASEMENT LINE EX. & DITCH EX. CURB/PAVEMENT RR TRACK EX. FENCE EX. GRAVEL EX. GUARDRAIL EX. TREELINE EX. WATER MAIN EX. WATER MAIN EX. WATER MANHOLE EX. WHIL EX. WATER METER EX. STORM SEWER EX. STORM INLET/CATCH BASIN EX. STORM INLET/CATCH BASIN EX. STORM MANHOLE EX. SANITARY SEWER EX. SANITARY MANHOLE EX. UNDERGROUND GAS EX. GAS VALVE EX. OVERHEAD ELECTRIC EX. UNDERGROUND TELE EX. TELEPHONE MANHOLE EX. TELEPHONE MANHOLE EX. ELECTRIC METER EX. GAS METER EX. LIGHT POLE EX. TRAFFIC SIGNAL BOX EX. UNIDENTIFIED MANHOLE	
0	EX. LIGHT POLE EX. TRAFFIC SIGNAL BOX EX. UNIDENTIFIED MANHOLE EX. COMBO MANHOLE EX. TRAFFIC SIGNAL POLE	
© & X O MB OF OF - RR OF - NAIL	EX. UTILITY POLE EX. GUY WIRE EX. TREE (CONIFEROUS) EX. TREE (DECIDUOUS) EX. UTILITY CABINET EX. SIGN EX. MAILBOX FOUND IRON PIPE	
^O F−RR ^O F−NAIL ⊚ O _C	FOUND IRON ROD FOUND PK NAIL FOUND CONC. MONUMENT	

SET IRON ROD

- PROP IKE UNDG INSTALL

PROP IKE KIOSK & FOUNDATION

SET MAG NAIL EX. SECTION CORNER




METRO ENGINEERING SOLUTIONS

33900 SCHOOLCRAFT RD LIVONIA, MICHIGAN 48150 PHONE: 734.483.1427 FAX: 734.483.3431 www.metroes.net



October 7, 2021

CONTRACTOR/AS-BUILT

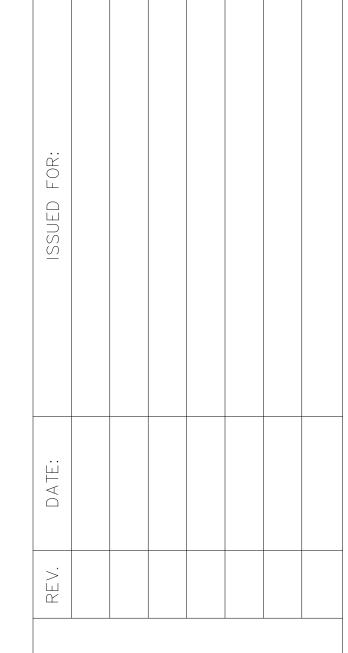

SITE NAME: DET-003 SHELBY & GRISWOLD

1035-21-1595_DS DRAW DATE: 09/29/21

PLOT DATE: 10/7/21

DRAWN BY: JRG TITLE: PLAN VIEW

SHEET: 03 OF 11

1 inch = 20 feet(11"x17" 1 inch = 40 feet)


GRAPHIC SCALE

Know what's **below.** Call before you dig.

CONSTRUCTION SITE SAFETY IS THE RESPONSIBILITY OF THE CONTRACTOR. NEITHER THE OWNER NOR THE ENGINEER SHALL BE EXPECTED TO ASSUME ANY RESPONSIBILITY FOR SAFETY OF THE WORK, OF PERSONS ENGAGED IN THE WORK, OF ANY NEARBY STRUCTURES, OR OF ANY OTHER PERSONS.

COPYRIGHT © 2021 METRO ENGINEERING SOLUTIONS; ALL RIGHTS RESERVED.

THE LOCATIONS OF EXISTING UNDERGROUND UTILITIES ARE SHOWN IN AN APPROXIMATE WAY ONLY AND HAVE NOT BEEN INDEPENDENTLY VERIFIED. THE CONTRACTOR SHALL DETERMINE THE EXACT LOCATION OF ALL EXISTING UTILITIES BEFORE COMMENCING WORK, AND AGREES TO BE FULLY RESPONSIBLE FOR ANY AND ALL DAMAGES WHICH MIGHT BE OCCASIONED BY THE CONTRACTOR'S FAILURE TO EXACTLY LOCATE AND PRESERVE ANY AND ALL UNDERGROUND UTILITIES.

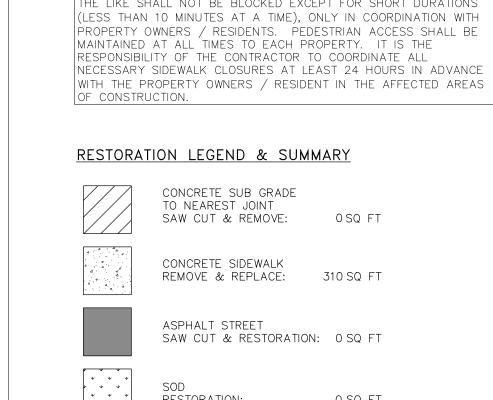

GRAND RIVER AVE. (60 FT. WIDE)

> RESTORATION PLAN VIEW SCALE 1"=20'

R-29-I, CED MODIFIED, AS NEED SIDEWALKS AND ENTRANCES TO BUILDINGS, REAL PROPERTY, AND THE LIKE SHALL NOT BE BLOCKED EXCEPT FOR SHORT DURATIONS (LESS THAN 10 MINUTES AT A TIME), ONLY IN COORDINATION WITH PROPERTY OWNERS / RESIDENTS. PEDESTRIAN ACCESS SHALL BE MAINTAINED AT ALL TIMES TO EACH PROPERTY. IT IS THE RESPONSIBILITY OF THE CONTRACTOR TO COORDINATE ALL NECESSARY SIDEWALK CLOSURES AT LEAST 24 HOURS IN ADVANCE

RESTORATION LEGEND & SUMMARY

THE ADA RAMP SHALL BE RECONSTRUCTED IN ACCORDANCE WITH MDOT STANDARD DETAIL

CONCRETE SUB GRADE TO NEAREST JOINT SAW CUT & REMOVE: 0 SQ FT REMOVE & REPLACE: 310 SQ FT ASPHALT STREET SAW CUT & RESTORATION: 0 SQ FT


0 SQ FT RESTORATION:

CURB & GUTER RESTORATION: O LF FT

RESTORATION NOTES: 1. RESTORE PAVEMENT MARKINGS AS REQUIRED RESTORE IN QUANTITIES SUFFICIENT TO ADHERE
 TO CITY OF DETROIT PAVEMENT SPECIFIACTIONS.

CONTRACTOR'S FAILURE TO EXACTLY LOCATE AND PRESERVE ANY AND ALL UNDERGROUND UTILITIES.



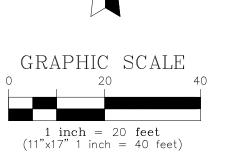




METRO ENGINEERING SOLUTIONS

33900 SCHOOLCRAFT RD LIVONIA, MICHIGAN 48150 PHONE: 734.483.1427 FAX: 734.483.3431 www.metroes.net



October 7, 2021

CONTRACTOR/AS-BUILT

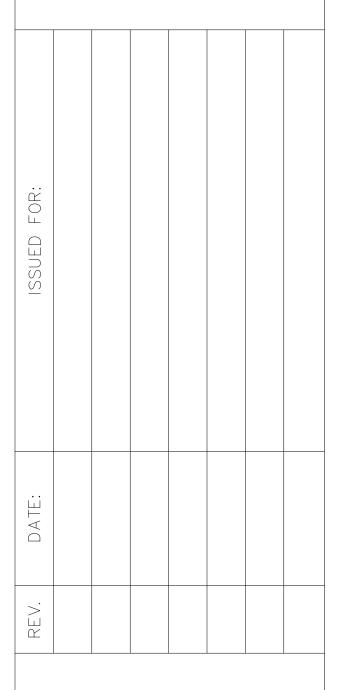

SITE NAME: DET-003 SHELBY & GRISWOLD

1035-21-1595_DS DRAW DATE: 09/29/21


PLOT DATE: 10/7/21


DRAWN BY: JRG TITLE: RESTORATION PLAN

SHEET: 04 OF 11

CONSTRUCTION SITE SAFETY IS THE RESPONSIBILITY OF THE CONTRACTOR. NEITHER THE OWNER NOR THE ENGINEER SHALL BE EXPECTED TO ASSUME ANY RESPONSIBILITY FOR SAFETY OF THE WORK, OF PERSONS ENGAGED IN THE WORK, OF ANY NEARBY STRUCTURES, OR OF ANY OTHER PERSONS.

THE LOCATIONS OF EXISTING UNDERGROUND UTILITIES ARE SHOWN IN AN APPROXIMATE WAY ONLY AND HAVE NOT BEEN INDEPENDENTLY VERIFIED. THE CONTRACTOR SHALL DETERMINE THE EXACT LOCATION OF ALL EXISTING UTILITIES BEFORE COMMENCING WORK, AND AGREES TO BE FULLY RESPONSIBLE FOR ANY AND ALL DAMAGES WHICH MIGHT BE OCCASIONED BY THE

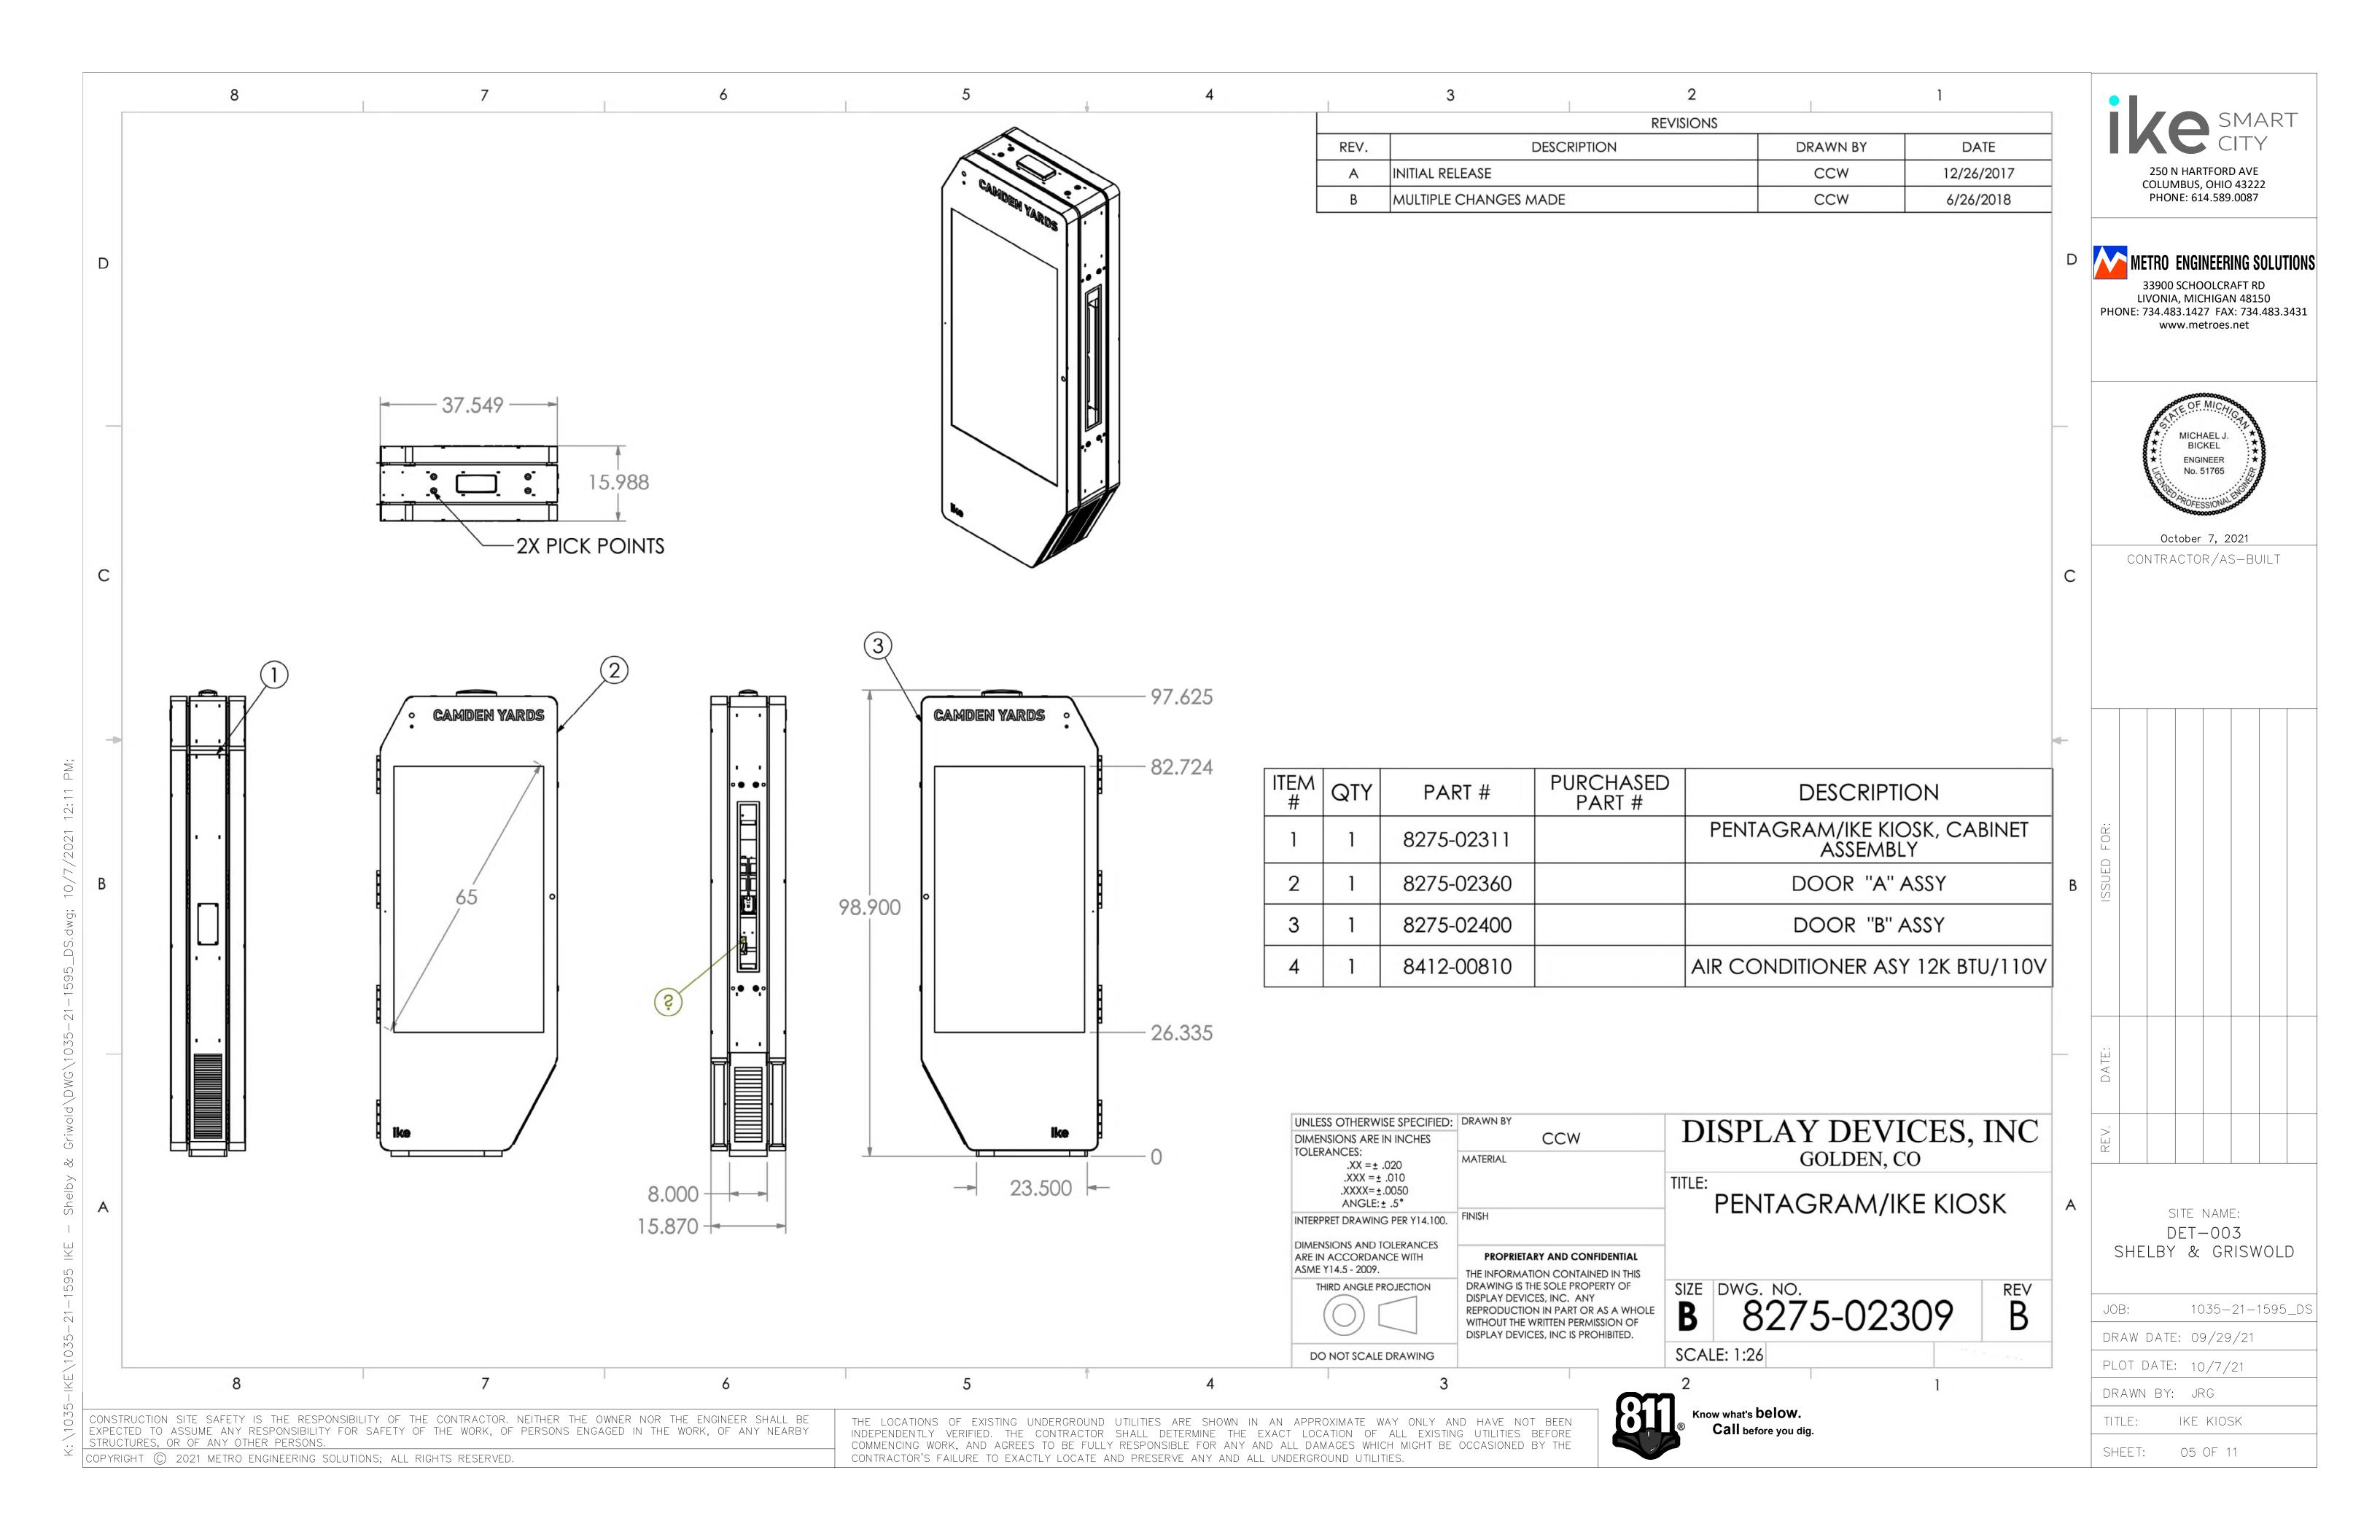

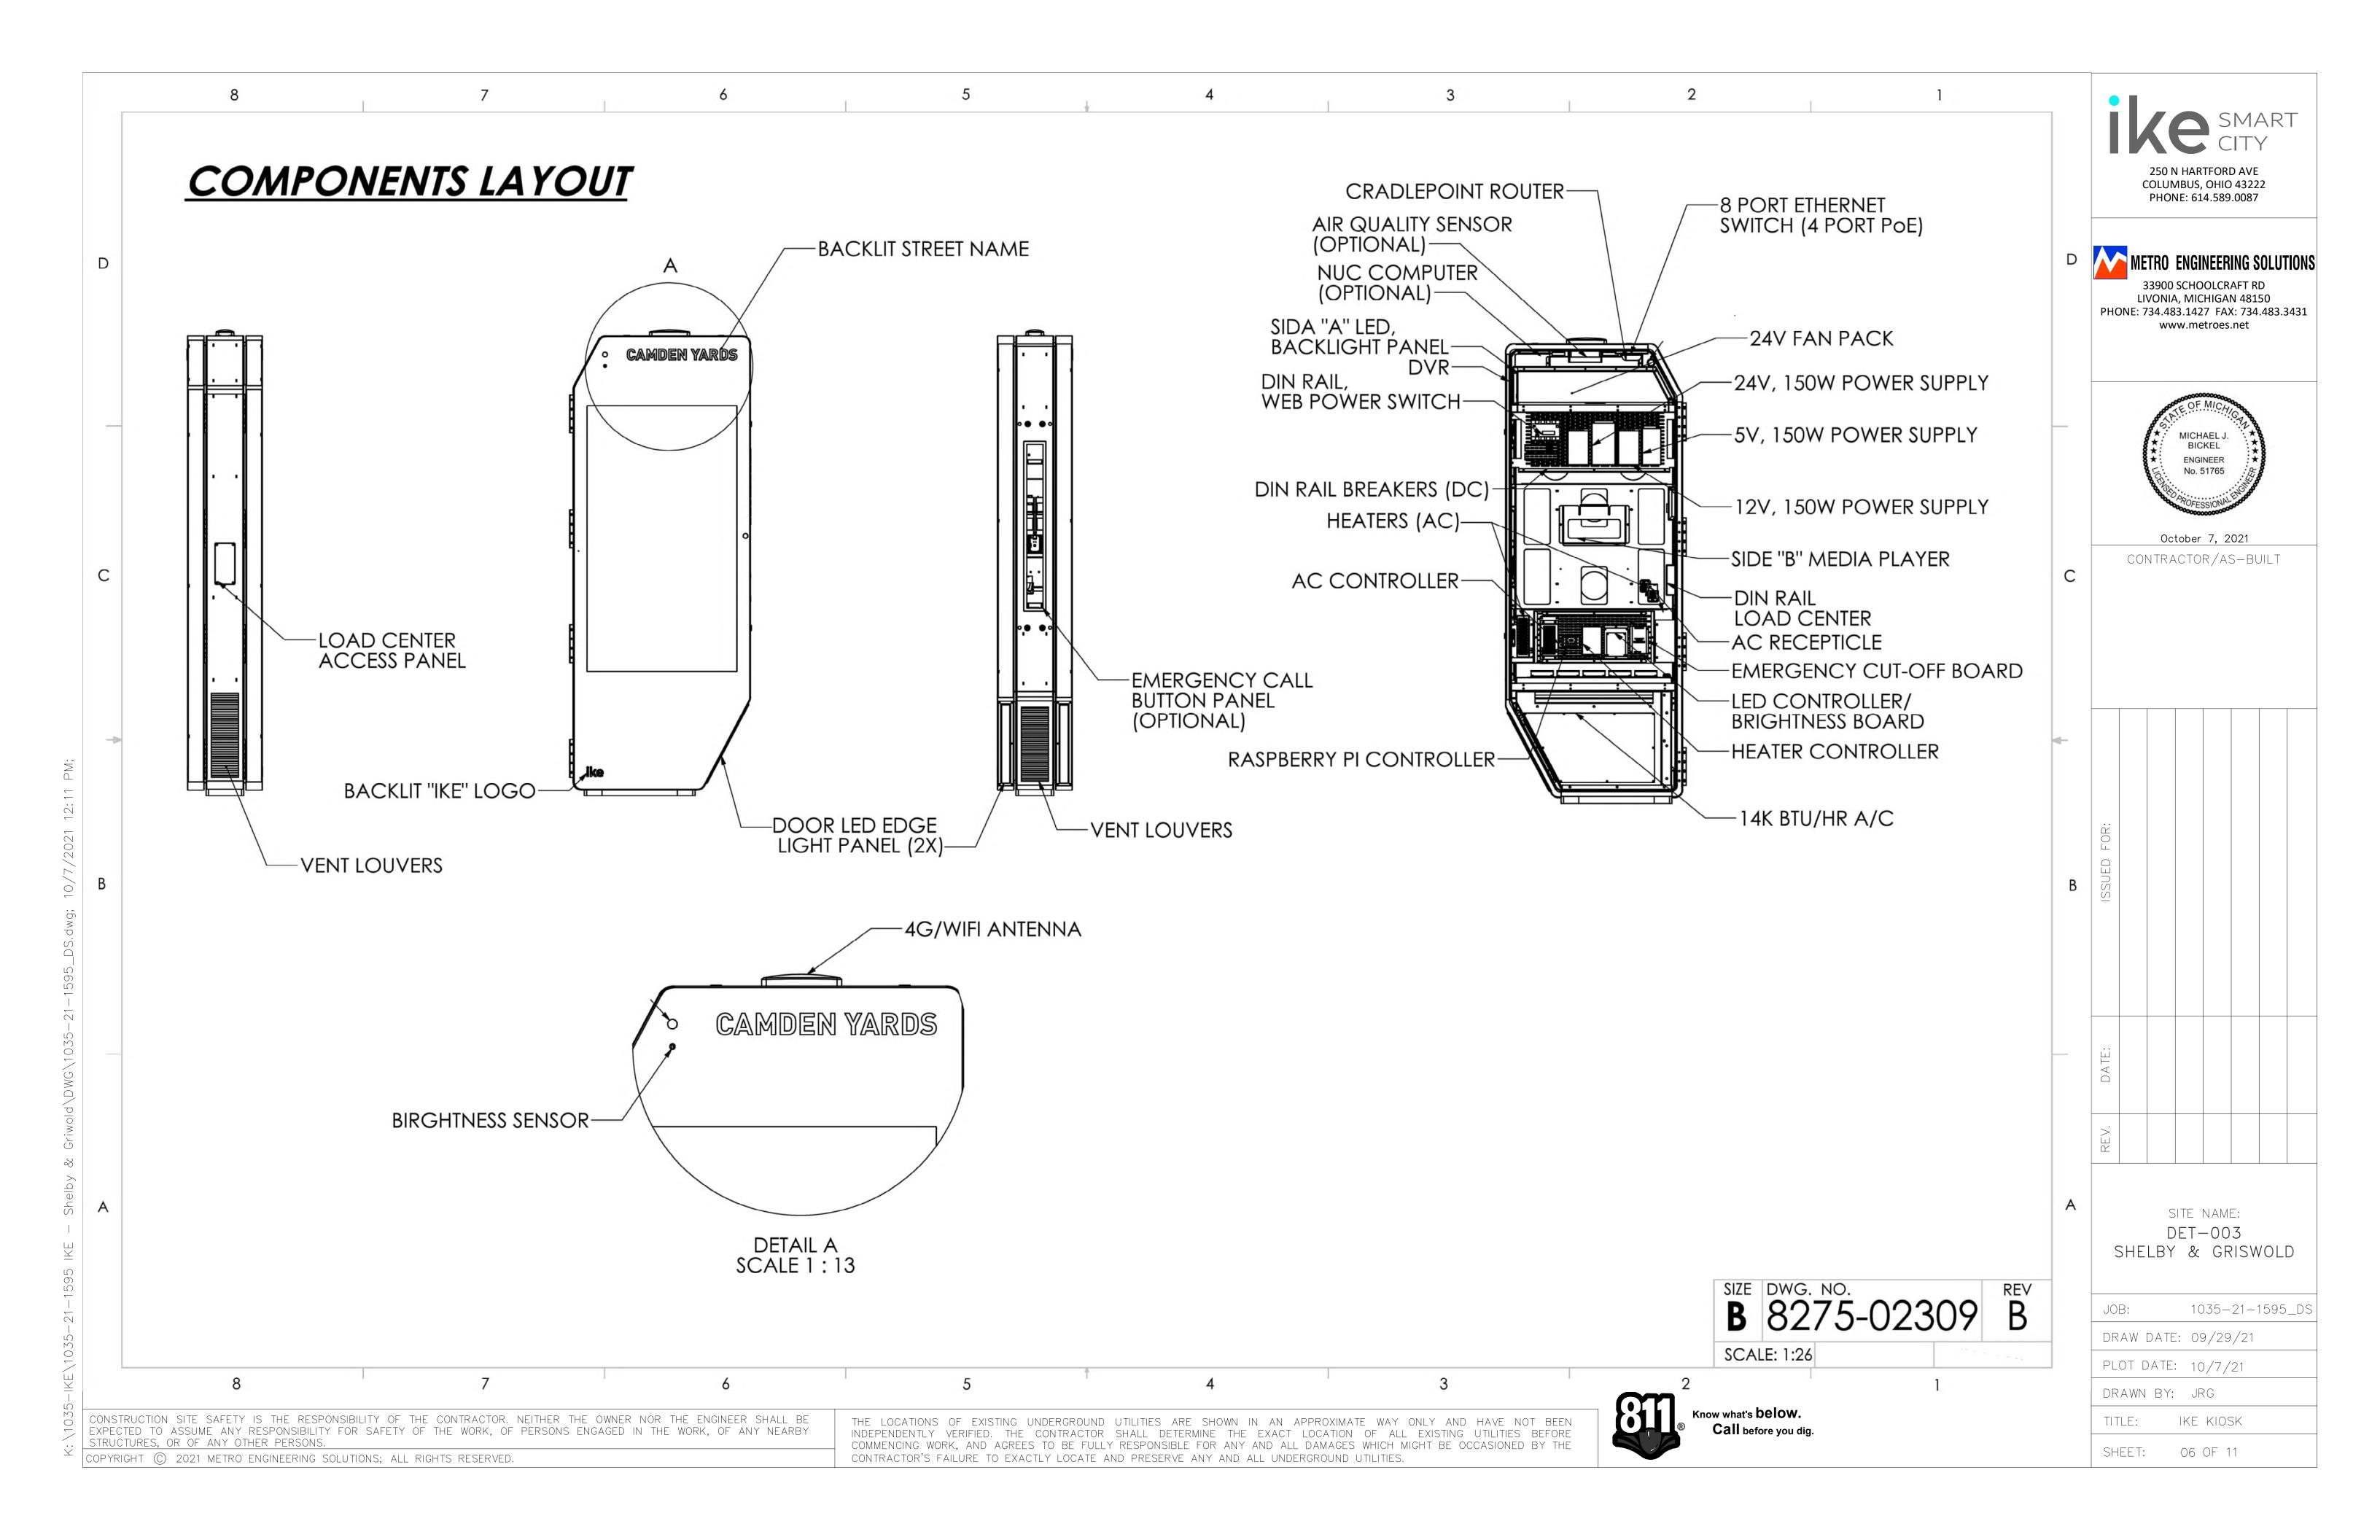

STRUCTURAL GENERAL NOTES

DESIGN LOADS & GOVERNING BUILDING CODE

Code: Michigan Building Code (MBC) - 2015 Edition

Kiosk: Dead Load = 700 lbs

Wind: Nominal Design Wind Speed, V_(ASD) = 81 MPH (3-Second Gust)
Ultimate Design Wind Speed, V_(ULT) = 105 MPH (3-Second Gust)

Exposure = C p = 27.7 psf

Seismic: Seismic Design Category = B

Risk Category = I

GENERAL CONSTRUCTION NOTES

- The Structural Contract Documents are intended to be used in conjunction with the plans of all other disciplines working on the project. The contractor is responsible for the coordination of all required information.
- Modifications to the Structural Contract Documents due to conditions at the site that are unknown or concealed at the time of
 design do not fall within the original scope of work of the project. Required modifications shall be performed as additional
 services as outlined in the project contract. The Engineer shall be notified in writing by an (RFI) to provide recommendations for
 resolution of the modification requested.
- Dimensions and elevations indicated on the Structural Contract Documents shall be coordinated by the contractor with all other disciplines prior to the beginning of construction. Discrepancies shall be brought to the attention of Display Devices, Inc. and Anchor Engineering, Inc. Scaling of the Structural Contract Documents is not permitted.
- The contractor shall verify field conditions including existing utilities, sub-grade and above grade conditions which may interfere with construction and notify the applicable disciplines for modifications as required.
- In the event of discrepancies between project specifications, general notes, plans and details, the most stringent requirements shall apply unless approved in writing.

EXISTING CONSTRUCTION


- Preparation of the Structural Contract Documents is based on available existing construction documents and third-party site
 observations of exposed conditions. Actual field conditions exposed during construction and found to conflict with the Structural
 Contract Documents shall be brought to the attention of the Display Devices, Inc. and Anchor Engineering, Inc.
- Prior to the construction phase of the project, the contractor shall become familiar with the existing structure and all aspects that may influence the construction process.
- Owner and Anchor Engineering, Inc. shall be contacted in the event of uncovered elements found during the project that appear to be unsound or otherwise structurally deficient.

FOUNDATION DESIGN (Footings)


- The foundation design is based on conclusions & recommendations found in the geotechnical report project #03811252 provided by intertek psi dated August 19, 2021. All recommendations found in this report shall be followed, including site preparation. A copy of this soils report is available for review at the Structural Engineers office, the Architects office, or the job site trailer.
- Conventional Spread Footings:
- a. Maximum Allowable Bearing Pressure.................. 1,500 psf
- The site shall be prepared in accordance w/ the project geotechnical report prior to foundation construction.
- All footings shall be placed on adequate bearing stratum or to a min. depth as shown on the drawings, whichever is deeper.

REINFORCED CONCRETE


- Design is based on "Building Code Requirements for Reinforced Concrete" (ACI 318 Latest Edition). Concrete work shall conform to "Specifications for Structural Concrete for Buildings" (ACI 301 - Latest Edition). Hot and cold weather shall be in conformance with ACI 305 and ACI 306 respectively.
- Structural concrete shall have minimum 28-day compressive strength of 4000 psi.
- Cement shall be Portland Cement as noted above, conforming to ASTM C150.
- Aggregate size shall not exceed ¾"
- Chloride admixtures shall not be used.
- Concrete exposed to weather shall have a minimum air entrainment of 6 ± 1½ percent.
- Fly ash shall conform to ASTM specification C618, class C or class F. Fly ash shall not exceed 20% of the total weight of cementitious material.
- Reinforcing Bars shall conform to ASTM A615 or ASTM A706. All bars shall be Grade 60. Detailing, fabrication, and placement
 of reinforcing steel shall be in accordance with the "Manual of Standard Practice for Detailing Reinforced Concrete Structures
 (ACI 315 latest ed.)".

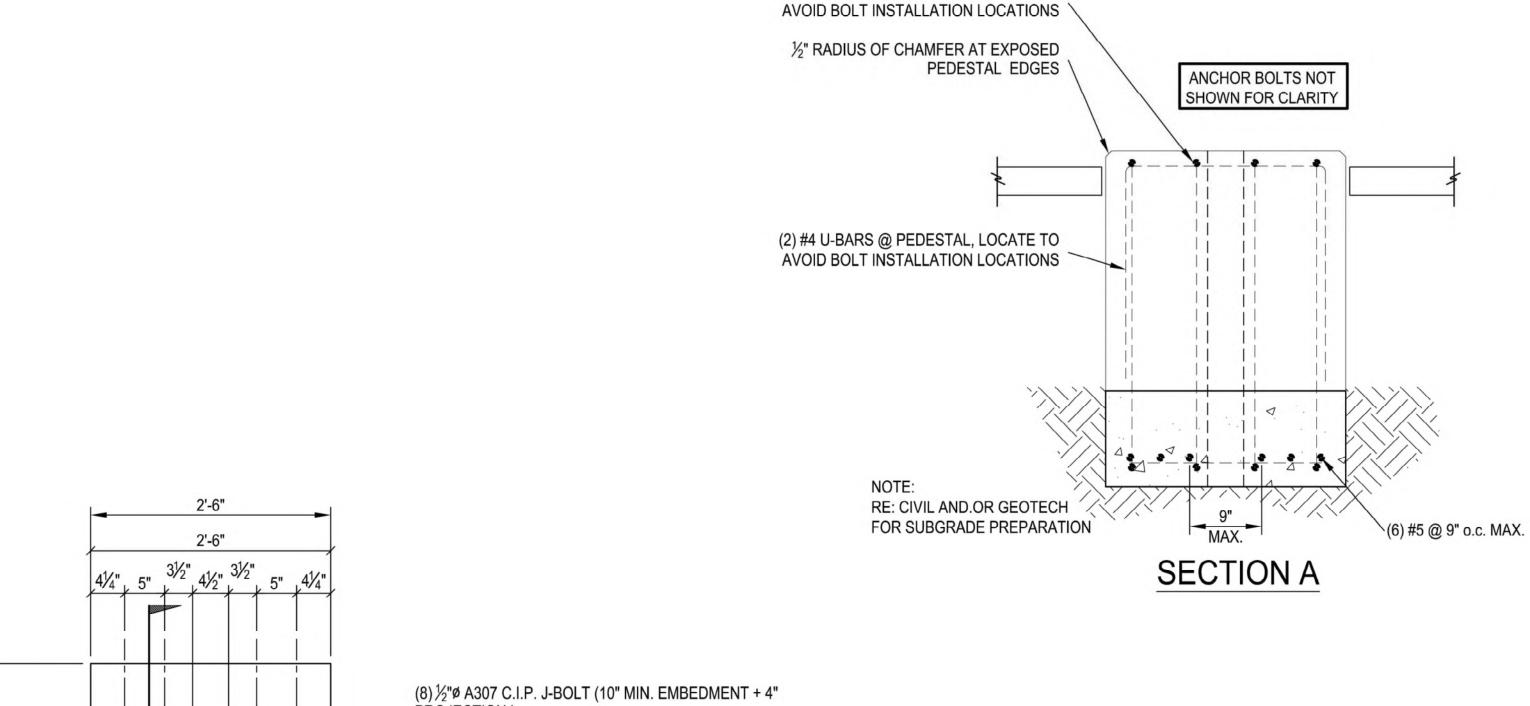

(8) #4 Z-BARS @ PEDESTAL, LOCATE TO

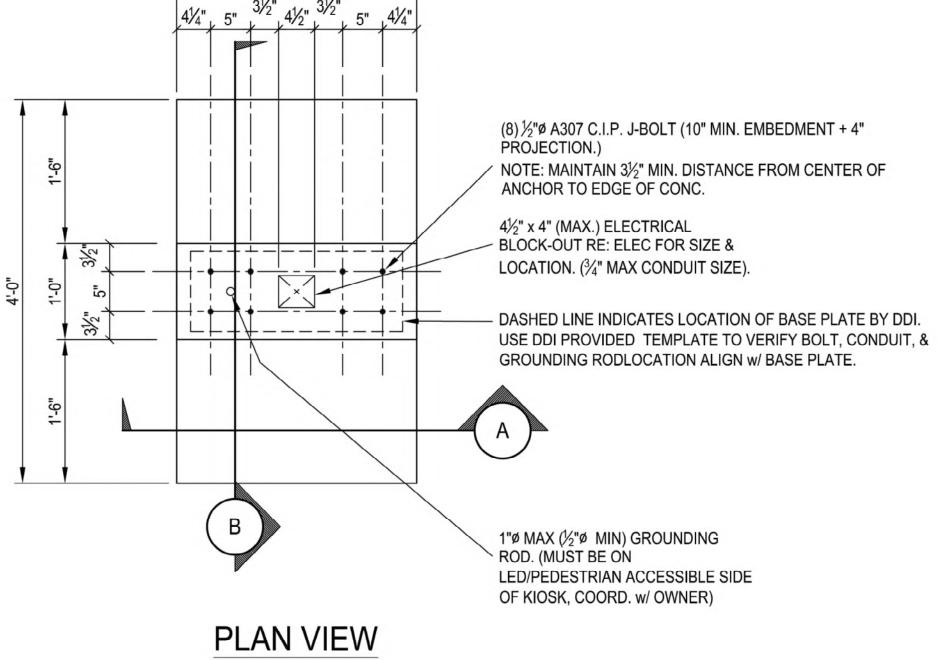

ADDRESS SCHEDULE		
KIOSK ID	ADDRESS	
DET-001	LIBRARY ST & FARMER ST.	
DET-003	SHELBY ST. & GRISWOLD ST.	
DET-004	CADILLAC SQUARE & WOODWARD AVE	
DET-005	WOODWARD & E. CONGRESS ST	
DET-013	OUTER DRIVE W & LIVERNOIS AVE	

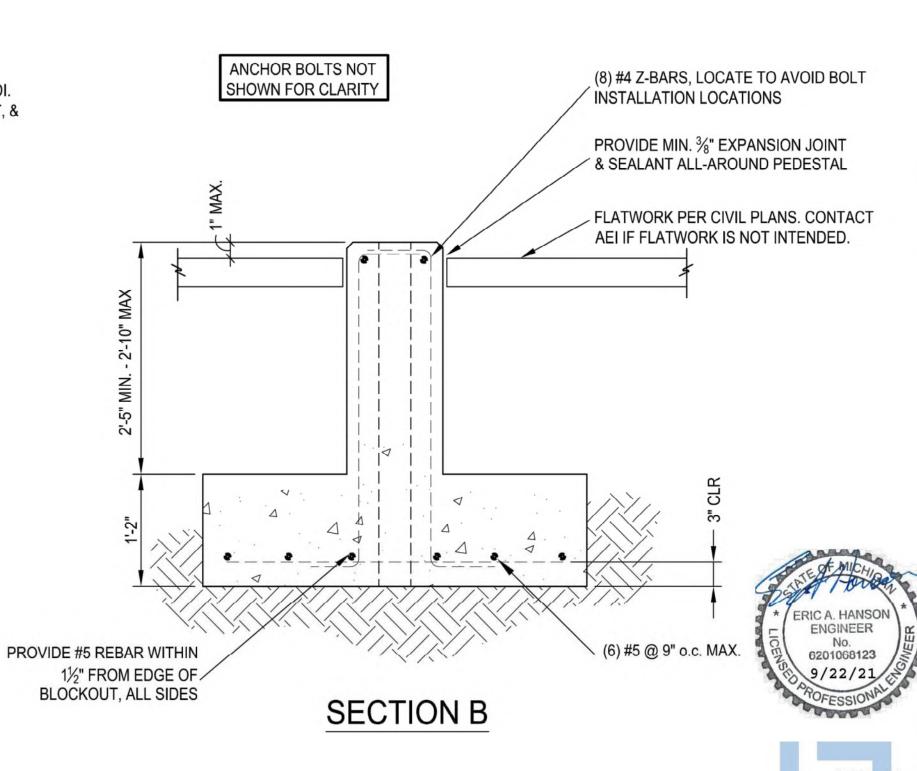





SMART CITY

IKE SM.

S1.0


2535 17th Street
Denver, CO 80211
303-783-4797
anchoreng.com

ANCHOR ENGINEERING

Horn

Kimley » I

IOSK ATION

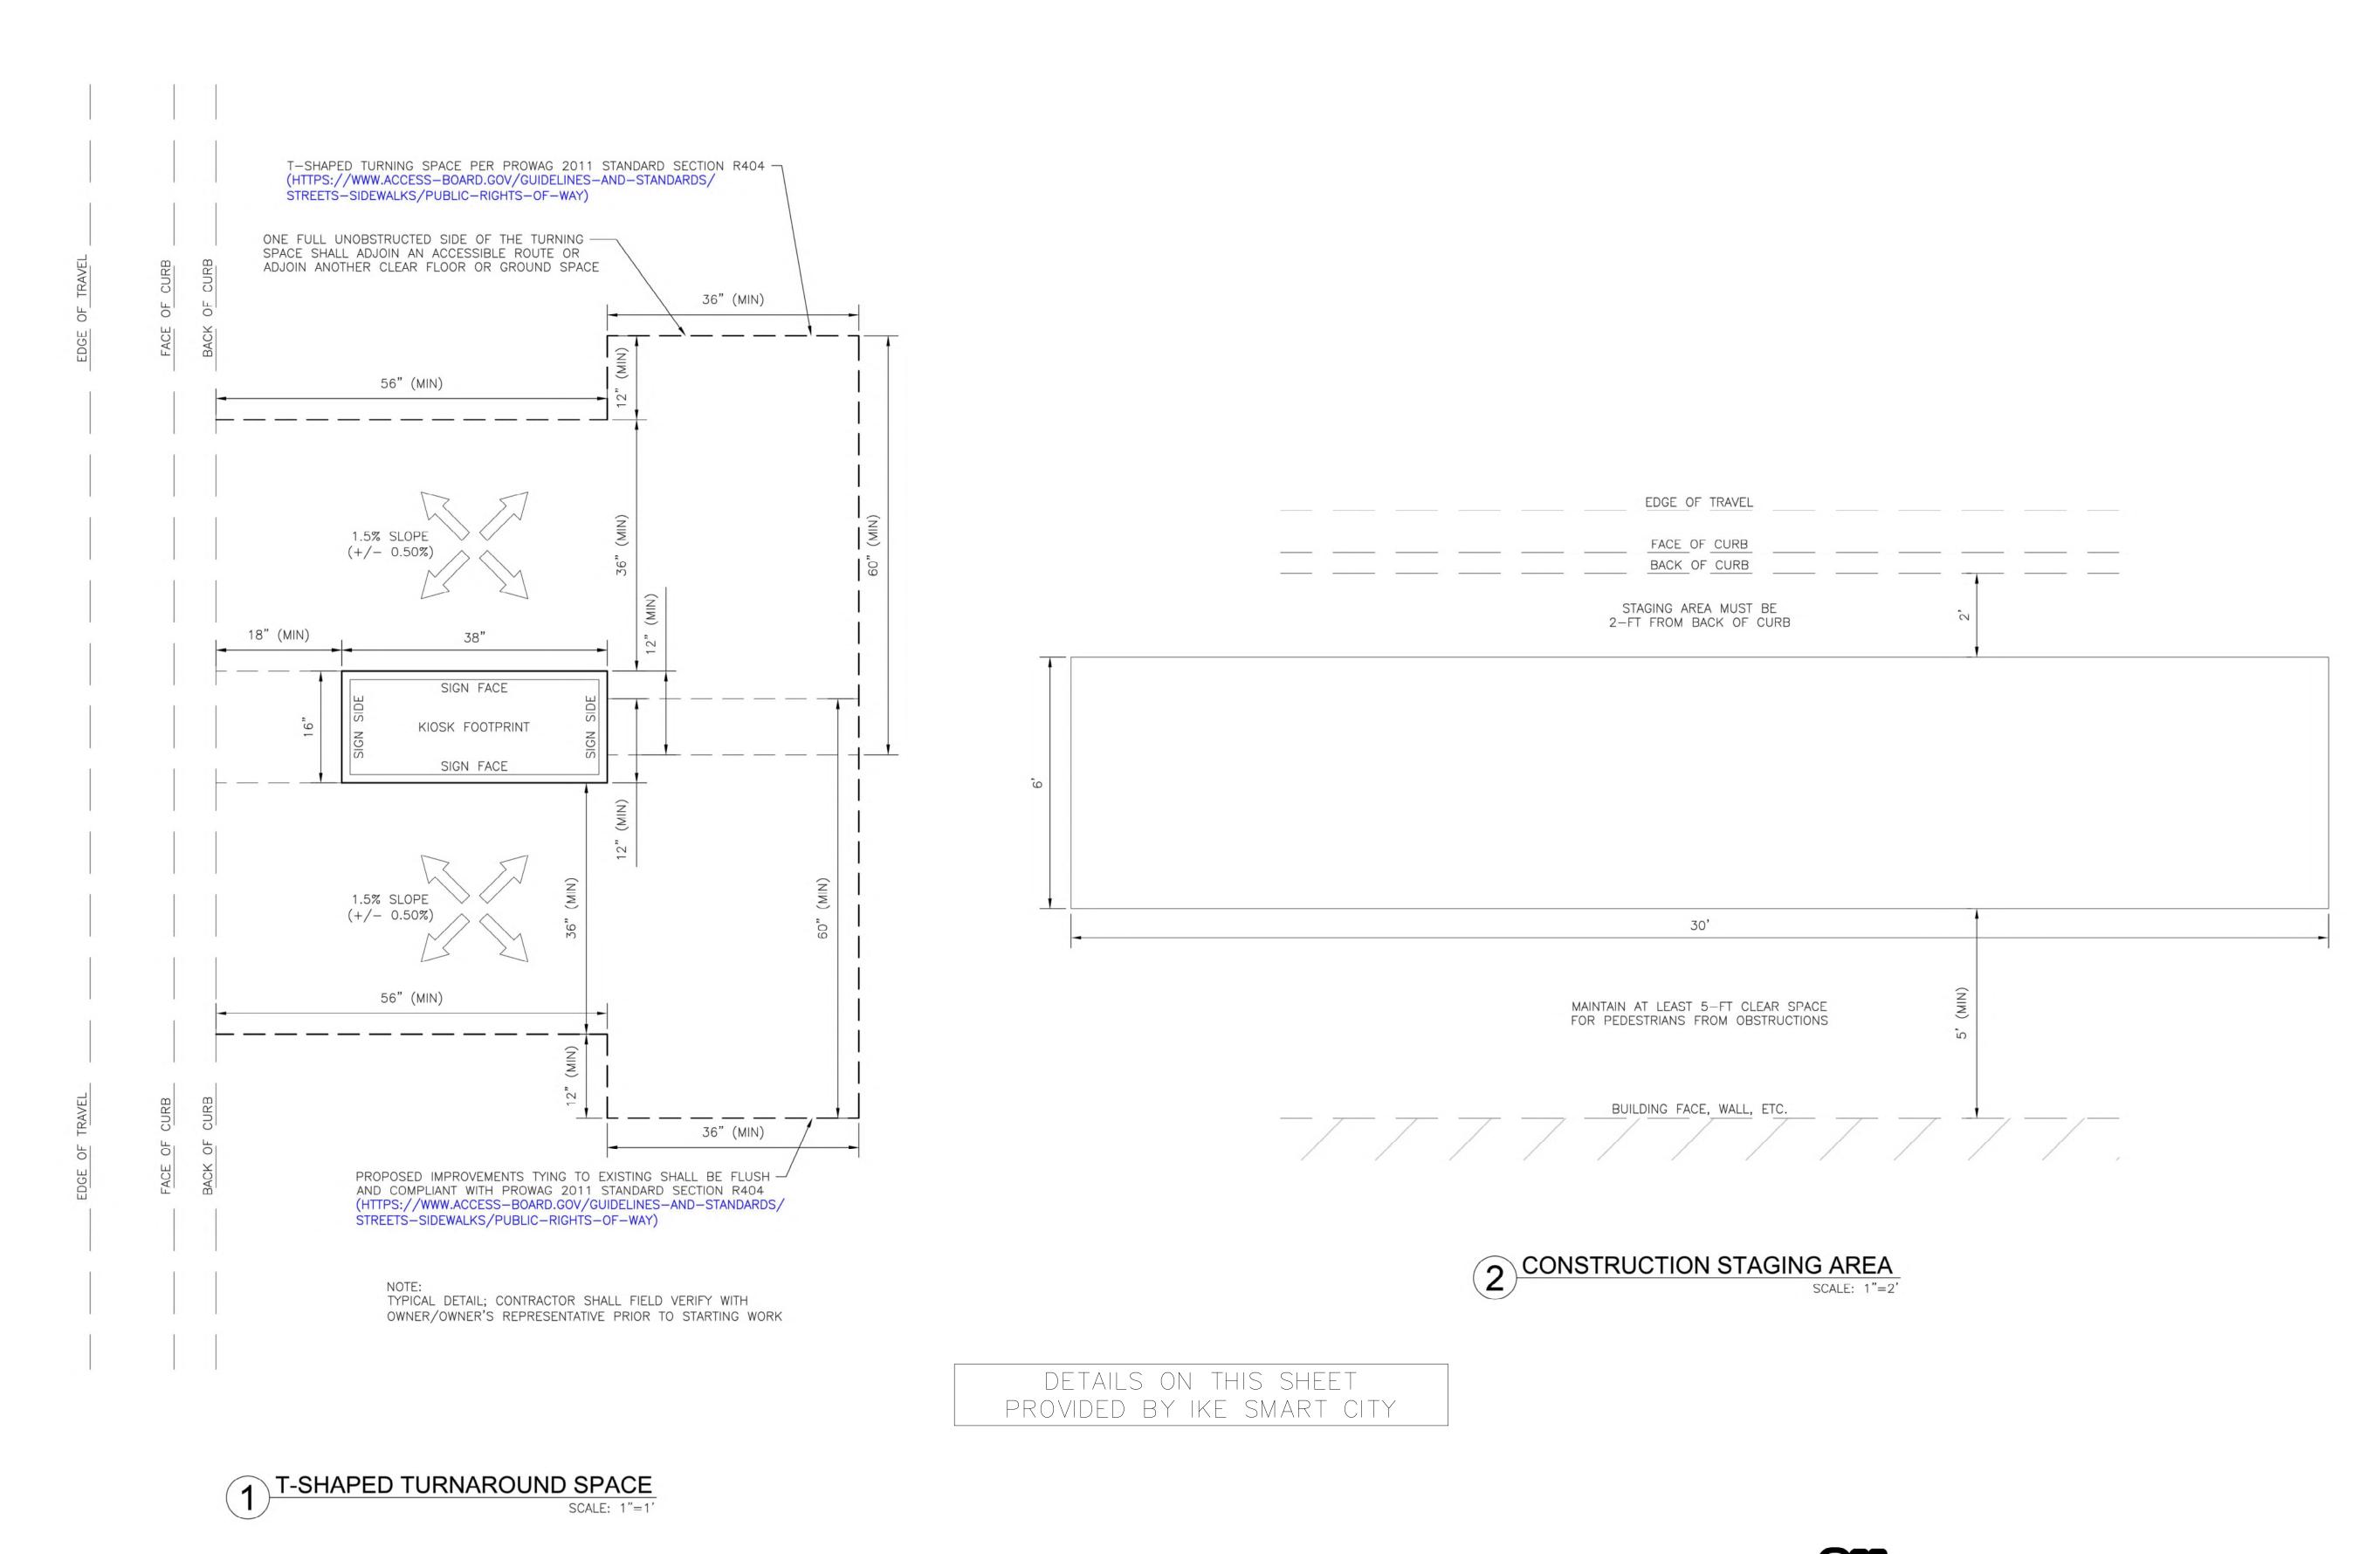

250 N HARTFORD AVE COLUMBUS, OHIO 43222 PHONE: 614.589.0087


METRO ENGINEERING SOLUTIONS

33900 SCHOOLCRAFT RD LIVONIA, MICHIGAN 48150 PHONE: 734.483.1427 FAX: 734.483.3431 www.metroes.net



October 7, 2021

CONTRACTOR/AS-BUILT

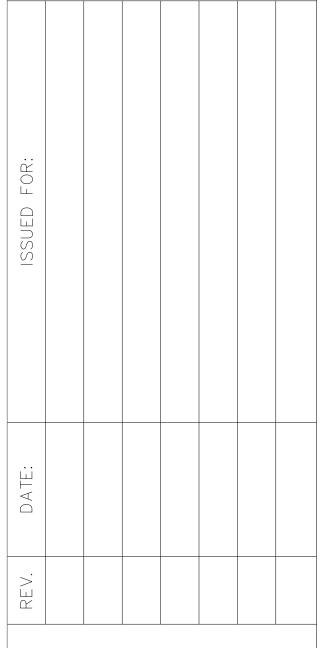

SITE NAME:
DET-003
SHELBY & GRISWOLD

JOB: 1035-21-1595_DS

DRAW DATE: 09/29/21

PLOT DATE: 10/7/21

DRAWN BY: JRG

TITLE: ADA SPEC

SHEET: 08 OF 11

THE LOCATIONS OF EXISTING UNDERGROUND UTILITIES ARE SHOWN IN AN APPROXIMATE WAY ONLY AND HAVE NOT BEEN INDEPENDENTLY VERIFIED. THE CONTRACTOR SHALL DETERMINE THE EXACT LOCATION OF ALL EXISTING UTILITIES BEFORE COMMENCING WORK, AND AGREES TO BE FULLY RESPONSIBLE FOR ANY AND ALL DAMAGES WHICH MIGHT BE OCCASIONED BY THE CONTRACTOR'S FAILURE TO EXACTLY LOCATE AND PRESERVE ANY AND ALL UNDERGROUND UTILITIES.

Know what's below.

Call before you dig.

CONSTRUCTION SITE SAFETY IS THE RESPONSIBILITY OF THE CONTRACTOR. NEITHER THE OWNER NOR THE ENGINEER SHALL BE

- 1. THE SUBMISSION OF A BID BY THE CONTRACTOR IS NOTIFICATION THAT THE CONTRACTOR HAS TOTALLY FAMILIARIZED THEMSELVES WITH THE CONTRACT DOCUMENTS AND EXISTING SITE CONDITIONS AND HAS AGREED TO PROVIDE THE NECESSARY LABOR AND MATERIAL FOR THE COMPLETE INSTALLATION OF EACH SYSTEM IN A NEAT AND PROFESSIONAL MANNER IN ACCORDANCE WITH THE BEST PRACTICES OF THE INDUSTRY AND IN COMPLIANCE WITH ALL AUTHORITIES HAVING JURISDICTION.
- 2. THESE DRAWINGS ARE PRESENTED TO THE CONTRACTOR WITH THE UNDERSTANDING THAT THE CONTRACTOR IS AN EXPERT AND COMPETENT IN THE PREPARATION OF CONTRACT BID OF INFORMATION SUCH AS IS CONTAINED IN THESE DOCUMENTS. IT IS THE INTENT OF THE DRAWINGS AND SPECIFICATIONS TO CALL FOR FINISHED WORK, TESTED AND READY FOR OPERATION AND IN COMPLETE CONFORMANCE WITH APPLICABLE CODES, RULES, AND REGULATIONS. MINOR ITEMS NOT USUALLY SHOWN OR SPECIFIED, BUT MANIFESTLY NECESSARY FOR PROPER INSTALLATION AND OPERATION OF THE VARIOUS SYSTEMS SHALL BE INCLUDED IN THE WORK AND IN THE PROPOSAL THE SAME AS IF SPECIFIED OR SHOWN ON THE DRAWINGS. IF ANY DEPARTURES FROM THE DRAWINGS ARE DEEMED NECESSARY, DETAILS OF SUCH DEPARTURES AND THE REASONS THEREFORE SHALL BE SUBMITTED TO THE OWNER FOR APPROVAL. NO DEPARTURES SHALL BE MADE WITHOUT PRIOR APPROVAL.
- 3. THE CONTRACTOR SHALL VISIT THE SITE AND VERIFY ALL DIMENSIONS IN THE FIELD, AND SHALL ADVISE THE OWNER OF ANY DISCREPANCIES BEFORE PERFORMING THE WORK.
- 4. THE DRAWINGS INDICATE ARRANGEMENTS AND APPROXIMATE SIZES AND RELATIVE LOCATIONS OF PRINCIPAL APPARATUS, EQUIPMENT, DEVICES, AND SERVICES TO BE PROVIDED. DRAWINGS ARE DIAGRAMMATIC AND ARE A GRAPHIC REPRESENTATION OF CONTRACT REQUIREMENTS BASED ON THE INFORMATION PROVIDED BY THE MANUFACTURER IDENTIFIED IN THE EQUIPMENT SCHEDULE AT THE SCALE INDICATED.
- 5. LAYOUT OF EQUIPMENT INDICATED ON THE DRAWINGS SHALL BE CHECKED AND COMPARED AGAINST ALL DRAWINGS AND SPECIFICATIONS OF ALL TRADES AND EXACT LOCATIONS DETERMINED USING APPROVED SHOP DRAWINGS OF SUCH EQUIPMENT. WHERE PHYSICAL INTERFERENCES OCCUR, CONSULT WITH THE OWNER AND PREPARE DATED, DIMENSIONED DRAWINGS COORDINATED WITH ALL OTHER TRADES WORKING IN THIS AREA AND CORRECTING SUCH INTERFERENCE.
- 6. THE CONTRACTOR SHOULD SCHEDULE THEIR WORK IN ACCORDANCE WITH THE CONSTRUCTION SCHEDULE SO THAT ALL OF THEIR WORK CAN BE INSTALLED WITHOUT DELAYING THE PROJECT.

 ALL WORK RELATED TO SHUTDOWN OF EXISTING SERVICES SHALL BE PERFORMED AT THE HOURS DESIGNATED BY THE OWNER WITH ALL ASSOCIATED COSTS BORNE BY THE CONTRACTOR AT

 NO COST TO THE OWNER. PROVIDE ANY TEMPORARY FACILITIES REQUIRED TO PERMIT OWNER'S USE OF EXISTING FACILITIES AND SYSTEMS TO REMAIN UNDISTURBED. COORDINATE ALL WORK,

 INCLUDING ALL SHUTDOWNS THAT AFFECT SYSTEMS AND/OR PORTIONS OF THE BUILDING THAT MUST REMAIN IN OPERATION, WITH OWNER.
- 7. THE CONTRACTOR SHALL SECURE AND PAY ALL FEES, LICENSES, INSPECTIONS, AND PERMITS PERTAINING TO THE CONTRACT. SUBMIT TO OWNER DUPLICATE CERTIFICATES OF INSPECTION.
- 8. ALL EQUIPMENT SHALL BE INSTALLED IN STRICT COMPLIANCE WITH THE MANUFACTURER'S WRITTEN INSTRUCTIONS.
- 9. THE CONTRACTOR SHALL BE RESPONSIBLE FOR WORKMEN'S IDENTIFICATION AND BADGING, SAFETY AND FIRE PROTECTION, BARRICADES, WARNING SIGNS, TRASH REMOVAL, CUTTING AND PATCHING.
- 10. THE CONTRACTOR SHALL BE RESPONSIBLE FOR ALL RIGGING, HANDLING, AND PROTECTION OF MATERIALS. ALL EQUIPMENT AND MATERIALS SHALL BE NEW AND WITHOUT BLEMISH OR DEFECT. ALL EQUIPMENT INSTALLED SHALL BEAR THE LABEL OF AN APPROVED AGENCY.
- 11. THE CONTRACTOR SHALL PROVIDE LABOR TO RECEIVE, UNLOAD, STORE, PROTECT, AND TRANSFER TO POINT OF INSTALLATION FOR ALL FURNISHED ITEMS.
- 12. WHERE CONDUIT, CABLES, DUCTWORK, OR PIPING PASSES THROUGH FIRE RATED FLOORS OR WALLS, THE PENETRATION SHALL BE COMPLETELY SEALED WITH A FIRE STOP MATERIAL THAT IS UL LISTED AND ACCEPTED BY THE BUILDING DEPARTMENT AND FIRE DEPARTMENT AS BEING SUITABLE FOR THIS SERVICE. THIS MATERIAL SHALL BE INSTALLED IN ACCORDANCE WITH THE REQUIREMENTS OF THE MANUFACTURER TO MAINTAIR THE UL LISTED FIRE RATING OF THE PENETRATED WALL OR FLOOR.
- 13. THE CONTRACTOR SHALL BE RESPONSIBLE FOR ALL SLAB OPENINGS, WALL OPENINGS, BEAM PENETRATIONS, AND CORING AS IT RELATES TO THEIR WORK. THE CONTRACTOR SHALL SUBMIT SIZE AND LOCATION FOR REVIEW AND APPROVAL.
- 14. ALL EXTERIOR WALL OPENINGS SHALL BE SLEEVED, PROPERLY CAULKED, AND SEALED WITH A HIGH QUALITY SEALANT TO PREVENT INFILTRATION OF MOISTURE AND OUTSIDE AIR.
- 15. THE CONTRACTOR SHALL SUBMIT A SCHEDULE OF SUBMITTALS PRIOR TO SUBMITTING ANY SHOP DRAWINGS, ETC. TO BE SUBMITTED FOR THIS PROJECT. INCLUDING THE ANTICIPATED DATE OF EACH SUBMISSION. THE CONTRACTOR SHALL SUBMIT AN ELECTRONIC COPY OF THE COMPLETE SHOP DRAWINGS AND CATALOG CUTS, WIRING DIAGRAMS AND ASSOCIATED DATA TO THE OWNER FOR APPROVAL PRIOR TO PURCHASING EQUIPMENT OR STARTING ANY WORK. ANY WORK INSTALLED OR EQUIPMENT PURCHASED PRIOR TO RECEIPT OF OWNER APPROVED SHOP DRAWINGS THAT REQUIRES CHANGES SHALL BE REPLACED AT THE CONTRACTOR'S EXPENSE.
- 16. ALL WORK FURNISHED UNDER THE CONTRACT SHALL BE GURANTEED AGAINST ANY AND ALL DEFECTS IN WORKMANSHIP AND/OR MATERIALS FOR A PERIOD OF NOT LESS THAN (1) YEAR FROM THE DATE OF FINAL ACCEPTANCE OF THE INSTALLATION, UNLESS NOTED OTHERWISE IN THE PROJECT SPECIFICATIONS, AND ANY DEFECTS OF WORKMANSHIP DEVELOPING DURING THIS PERIOD SHALL BE REMEDIED AND ANY DEFECTIVE MATERIAL REPLACED WITHOUT ADDITIONAL COST TO THE OWNER.
- 17. INSTALLED SYSTEMS SHALL OPERATE UNDER ALL CONDITIONS OF LOAD WITHOUT SOUND OR VIBRATION THAT IS OBJECTIONABLE TO THE OWNER, OBJECTIONABLE SOUND OR VIBRATION CONDITIONS DUE TO WORKMANSHIP SHALL BE CORRECTED IN AN APPROVED MANNER BY THE CONTRACTOR AT THE CONTRACTOR'S EXPENSE.
- 18. THE CONTRACTOR SHALL NOTIFY OWNER OF COMPLETION OF ALL WORK, INDICATING THE CONTRACTOR IS READY FOR THE OWNER TO PERFORM THE FINAL PUNCH LIST INSPECTION.
- 19. UPON COMPLETION OF ALL UNFINISHED OR FAULTY WORK NOTED IN THE OWNER'S FINAL PUNCH LIST, THE CONTRACTOR SHALL SUBMIT TO THE OWNER IN WRITING A LETTER OF COMPLETION CERTIFYING THAT ALL PUNCH LIST ITEMS HAVE BEEN COMPLETED AND ALL AS—BUILTS, MANUALS, ETC. HAVE BEEN SUBMITTED.
- 20. SHOULD A CONTRACTOR REQUIRE REMOVAL, RELOCATION, OR REROUTING OF ANOTHER TRADE'S WORK THAT IS NOT INDICATED ON DRAWINGS, THE CONTRACTOR REQUIRING SUCH WORK SHALL BE RESPONSIBLE FOR THAT WORK, AND PAY ALL REQUIRED COSTS.
- 21. ALL WORK INVOLVING ALTERATIONS TO EXISTING SYSTEMS, EQUIPMENT, AND MATERIALS SHALL BE REVIEWED WITH THE OWNER BEFORE BEGINNING WORK.
- 22.DEFINITION: UNLESS OTHERWISE NOTED, ALL WORK SPECIFIED HERIN OR NOTED ON DRAWINGS, SHALL BE BY THE CONTRACTOR. THE TERM "PROVIDE" WHENEVER ENCOUNTERED ON DRAWINGS OR IN THESE SPECIFICATIONS. SHALL MEAN "FURNISH AND INSTALL."
- 23.CODES AND STANDARDS: ALL MATERIALS AND WORKMANSHIP SHALL COMPLY WITH THE CURRENT EDITION OF THE NATIONAL ELECTRICAL CODE, ALL APPLICABLE CODES, SPECIFICATIONS,
- LOCAL ORDINANCES, INDUSTRY STANDARDS, UTILITY COMPANY REGULATIONS, AND FIRE INSURANCE CARRIER'S REQUIREMENTS.

 24.MATERIALS: ALL MATERIALS FURNISHED BY THIS CONTRACTOR, SHALL BE NEW AND BEAR THE LABEL OR LISTING OF A NATIONALY RECOGNIZED INDEPENDENT TESTING LABORATORY.
- 25.OUTLET AND SWITCH BOXES: PROVIDE AND INSTALL OUTLET BOXES OF PROPER TYPE AND SIZE AS REQUIRED AT ALL OUTLETS WHERE SHOWN. SECURED FIRMLY IN PLACE AND SET TRUE AND SQUARE AND FLUSH WITH THE FINISHED SURFACE.
- 26. WIRING: WIRES SHALL BE COPPER WITH XHHW OR OTHER XLP INSULATION RATED FOR THE LOCATIONS IN WHICH THEY ARE INSTALLED. ALL RACEWAYS ARE SHOWN DIAGRAMMATICALLY, EXACT LOCATION TO BE DETERMINED ON THE JOB. THE CONTRACTOR SHALL ARRANGE ALL NEW CIRCUITS IN PANELS SO AS TO BALANCE THE LOAD ON ALL PHASES.
- 27.A TYPED DIRECTORY CARD SHALL BE PROVIDED IN EACH PANEL WITH ADDED CIRCUITS TO INDICATE THE LOADS ACTUALLY SERVED.
- 28. GROUNDING: SHALL BE IN STRICT ACCORDANCE WITH THE NATIONAL ELECTRICAL CODE ARTICLE 250. PROVIDE GROUND WIRES AS REQUIRED AND RESIZE CONDUIT IF NECESSARY.
- 29. DEMONSTRATION OF COMPLETE ELECTRICAL SYSTEMS: UPON COMPLETION OF THE WORK THE CONTRACTOR SHALL OBTAIN A CERTIFICATE OF APPROVAL FROM THE RESPECTIVE INSPECTION AGENCIES. THE CONTRACTOR SHALL NOTIFY AND MAKE ALL THE NECESSARY ARRANGEMENTS WITH THE INSPECTING AGENCY AND LOCAL AUTHORITIES SO THAT INSPECTION MAY BE CARRIED OUT AT THE PROPER TIME.






33900 SCHOOLCRAFT RD LIVONIA, MICHIGAN 48150 PHONE: 734.483.1427 FAX: 734.483.3431 www.metroes.net



October 7, 2021

CONTRACTOR/AS-BUILT

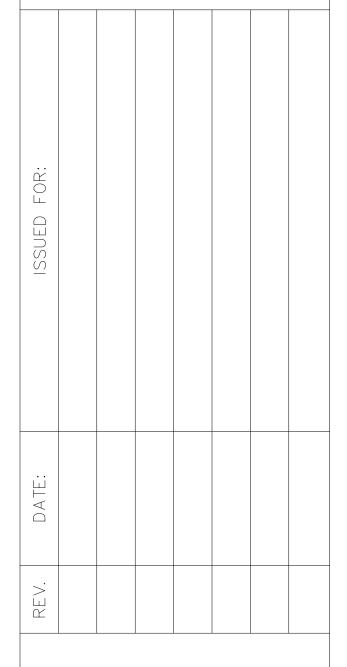

SITE NAME:
DET-003
SHELBY & GRISWOLD

JOB:	1035-21-1595_

DRAW DATE: 09/29/21

PLOT DATE: 10/7/21

DRAWN BY: JRG

TITLE: CONST NOTES

SHEET: 09 OF 11

CONSTRUCTION SITE SAFETY IS THE RESPONSIBILITY OF THE CONTRACTOR. NEITHER THE OWNER NOR THE ENGINEER SHALL BE EXPECTED TO ASSUME ANY RESPONSIBILITY FOR SAFETY OF THE WORK, OF PERSONS ENGAGED IN THE WORK, OF ANY NEARBY STRUCTURES, OR OF ANY OTHER PERSONS.

COPYRIGHT (C) 2021 METRO ENGINEERING SOLUTIONS; ALL RIGHTS RESERVED.

THE LOCATIONS OF EXISTING UNDERGROUND UTILITIES ARE SHOWN IN AN APPROXIMATE WAY ONLY AND HAVE NOT BEEN INDEPENDENTLY VERIFIED. THE CONTRACTOR SHALL DETERMINE THE EXACT LOCATION OF ALL EXISTING UTILITIES BEFORE COMMENCING WORK, AND AGREES TO BE FULLY RESPONSIBLE FOR ANY AND ALL DAMAGES WHICH MIGHT BE OCCASIONED BY THE CONTRACTOR'S FAILURE TO EXACTLY LOCATE AND PRESERVE ANY AND ALL UNDERGROUND UTILITIES.



- Two Step-N-Deploy Legs Make Deployment Quick, Easy and Safe
- Made of UV stabilized, high density polyethylene, the linkable ADA Walls quickly and easily link together in 6 foot sections to allow the contractor flexibility in creating a safe pedestrian pathway.
- Weighing only 23 lbs., the durable, yet lightweight design makes the ADA Wall easy to lift on and off the truck and easy to connect.
- The ten molded-in vertical windows reduce wind load, add strength and stability, and reduce overall weight of the ADA Wall. They also allow a guide dog to see what is on the other side of the wall.
- Two recessed areas measuring 8" wide x 53" long on each side of the ADA Wall accommodate reflective sheeting.
- Standard colors are orange and white. Custom colors also available upon request.
- The TrafFix ADA Wall can accommodate uneven surfaces to create a clear safe pedestrian pathway.

Blow Molded Connectors Provide Strength and Flexibility.



- PEDESTRIAN TRAVEL WILL BE IMPEDED DURING THIS TEMPORARY TRAFFIC CONTROL MEASURE.

- BUS TRAVEL WILL NOT BE IMPEDED DURING THIS TEMPORARY TRAFFIC CONTROL MEASURE.

CONSTRUCTION NOTE:

CONTRACTORS MUST PROVIDE SUPPORTING DOCUMENTS TO THE CITY ENGINEERING DIVISION TO SUBSTANTIATE THAT THE REQUESTOR HAS IN THEIR POSSESSION TO INSTALL AND MAINTAIN THE REQUIRED SIGNAGE, BARRICADES, ARROW BOARDS, ETC., FOR THE CLOSURE, PRIOR TO STARTING CONSTRUCTION.

THE CED RESERVES THE RIGHT TO MODIFY THE REQUIREMENTS, SHOULD IT BECOME NECESSARY TO ENSURE SAFETY OF VEHICULAR AND NON-VEHICULAR TRAFFIC AND EFFECTIVE TRAFFIC FLOW. THE REQUESTOR SHALL BE RESPONSIBLE FOR THE UPKEEP OF THE SIGNAGE, BARRICADES, ARROW BOARDS ETC., AT ALL TIMES DURING THE CLOSURE. REQUESTOR'S FAILURE FOR THE INSTALLATION AND IT'S MAINTENANCE WOULD RESULT IN REVOKING THE PERMITS OR OTHER CORRECTIVE MEASURES. ANY COST ASSOCIATED WITH THE CORRECTIVE MEASURES WILL BE CHARGED TO THE REQUESTOR.

LEGEND

EXISTING TRAFFIC FLOW

PROPOSED TRAFFIC FLOW

TRAFFIC SHIFT

LIGHTED ARROW PANEL

PEDESTRIAN WALKWAY

€

TYPE III BARRICADE

SIGN

TRAFFIC BARREL

TEMPORARY TRAFFIC BARRIER

WORK ZONE

CONSTRUCTION SITE SAFETY IS THE RESPONSIBILITY OF THE CONTRACTOR. NEITHER THE OWNER NOR THE ENGINEER SHALL BE EXPECTED TO ASSUME ANY RESPONSIBILITY FOR SAFETY OF THE WORK, OF PERSONS ENGAGED IN THE WORK, OF ANY NEARBY STRUCTURES OR OF ANY OTHER PERSONS

THE LOCATIONS OF EXISTING UNDERGROUND UTILITIES ARE SHOWN IN AN APPROXIMATE WAY ONLY AND HAVE NOT BEEN INDEPENDENTLY VERIFIED. THE CONTRACTOR SHALL DETERMINE THE EXACT LOCATION OF ALL EXISTING UTILITIES BEFORE COMMENCING WORK, AND AGREES TO BE FULLY RESPONSIBLE FOR ANY AND ALL DAMAGES WHICH MIGHT BE OCCASIONED BY THE CONTRACTOR'S FAILURE TO EXACTLY LOCATE AND PRESERVE ANY AND ALL UNDERGROUND UTILITIES.

STAGE 1


ZONE



250 N HARTFORD AVE COLUMBUS, OHIO 43222 PHONE: 614.589.0087


METRO ENGINEERING SOLUTIONS

33900 SCHOOLCRAFT RD LIVONIA, MICHIGAN 48150 PHONE: 734.483.1427 FAX: 734.483.3431 www.metroes.net

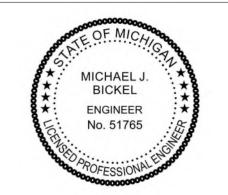

October 7, 2021

CONTRACTOR/AS-BUILT

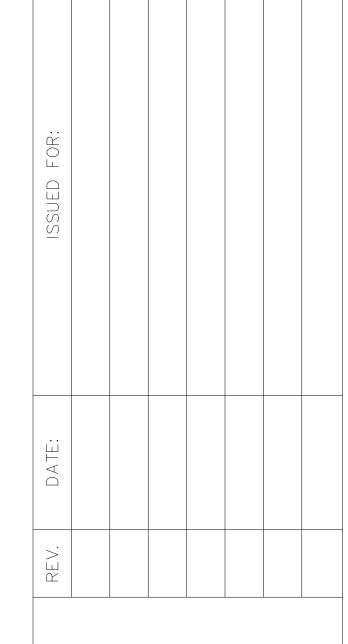

SHELBY & GRISWOLD

JOB: 1035-21-1595-TC

SITE NAME:

DET-003

DRAW DATE: 08/30/21

PLOT DATE: 10/7/21


DRAWN BY: AMM

TITLE: M.O.T.

GRAPHIC SCALE

1 inch = 20 feet (11"x17" 1 inch = 40 feet)

SHEET: 10 OF 11

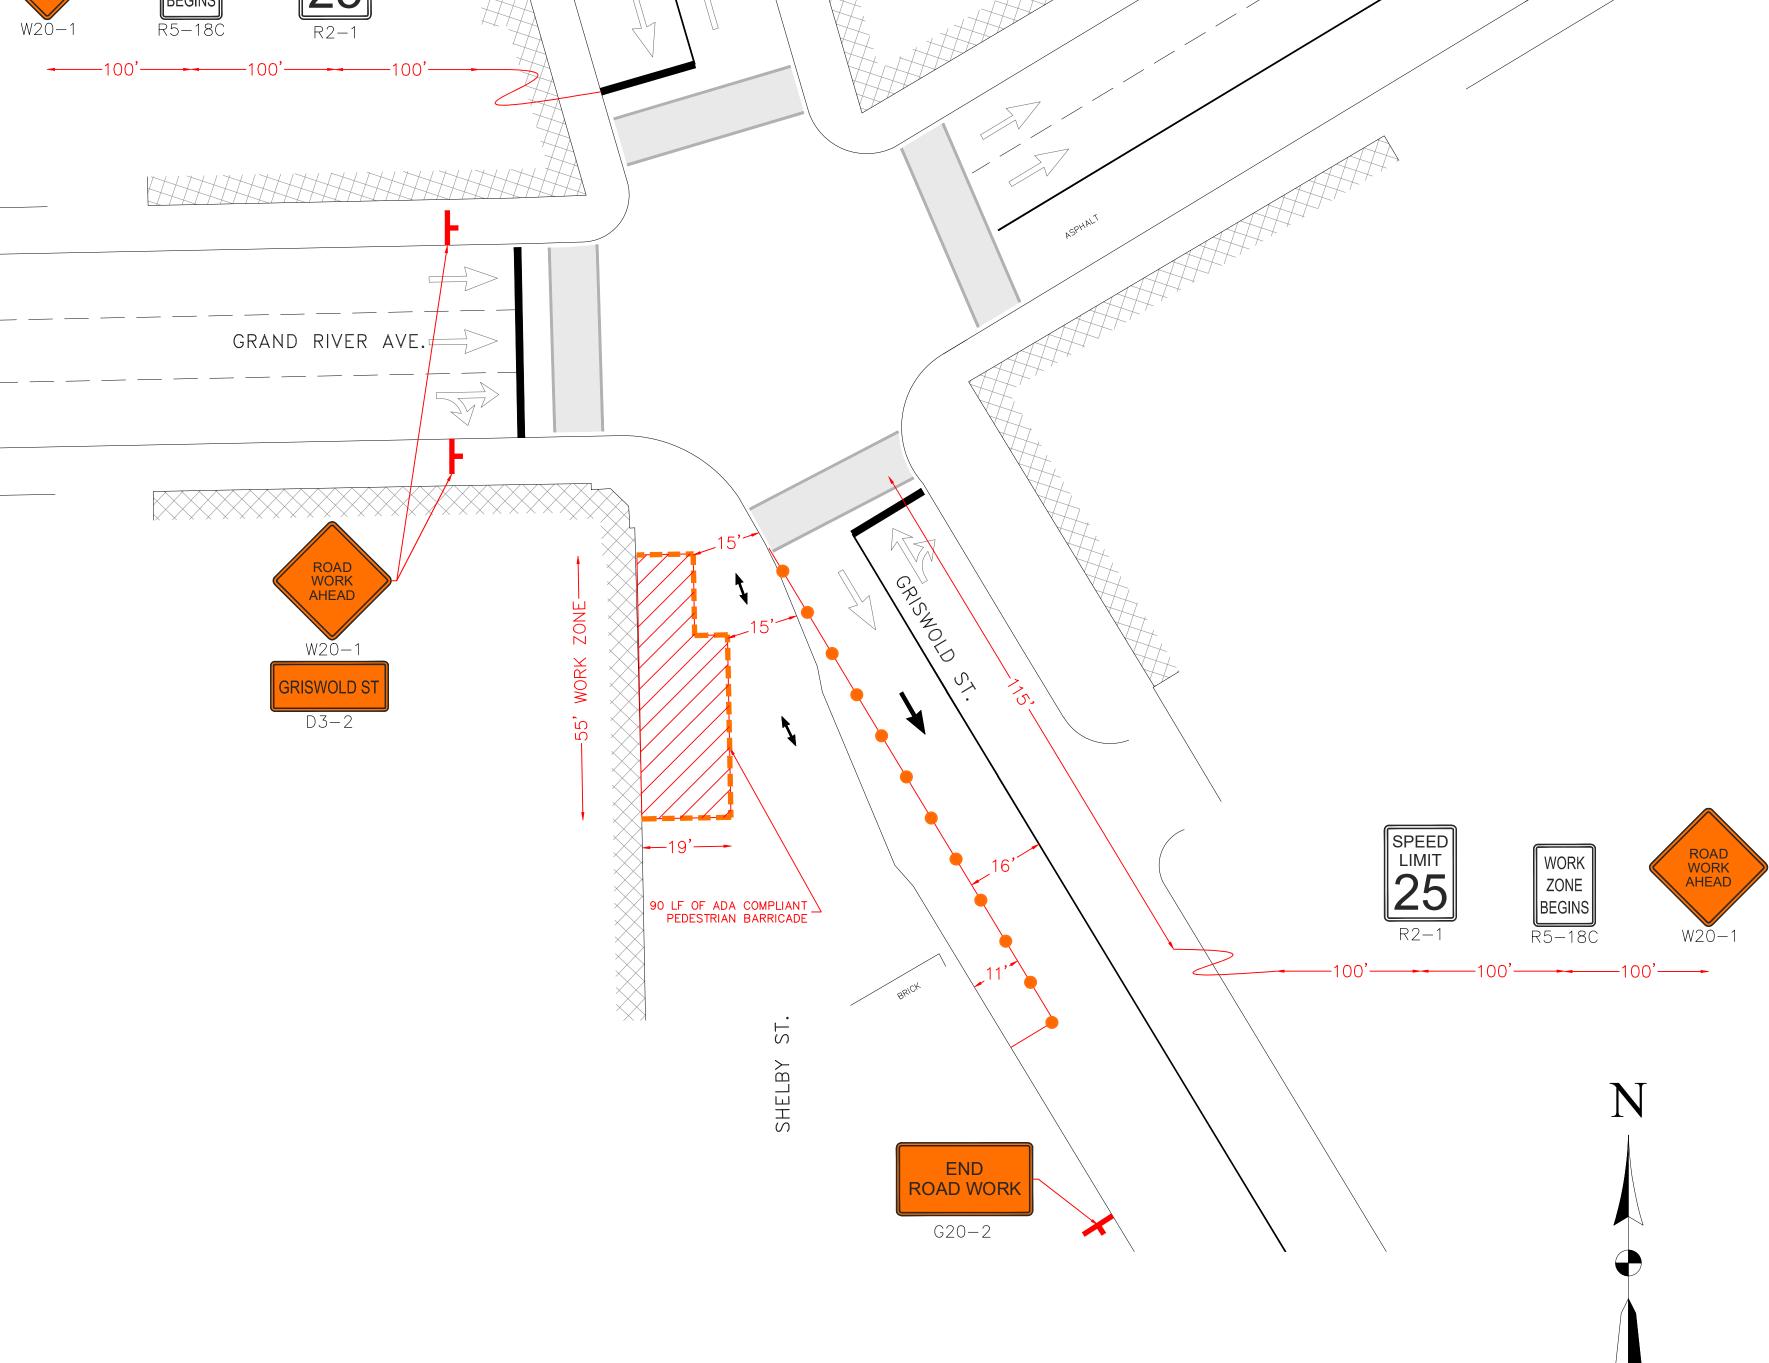

ROAD WORK

G20 - 2

STRUCTURES, OR OF ANY OTHER PERSONS.

COPYRIGHT © 2021 METRO ENGINEERING SOLUTIONS; ALL RIGHTS RESERVED.



- Two Step-N-Deploy Legs Make Deployment Quick, Easy and Safe
- Made of UV stabilized, high density polyethylene, the linkable ADA Walls quickly and easily link together in 6 foot sections to allow the contractor flexibility in creating a safe pedestrian pathway.
- Weighing only 23 lbs., the durable, yet lightweight design makes the ADA Wall easy to lift on and off the truck and easy to connect.
- The ten molded-in vertical windows reduce wind load, add strength and stability, and reduce overall weight of the ADA Wall. They also allow a guide dog to see what is on the other side of the wall.
- Two recessed areas measuring 8" wide x 53" long on each side of the ADA Wall accommodate reflective sheeting.
- Standard colors are orange and white. Custom colors also available upon request.
- The TrafFix ADA Wall can accommodate uneven surfaces to create a clear safe pedestrian pathway.

- MUNICIPAL PARKING WILL BE IMPEDED DURING THIS TEMPORARY TRAFFIC CONTROL MEASURE.

CONSTRUCTION NOTE:

CONTRACTORS MUST PROVIDE SUPPORTING DOCUMENTS TO THE CITY ENGINEERING DIVISION TO SUBSTANTIATE THAT THE REQUESTOR HAS IN THEIR POSSESSION TO INSTALL AND MAINTAIN THE REQUIRED SIGNAGE, BARRICADES, ARROW BOARDS, ETC., FOR THE CLOSURE, PRIOR TO STARTING CONSTRUCTION.

THE CED RESERVES THE RIGHT TO MODIFY THE REQUIREMENTS, SHOULD IT BECOME NECESSARY TO ENSURE SAFETY OF VEHICULAR AND NON-VEHICULAR TRAFFIC AND EFFECTIVE TRAFFIC FLOW. THE REQUESTOR SHALL BE RESPONSIBLE FOR THE UPKEEP OF THE SIGNAGE, BARRICADES, ARROW BOARDS ETC., AT ALL TIMES DURING THE CLOSURE. REQUESTOR'S FAILURE FOR THE INSTALLATION AND IT'S MAINTENANCE WOULD RESULT IN REVOKING THE PERMITS OR OTHER CORRECTIVE MEASURES. ANY COST ASSOCIATED WITH THE CORRECTIVE MEASURES WILL BE CHARGED TO THE REQUESTOR.

PEDESTRIAN TRAVEL WILL BE IMPEDED DURING THIS TEMPORARY TRAFFIC CONTROL MEASURE. - BUS TRAVEL WILL NOT BE IMPEDED DURING THIS TEMPORARY TRAFFIC CONTROL MEASURE.

LEGEND

EXISTING TRAFFIC FLOW

PROPOSED TRAFFIC FLOW

TRAFFIC SHIFT

LIGHTED ARROW PANEL

PEDESTRIAN WALKWAY

TYPE III BARRICADE

SIGN

TRAFFIC BARREL

TEMPORARY TRAFFIC BARRIER

Blow Molded

and Flexibility.

Connectors Provide Strength

WORK ZONE

CONSTRUCTION SITE SAFETY IS THE RESPONSIBILITY OF THE CONTRACTOR. NEITHER THE OWNER NOR THE ENGINEER SHALL BE EXPECTED TO ASSUME ANY RESPONSIBILITY FOR SAFETY OF THE WORK, OF PERSONS ENGAGED IN THE WORK, OF ANY NEARBY STRUCTURES, OR OF ANY OTHER PERSONS.

THE LOCATIONS OF EXISTING UNDERGROUND UTILITIES ARE SHOWN IN AN APPROXIMATE WAY ONLY AND HAVE NOT BEEN INDEPENDENTLY VERIFIED. THE CONTRACTOR SHALL DETERMINE THE EXACT LOCATION OF ALL EXISTING UTILITIES BEFORE COMMENCING WORK, AND AGREES TO BE FULLY RESPONSIBLE FOR ANY AND ALL DAMAGES WHICH MIGHT BE OCCASIONED BY THE CONTRACTOR'S FAILURE TO EXACTLY LOCATE AND PRESERVE ANY AND ALL UNDERGROUND UTILITIES.

135 LF OF ADA COMPLIANT _ PEDESTRIAN BARRICADE

END ROAD WORK

G20 - 2

STAGE 2

100'-----100'------100'-------

GRAND RIVER AVE.

D3 - 2

ROAD WORK

G20 - 2

250 N HARTFORD AVE COLUMBUS, OHIO 43222 PHONE: 614.589.0087


METRO ENGINEERING SOLUTIONS

33900 SCHOOLCRAFT RD LIVONIA, MICHIGAN 48150 PHONE: 734.483.1427 FAX: 734.483.3431 www.metroes.net



October 7, 2021

CONTRACTOR/AS-BUILT

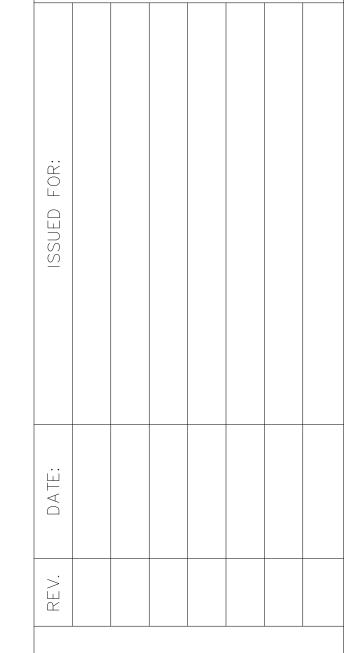

ZONE

BEGINS

GRAPHIC SCALE

1 inch = 20 feet (11"x17" 1 inch = 40 feet)

SITE NAME: DET-003 SHELBY & GRISWOLD

1035-21-1595-TC DRAW DATE: 08/30/21

PLOT DATE: 10/7/21

DRAWN BY: AMM TITLE: М.О.Т.

SHEET: 11 OF 11

Know what's below. Call before you dig.

COPYRIGHT © 2021 METRO ENGINEERING SOLUTIONS; ALL RIGHTS RESERVED.