GENERAL NOTES:

EXCEPT WHERE OTHERWISE INDICATED ON THESE PLANS, OR IN THE PROPOSAL AND SUPPLEMENTAL SPECIFICATIONS CONTAINED HEREIN, ALL MATERIALS AND WORKMANSHIP SHALL BE ACCORDING TO THE MICHIGAN DEPARTMENT OF TRANSPORTATION STANDARD SPECIFICATIONS FOR CONSTRUCTION 2012 EDITION.

CITY OF DETROIT

IN COOPERATION WITH

MICHIGAN DEPARTMENT OF TRANSPORTATION

PLANS OF

VAN DYKE ROADWAY IMPROVEMENTS


CONGER ST TO MEDBURY ST


CITY OF DETROIT

WAYNE COUNTY

PW#7027



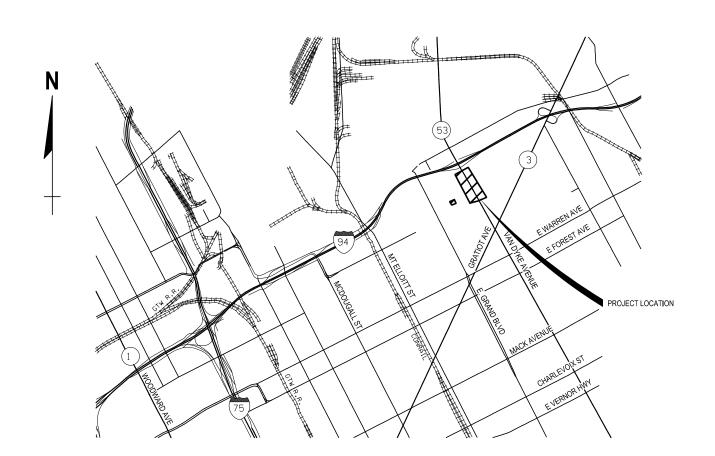

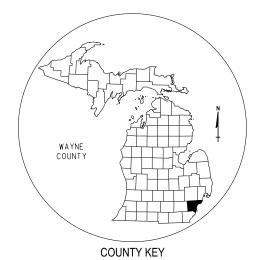

THESE PLANS WERE PREPARED FOR THE MICHIGAN DEPARTMENT OF TRANSPORTATION



DAVE RYZYI, P.E. - DIRECTOR

DATE

DATE

THE MANNIK & SMITH GROUP, INC 65 CADILLAC SQUARE, SUITE 3311 DETROIT, MI 48226 (313) 961 - 9500

LOCAL AUTHORITY APPROVAL CITY OF DETROIT

RECOMMENDED FOR APPROVAL BY:

RICHARD T. DOHERTY, P.E. - CITY ENGINEER

STEVEN R. BANNASCH, P.E. - ENGINEER SERVICES COORDINATOR

MILES: 0.15

CONTRACT FOR:

CONSTRUCTION OF TWO RIGHT TURN LANES AND SIDEWALK IMPROVEMENTS ALONG VAN DYKE AVENEUE BETWEEN CONGER STREET AND HENDRIE STREET.
RECONSTRUCTION AND REALIGN INTERSECTION OF TOWNSEND AND MEDBURY.

FINAL ROW PLAN REVISIONS (SUBMITTAL DATE:)

NO. DATE AUTH DESCRIPTION NO. DATE AUTH DESCRIPTION





NO SCALE

PUBLIC UTILITIES

The existing utilities listed below and shown on these plans represent the best information available as obtained on our surveys. This information does not relieve the contractor of the responsibility to be satisfied as to it's accuracy and the location of existing utilities.

Name Of Owner Type Of Utility

AT&T Communications

Attention: Robert Lazarecky 54 N. Mill Street Pontiac, MI 48342

Phone: (586) 466-1047 Email: RL1714@att.com

Detroit Water & Sewer Water and Sewer

Attention: Janay Haughton 6425 Huber Street Detroit, MI 48211

Phone: (313) 267-1226

Email: janay.haughton@detroitmi.gov

Great Lakes Water Authority Sewer

Attention: Anupam Kumar 6425 Huber Street Detroit, MI 48211 Phone: (313) 267-3698

Email: Anupam.Kumar@glwater.org

Gas

Attention: Michael Harrison 1 Energy Plaza Detroit, MI 48226

Phone: (313) 235-5111

Email: Michael.c.harrison@dteenergy.com

Public Lighting Authority Lighting

Lighting

Attention: Mukesh Patel 400 Monroe Street, #485 Detroit, MI 48226 Phone: (313) 558-0191

Email: mpatel@pladetroit.org

Detroit Public Lighting Attention: Amy O'Rourke Phone: (586) 803-3516 Email: aorouke@urgllc.net

NOTES APPLYING TO STANDARD PLANS

Where the following items are called for on plans, they are to be constructed according to the standard plan given below opposite each item unless otherwise indicated.

Title	Plan No.
ROAD	
DRAINAGE STRUCTURES	R-1-G *
COVER K	R-15-G *
SIDEWALK RAMP AND DETECTABLE WARNING DETAILS	R-28-J *
DRIVEWAY OPENINGS & APPROACHES AND CONCRETE SIDEWALK	R-29-I
CONCRETE CURB AND CONCRETE CURB & GUTTER	R-30-G
TRANSVERSE PAVEMENT JOINTS (PLAIN CONCRETE PAVEMENT)	R-39-K
LOAD TRANSFER ASSEMBLIES FOR TRANSVERSE JOINTS	R-40-H
LONGITUDINAL PAVEMENT JOINTS	R-41-H
TYPICAL JOINT LAYOUTS FOR CONCRETE PAVEMENT	R-42-F
LOCATION OF TRANSVERSE JOINTS IN PLAIN CONCRETE PAVEMENT	R-43-I
CONCRETE PAVEMENT REPAIR	R-44-F
GRANULAR BLANKET, UNDERDRAINS, OUTLET ENDINGS FOR UNDERDRAINS, AND SEWER BULKHEADS	R-80-E
UTILITY TRENCHES	R-83-C
SOIL EROSION & SEDIMENTATION CONTROL MEASURES	R-96-E
CHAIN LINK FENCE (USING TENSION WIRE)	R-98-B
SEEDING AND TREE PLANTING	R-100-H
SUPERELEVATION AND PAVEMENT CROWNS	R-107-H
PAVEMENT MARKINGS	
PAVEMENT ARROW AND MESSAGE DETAILS	PAVE-900-F
LONGITUDINAL LINE TYPES AND PLACEMENT	PAVE-905-D
RIGHT TURN LANE AND ISLAND PAVEMENT MARKINGS	PAVE-940-C
SIGNING	
STANDARD SIGN INSTALLATIONS	SIGN-100-G
SIGN LOCATION CODES PLACEMENT	SIGN-115-C
ROADSIDE SIGN LOCATIONS & SUPPORT SPACING	SIGN-120-E
SIGN SUPPORT SELECTION CHARTS	SIGN-150-D
STEEL POSTS	SIGN-200-E *

^{*} Denotes Special Detail

MISCELLANEOUS QUANTITES

The following items of work shall be done as they apply through the project. These items are not detailed or included in the plans sheets

SHEET INDEX

Section 1 - Road Plans					
Title	1				
Project Information	2				
Legend	3,4				
Note	5				
Typical Cross Sections	6,7				
Survey Information	8				
Alignment	9				
Removal, Construction	10-15				
Detail Grades	16-19				
Permanent Signing/Pavement Marking	20,21				

FUNDING CATEGORIES

PW#7027 Project Description MDOT Grant TED-Category A

Grant # 1373 Section 01 and 03


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ELECTRICAL

- CONTROLLER CABINET PAD MOUNTED
- HANDHOLE
- Mh MANHOLE
- POLE UTILITY EXISTING
- POLE UTILITY
- T TRANSFORMER PAD MOUNTED
- TRANSFORMER POLE MOUNTED
- ——— E —— — САВLE
- E-OH — CABLE OVERHEAD
- → E-OH → A CABLE OVERHEAD TO BE REMOVED

- CABLE IN CONDUIT DIRECTIONAL BORE

ARCHITECTURAL

- EXIT SIGN WITH EMERGENCY LIGHT
- LIGHT RECESSED FIXTURE
- **✓** MOTOR
- OUTLET BOX
- **⇒** OUTLET SINGLE
- △ OUTLET TELEPHONE
- SERVICE DISCONNECT
- E SERVICE METER
- \$ SWITCH
- \$3 SWITCH THREE WAY
- **□** WALL BRACKET FIXTURE

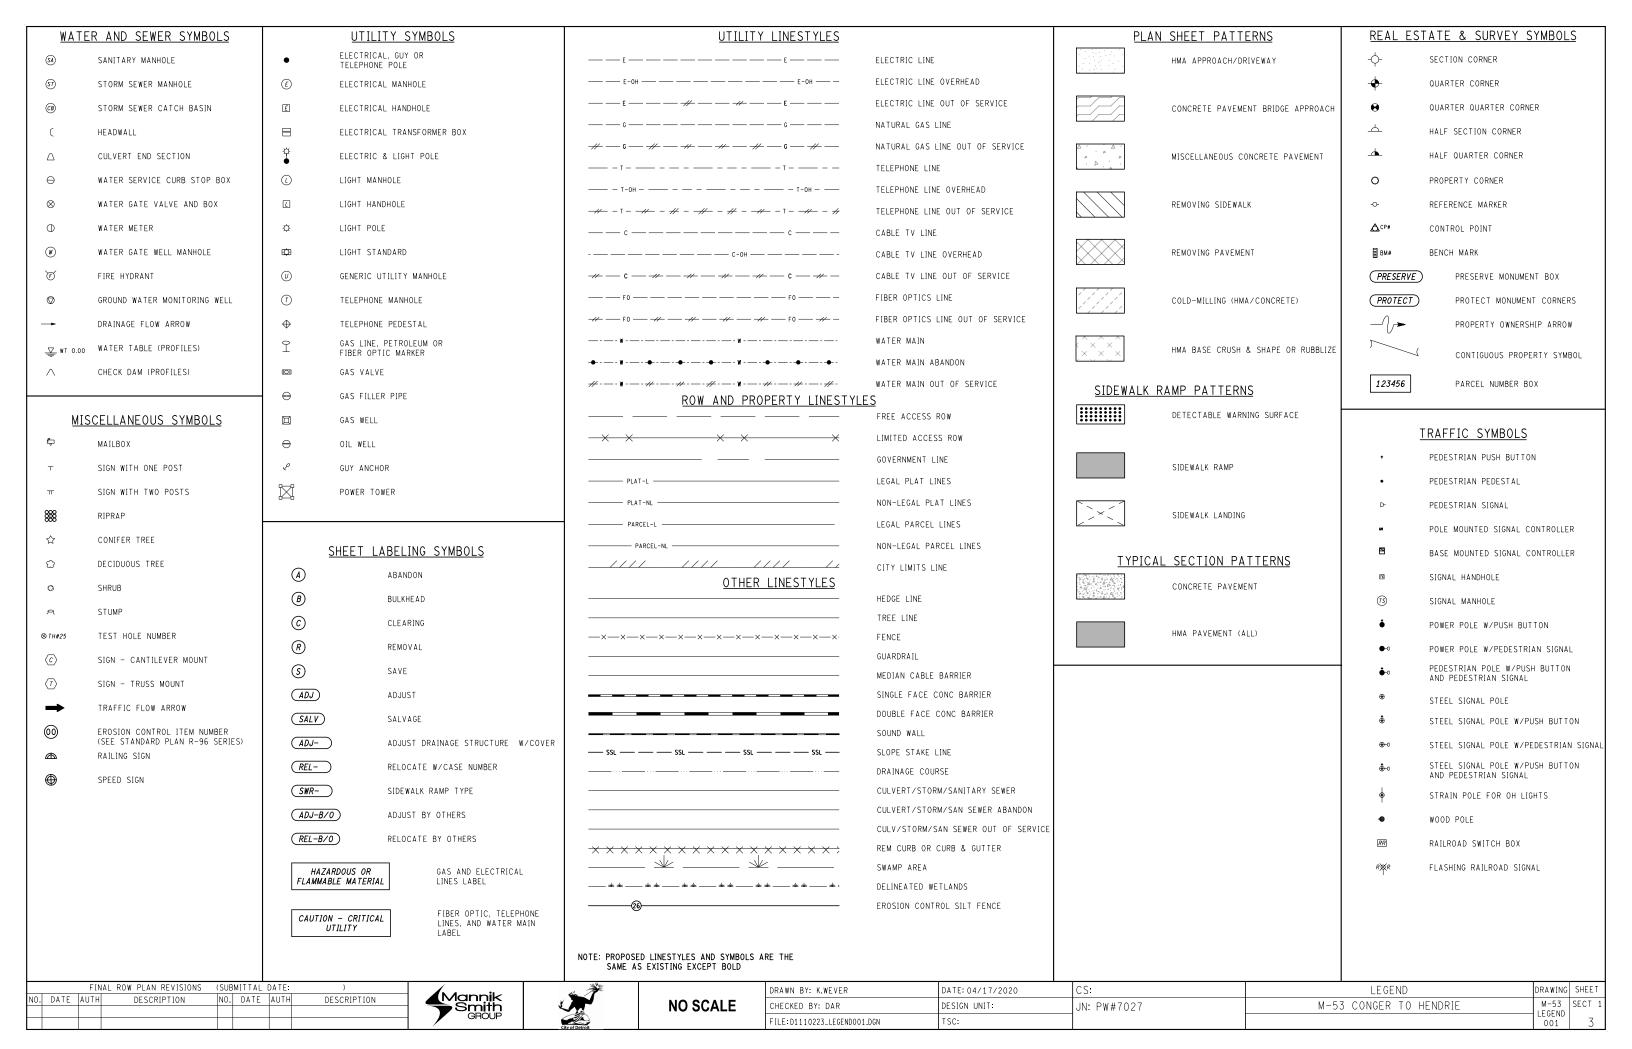LIGHTING

- CONTROL PANEL EXISTING
- CONTROL PANEL
- LIGHT STANDARD EXISTING -TO BE REMOVED & SALVAGED
- ☆-O-☆ LIGHT STANDARD DOUBLE ARM EXISTING
- LIGHT STANDARD DOUBLE ARM
- LIGHT STANDARD POST TOP EXISTING
- LIGHT STANDARD POST TOP
- LIGHT STANDARD SINGLE ARM EXISTING
- LIGHT STANDARD SINGLE ARM
- LIGHT POLE TEMPORARY
- LUMINAIRE WALL MOUNTED UNDERBRIDGE - EXISTING
- LUMINAIRE WALL MOUNTED UNDERBRIDGE
- TOWER LIGHTING UNIT EXISTING
- TOWER LIGHTING UNIT

ITS / SIGNALS

DYNAMIC MESSAGE SIGN - EXISTING

- DYNAMIC MESSAGE SIGN
 - ENVIRONMENTAL SENSOR STATION SITE
 - FIBER OPTIC SPLICE CABINET
 - HANDHOLE, ROUND, 3 FOOT DIAMETER
 - HANDHOLE, ROUND, COMMUNICATIONS
 - HANDHOLE, ROUND, ELECTRIC
 - 1 HANDHOLF, TYPE D
 - □□□ ITS CABINET EXISTING
 - ☐ ITS CABINET
 - MICROWAVE VEHICLE DETECTION ((SYSTEM - EXISTING
 - MICROWAVE VEHICLE DETECTION SYSTEM
 - MICROWAVE VEHICLE DETECTION SYSTEM ZONE COVERAGE EXISTING
 - MICROWAVE VEHICLE DETECTION SYSTEM ZONE COVERAGE
 - SPUN CONCRETE POLE EXISTING
 - ◉ SPUN CONCRETE POLE
 - SURVEILLANCE SYSTEM - EXISTING
 - SURVEILLANCE SYSTEM
 - WIRELESS LINK - EXISTING
- WIRELESS LINK COMMUNICATIONS CABLE IN CONDUIT ---- ITS -----
- ===-× its -× ===
 - COMMUNICATIONS CABLE IN CONDUIT -TO BE REMOVED

- ANTENNA
- CASE SIGN (1-WAY OR 2-WAY)
- CASE SIGN (4-WAY)
- DEDICATED SHORT RANGE COMMUNICATIONS
- CONTROLLER CABINET POLE MOUNTED
- CONTROL EMERGENCY PREEMPTION OPTICOM
- DILEMMA ZONE DETECTION
- GLOBAL POSITIONING SYSTEM MODULE
- GUY ANCHOR
- PEDESTRIAN PEDESTAL
- PEDESTRIAN PUSHBUTTON
- POLE MAST ARM (LENGTH VARIES) EXISTING
- POLE MAST ARM (LENGTH VARIES)

 - ROAD SIGN W/ FLASHING SIGN OPTICAL (1-WAY)
 - SIGNAL HANDHOLE POLYMER CONCRETE
 - SIGNAL HANDHOLE 2 FOOT ROUND
 - SIGNAL HANDHOLE 3 FOOT ROUND
 - SIGNAL HANDHOLE 2 FOOT SQUARE
 - SIGNAL HANDHOLE 4 FOOT SQUARE
 - SIGNAL HEAD PEDESTRIAN EXISTING
- SIGNAL HEAD PEDESTRIAN 1-WAY
- SIGNAL HEAD PEDESTRIAN 2-WAY
- Θ SIGNAL HEAD VEHICLE 1-WAY - EXISTING
- SIGNAL HEAD VEHICLE 2-WAY EXISTING
- SIGNAL HEAD VEHICLE 3-WAY EXISTING
- SIGNAL HEAD VEHICLE 4-WAY EXISTING
- SIGNAL HEAD VEHICLE 1-WAY
- SIGNAL HEAD VEHICLE 2-WAY
- SIGNAL HEAD VEHICLE 3-WAY
- SIGNAL HEAD VEHICLE 4-WAY
- SIGNAL HEAD VEHICLE BAGGED
- SIGNAL HEAD VEHICLE PROGRAMMABLE
- VEHICLE DETECTION CAMERA
- VEHICLE DETECTION CAMERA HEMISPHERICAL Δ
- VEHICLE DETECTION LOOP
 - VEHICLE DETECTION RADAR
 - WIRELESS VEHICLE DETECTION RADIO RECEIVER
 - WIRELESS VEHICLE DETECTION RADIO REPEATER
 - WIRELESS VEHICLE DETECTION SENSOR EXISTING
 - WIRELESS VEHICLE DETECTION SENSOR

CABLING / WIRING DIAGRAM

- CIRCUIT BREAKER
- COILED WIRE
- FUSE
- FUSE SWITCH
- ILLUMINATED CASE SIGN



METER



 \circ SIGNAL HEAD

NOTF:

EXISTING ITEMS ARE REPRESENTED BY THIN LINE WEIGHTS. PROPOSED ITEMS ARE REPRESENTED BY HEAVIER LINE WEIGHTS.

FINAL ROW PLAN REVISIONS (SUBMITTAL DATE: DESCRIPTION NO. DATE AUTH DESCRIPTION









DRAWN BY: K.WEVER DATE: 04/17/2020 DESIGN UNIT: CHECKED BY: DAR TSC: FILE: D1170223_Legend002.dgn

CS: JN: PW#7027

LEGEND DRAWING SHEET M-53 CONGER TO HENDRIE M-53 SECT : .EGEND

GENERAL NOTES

UTILITIES

MISS DIG/UNDERGROUND UTILITY NOTIFICATION

For the protection of underground utilities and in conformance with Public Act 174 of 2013, the Contractor shall contact MISS DIG System, Inc. by phone at 811 or 800-482-7171 or via the web at either elocate.missdig.org for single address or rte.missdig.org, a minimum of 3 business days prior to excavating, excluding weekends and holidays.

OUT OF SERVICE UTILITIES

If plan information indicates an existing underground utility is or will be out of service within the limits of this contract, the Contractor is cautioned to treat such a line as if it were still in service and notify "Miss Dig" when working in the area of the out of service facility.

EXISTING WATER MAINS AND SEWERS

The Contractor shall be responsible for any damage to properly identified existing water mains and/or existing sewers during the construction of this project.

ROW / REAL ESTATE

PROPERTY OWNERS

Property owner's names, where shown, are for information only, and their accuracy is not guaranteed.

MARKETABLE TIMBER

Marketable timber shall be made available to the property owner in accordance with Section 201.03 of the 2012 Standard Specifications for

LAWN SPRINKLER SYSTEMS AND LANDSCAPING

Owners of existing lawn sprinkler systems and/or landscaping shall be notified (in writing with a copy sent to the Engineer) by the Contractor two weeks in advance of any work to be done that will affect those systems and/or landscaping. If the property owner fails to relocate the lawn sprinkler system prior to the Contractor beginning work, and if the Contractor cuts the system during the construction, the Contractor shall cap the system pipe and witness the location of the cap with a wooden stake for the property owner's use. The Contractor shall place the salvaged sprinkler heads on the property owner's property. If the property owner fails to relocate the landscaping prior to the Contractor beginning work, the Contractor shall carefully salvage the landscaping items and stockpile them on the property owner's property for the property owner. Any other modification to the lawn sprinkler systems and/or landscaping is the responsibility of the owner and is not part of this contract. This work is included in other items of the project.

SURVEY

ADJUSTING MONUMENT BOXES

All government corners on this project shall be preserved, whether shown or not. It may be necessary to place or adjust monument boxes, as required.

STATIONING

Stationing on this project was taken from old plans and pavement stenciled stationing and is not necessarily accurate

DETAILED GRADES

GRADES FOR INTERSECTIONS

All intersections are to be considered as complete units and their grades determined before construction is started.

FINAL ROW PLAN REVISIONS (SUBMITTAL DATE

SIGNALIZED SIDE ROAD TO TRUNK LINE INTERSECTIONS:

The normal edge of pavement grade of the proposed trunk line adjacent to the side road intersection shall be carried across the intersection wherever possible. The side road approach grade and crown shall be established to provide for drainage and to assure suitable rideability of the side road.

SIGNALIZED TRUNK LINE TO TRUNK LINE INTERSECTIONS:

The grades to be established shall provide for drainage and rideability of each trunk line. Crowns may be varied on each trunk line to best fit the longitudinal grades of each trunk line.

UNSIGNALIZED SIDE ROAD TO TRUNK LINE INTERSECTIONS:

The normal edge of pavement grade of the proposed trunk line adjacent to the side road intersection shall be carried across the intersection. The side road approach grade and crown shall be established to provide for drainage.

SIDEWALK AND SIDEWALK RAMP GRADES

All sidewalk and sidewalk ramp grades shall be staked according to Standard Plan R-28 series and as shown on the plans. Prior to constructing the sidewalk and sidewalk ramps, the Engineer will verify the grades and authorize the construction of the sidewalk and sidewalk ramps

EARTHWORK

EARTHWORK

Earthwork quantities are computed based upon limited survey information. These quantities are for bidding purposes only and will be adjusted by the Engineer based upon actual field measurements.

SLOPES

Class A slopes shall be constructed on this project.

EARTH DISTURBANCE LIMITS

The earth disturbance limit for this project will be limited to 10' beyond the slope stake line or to the ROW line whichever is less for all areas except for wetland areas. For areas adjacent to wetlands, the earth disturbance limit will be limited to the slope stake line. Restoration measures have been included in this set of plans for the approved areas of disturbance. The Contractor shall submit an earth change plan for any work beyond the approved limits to the Engineer to review for approval prior to the disturbance. All costs for obtaining and executing an approved earth change plan, including restoration, shall be at the Contractor's expense.

SOIL EROSION MEASURES

Appropriate soil erosion and sedimentation control measures shall be in place prior to earth-disturbing activities. Place turf establishment items as soon as possible on potential erodable slopes as directed by the Engineer. Critical ditch grades shall be protected with either sod or seed/mulch or mulch blanket as directed by the Engineer.

BASES

AGGREGATE BASE

Aggregate bases shall use aggregate 21AA unless otherwise specified.

DRAINAGE

CULVERT EXTENSIONS

The extension of existing culverts on this project may require extra work to obtain a tight seal at the joint connecting new culvert pipe to existing culvert pipe. The joint between the existing and new pipes shall be constructed according to the 2012 Standard Specifications for Construction. Any extra work required to obtain tight joints will not be paid for separately, but will be included in compensation for extending culverts.

ILLICIT CONNECTIONS TO STORM WATER SYSTEM

Connections to existing storm conveyance systems not shown on the plans must be reconnected with minimal interruption in service. Size, type and location by station and offset and any suspect illicit discharge observed shall be reported to the Engineer prior to reconnecting. Contractor shall proceed as directed by the Engineer.

TEMPORARY BULKHEADS

Temporary bulkheads may be required for the part width construction of the culverts and sewers. All cost associated with the temporary bulkheads are included in the item of the pipe.

PAVEMENT

PAVEMENT AND HMA SURFACE REMOVAL QUANTITIES

Pavement and HMA Surface removal as shown on the plans will be at the discretion of the Engineer. If in his/her judgment, areas of pavement may be left in place, or additional areas added to provide the proper crosssection and base. Changes will be made in the quantities.

SOIL BORINGS AND/OR PAVEMENT CORES

The soil boring logs and/or pavement cores represent point information. No inference should be made that subsurface or pavement conditions are the same at other locations

CONCRETE HAND FINISHING

Hand finishing of concrete pours to be struck off and consolidated by hand methods will be permitted on variable width lanes and lanes formed by flexible forms for short radius curves, as directed by the Engineer.

The type of concrete to be used on this project for the pavement repairs is Type P1

INTERSECTION CONCRETE JOINT LAYOUT

The Contractor shall layout all joints for the intersections 5 days prior to concrete placement for the review of the Engineer. The Designer will furnish blank intersection worksheets (11" x 17") to scale (1"=40') showing all proposed curb lines, longitudinal lane lines and all existing and proposed utility/drainage structure covers within the intersections to the Engineer prior to the pre-construction meeting. These worksheets will be available for the Contractor's use.

TURF ESTABLISHMENT

SEED MIXTURE

The symbol for the permanent turf seed mixture on this project is symbol

SIGNS

All signs shall be installed, removed and/or salvaged according to the current edition of "Michigan Manual on Uniform Traffic Control Devices" and the current edition of Michigan Department of Transportation (MDOT) "Standard Specifications For Construction."

All signs on the plans or in the log that do not have a recommendation are to be retained

EXISTING SIGN RELOCATION

Any permanent signs requiring relocation due to Contractor operations shall be salvaged and reset by the Contractor at locations designated by the Engineer. Signs and posts damaged during the removal and storage operations shall be replaced with new signs and posts. The cost of this work shall be borne by the Contractor.

DATE: 04/17/2020

DESIGN UNIT:

TSC:

At least two weeks prior to construction to remove / relocate Michigan Logo or tourist oriented directional signs; the Contractor shall contact Mike Kovalchick, (888) 645-6467 from Michigan Logos.

DELINEATOR POST REPLACEMENT

The Contractor shall remove and dispose of all existing delineator posts along the roadway where new posts are placed. This work will be considered as included in the cost of placing new delineator posts.

The final plans submitted with the proposal are not to scale. Where proposed on plan sheets, the signs and structures shall be fabricated in accordance to Typical Plans. Standards, and/or Details at locations

SIGN LAYOUT

Sign layouts shall be according to the current English edition of "Standard Highway Signs" manual or as detailed in plans. Legend length shall be determined using the "SignCAD" software.

Handling and installation of all signs shall conform with the sheeting manufacturer's specifications and guidelines.

Splice sheeting used for Type I signs with a 3" overlap.

Signs that have wrinkled or twisted sheeting may be rejected.

SIGN INSTALLATION

When attaching signs to supports, tighten the nut, not the bolt head.

Nylon washers shall be placed between the steel washer and the sign face sheeting. The nylon washers are to be considered part of the attaching devices and hardware. Nylon washers shall have a 3/8 inch inner diameter, a 7/8 inch outer diameter and a 1/16 inch thickness.

The Contractor shall attach a date sticker to the back of all signs installed on the contract. Stickers will be supplied to the Contractor at the preconstruction meeting by the Engineer. Stickers will be supplied by MDOT Operations Field Services Division Statewide Sign Shop, Lansing, which can be contacted at 517-322-3357.

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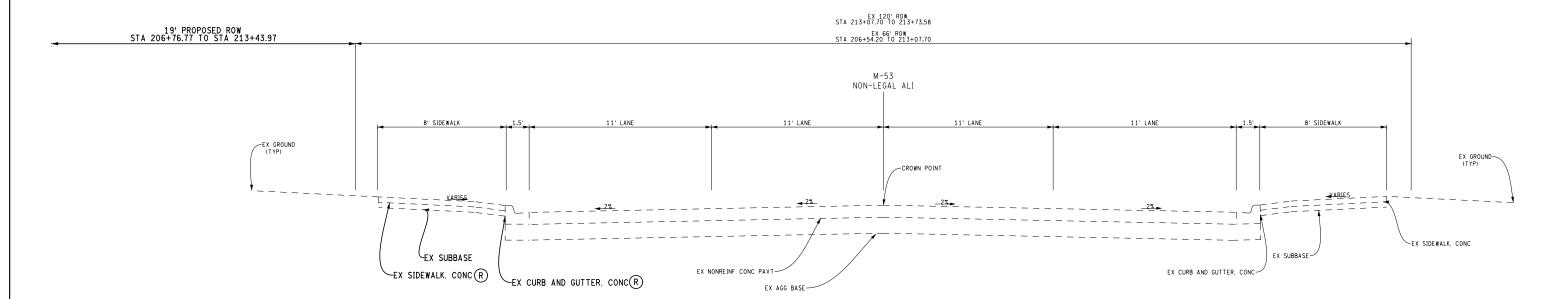







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SECT 1




EXISTING NORMAL SECTION SECTION APPLIES TO: M-53 STA 206+54.20 (POB) TO STA 213+73.58 (POE)

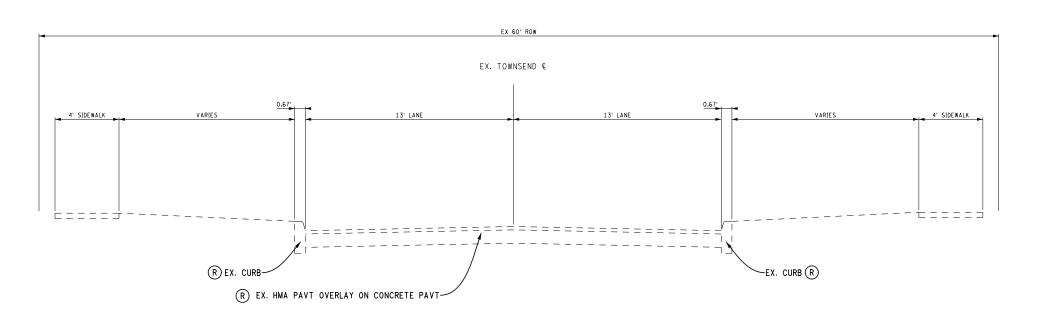

EXISTING NORMAL SECTION SECTION APPLIES TO: TOWNSEND ST AND MEDBURY ST INTERSECTION

FINAL ROW PLAN REVISIONS (SUBMITTAL DATE:) Mappik		O VERT. (FT) 6	DRAWN BY: ASH	DATE: 04/17/2020	CS:	EXISTING TYPICAL CROSS SECTION	DRAWING SHEET
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	GROUP	City of Detroit	O HORZ. (FT) 6	FILE: D1170223_TYP001	TSC:		TOWNSEND AND MEDBURY INTERSECTION	EXTYP 001 6

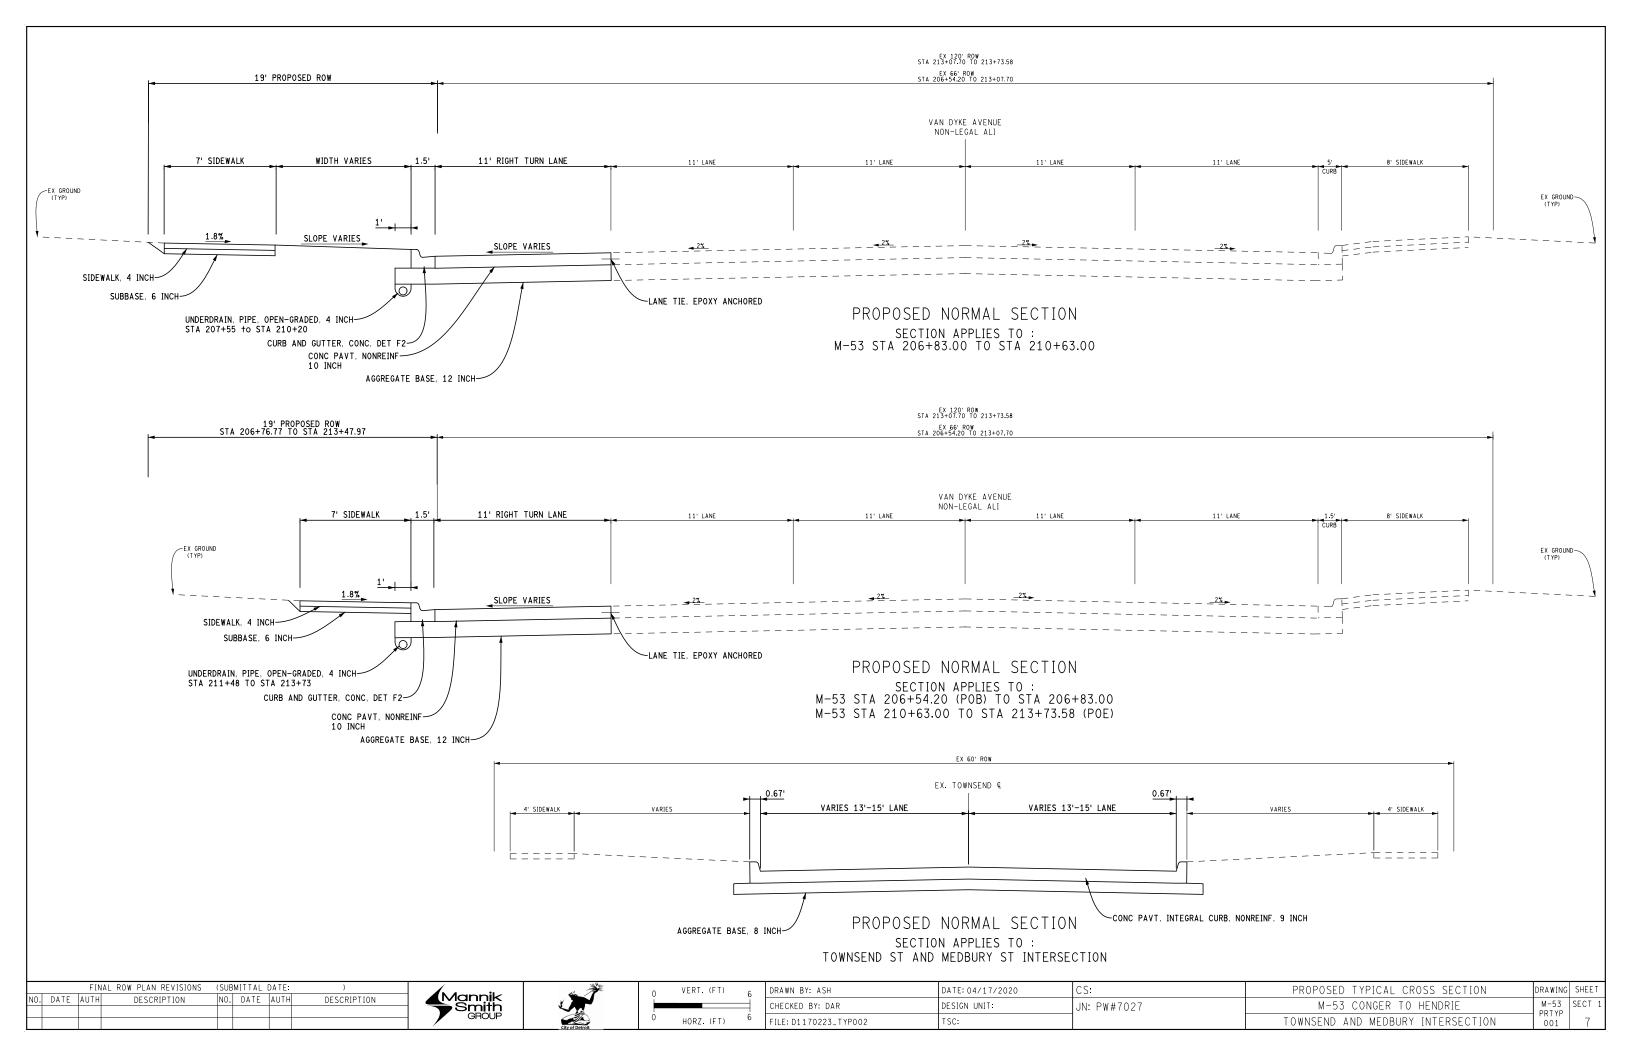

NOTES

COORDINATE SYSTEM: STATE PLANE GRID

ZONE: MICHIGAN SOUTH 2113

ELLIPSOID: GRS 80

HORIZONTAL DATUM: NAD 83 (2011)
VERTICAL DATUM: NAVD 88
GEOID: GEOID 12B

UNITS: INTERNATIONAL FEET

GROUND DISTANCE CONVERSION

THE COMBINED SCALE FACTOR (CSF) FOR EACH CONTROL POINT IS INCLUDED IN THE CONTROL POINT LIST.

AVERAGE COMBINED SCALE FACTOR (ACSF) = (CSF1 + CSF2)/2 GROUND DISTANCE = GRID DISTANCE / ACSF

CONTROL IS FOR LOCAL PROJECT ONLY

INTERMEDIATE CONTROL

CONTROL PT #: CP100
DESCRIPTION: MAG NAIL ON EAST SIDE OF M-53 (VAN DYKE),
OPPOSITE SIDE OF W. HENDRIE STREET
STATION 27+08.94, OFFSET 24.48' LT.
COORDINATES: N = 324400.91 E = 13487992.55
ELEV = 622.86
COMBINED SCALE FACTOR: 0.9999207901

CONTROL PT #: CP104
DESCRIPTION: MAG NAIL ON WEST SIDE OF M-53 (VAN DYKE),
OPPOSITE SIDE OF E. CONGER STREET
STATION 18+93.88, OFFSET 32.09' RT.
COORDINATES: N = 325084.94 E = 13487545.73
ELEV = 625.38
COMBINED SCALE FACTOR: 0.9999203815

CONTROL PT #: CP106

DESCRIPTION: MAG NAIL IN SOUTHEAST QUADRANT OF M-53 (VAN DYKE) AND EASTBOUND INTERSTATE 94 SERVICE DRIVE STATION 12+24.78, OFFSET 34.50' LT.

COORDINATES: N = 325701.57 E = 13487277.61

ELEV = 627.16

COMBINED SCALE FACTOR: 0.9999200385

CONTROL PT #: CP167
DESCRIPTION: MAG NAIL ON WEST SIDE OF M-53 (VAN DYKE),
OPPOSITE SIDE OF E. LAMBERT STREET
STATION 15+65.80, OFFSET 30.33' RT.
COORDINATES: N = 325372.22 E = 13487387.30
ELEV = 626.22
COMBINED SCALE FACTOR: 0.9999202192

CONTROL PT #: CP401
DESCRIPTION: 1/2" X 18" CAPPED IRON ON WEST SIDE OF M-53
(VAN DYKE), IN THE SOUTHWEST QUADRANT OF M-53 AND
WESTBOUND INTERSTATE 94 SERVICE DRIVE
STATION 8+94.42, OFFSET 68.63' RT.
COORDINATES: N = 325939.71 E = 13487026.48
ELEV = 629.96

CONTROL PT #: CP600

DESCRIPTION: MAG NAIL IN SOUTHEAST QUADRANT OF M-53 (VAN DYKE) AND EASTBOUND INTERSTATE 94 SERVICE DRIVE STATION 12+04.95, OFFSET 57.88' LT. COORDINATES: N = 325730.28 E = 13487288.35

ELEV = 627.15

COMBINED SCALE FACTOR: 0.9999200270

BENCHMARKS

BENCHMARK #: BM200
DESCRIPTION: R.R. SPIKE IN S.E. FACE OF UTILITY POLE AT N.W.
CORNER OF M-53 (VAN DYKE) AND HENDRIE STREET
STATION 26+67.79, OFFSET 68.37' RT.
COORDINATES: N = 324392 E = 13487891
ELEV = 624.06
COMBINED SCALE FACTOR: 0.9999207359

BENCHMARK #: BM204
DESCRIPTION: ARROW ON HYDRANT AT N.W. CORNER OF M-53
(VAN DYKE) AND CONGER STREET
STATION 18+48.32, OFFSET 25.00' RT.
COORDINATES: N = 325128 E = 13487530
ELEV = 628.05
COMBINED SCALE FACTOR: 0.9999202357

BENCHMARK #: BM206
DESCRIPTION: S.W. ANCHOR BOLT ON LIGHT POLE BASE, S.W.
CORNER OF M-53 (VAN DYKE) AND EASTBOUND INTERSTATE 94
SERVICE DRIVE
STATION 12+32.83, OFFSET 64.28' RT.
COORDINATES: N = 325646 E = 13487195
ELEV = 628.38
COMBINED SCALE FACTOR: 0.9999200025

FINAL ROW PLAN REVISIONS			(SUBN	IITTAL	DATE:	04/0	1/2020)		
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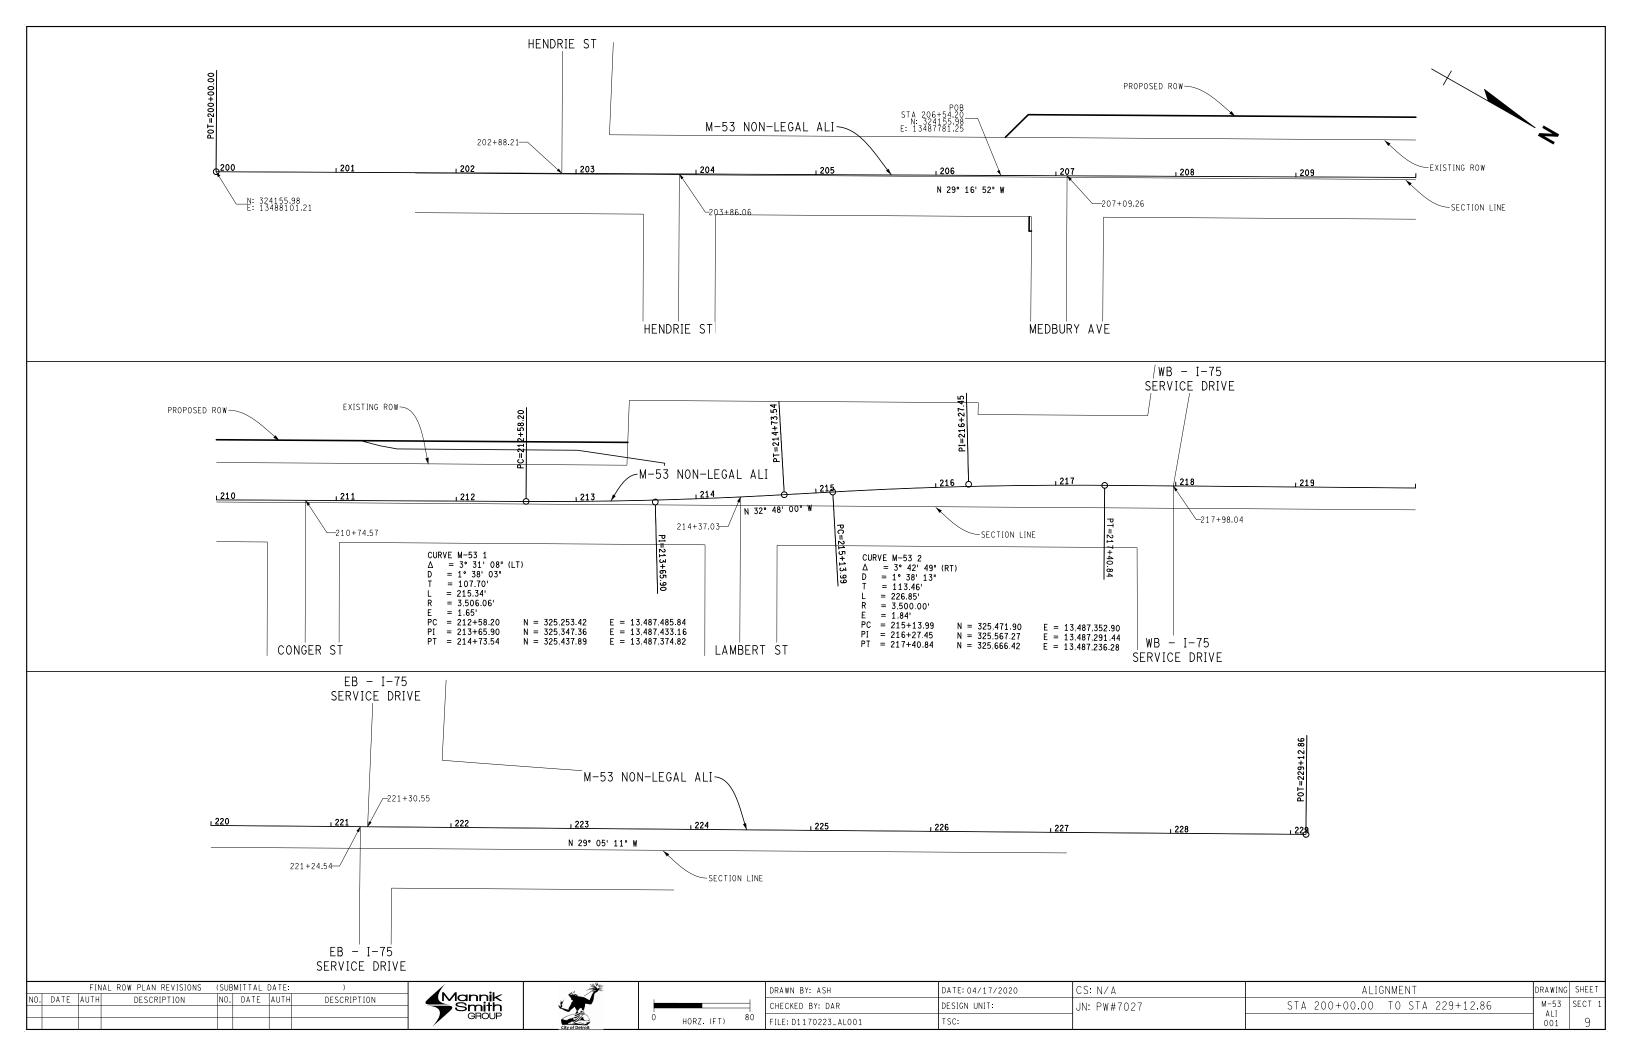
COMBINED SCALE FACTOR: 0.9999198042






NO SCALE

	DATE: 04/17/2020	CS: 82151	SURVEY INFORMATION SHEET	DRAWING	SHEET
	DESIGN UNIT:	JN: PW#7027		SURVEY	SECT 1
LE: S-1170223_Survey_Info_Sheet	TSC:			001	8





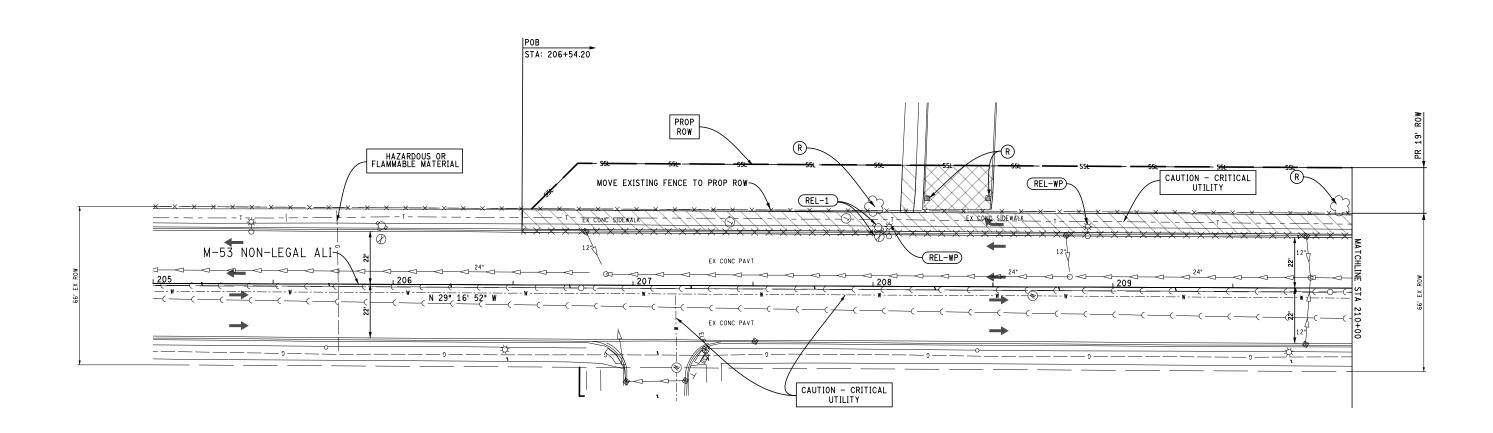


REMOVAL QUANTITIES - THIS SHEET

346 Ft Curb and Gutter, Rem, Modified
320 Syd Sidewalk, Rem
1 Ea Hydrant, Relocate, Case 1
2 Ea Wood Pole
2 Ea Tree, Rem, 6 inch to 18 inch
396 Cyd Excavation, Earth, Modified
59 Syd Pavt, Rem
2 Ea Dr Structure, Abandon
342 Ft Fence, Moving

MEDBURY STREET

FINAL ROW PLAN REVISIONS (SUBMITTAL DATE:)	Mappik	DRAWN BY: ASH	DATE: 04/17/2020	CS:	REMOVAL	DRAWING SHEET
NO. DATE AUTH DESCRIPTION NO. DATE AUTH DESCRIPTION	Mannik Smith GROUP	CHECKED BY: DAR	DESIGN UNIT:	JN: PW#7027	M-53 205+00 TO STA 210+00	M-53 SECT 1
	GROUP	O HORZ. (FT) 40 FILE: D1170223_RM001	TSC:			7 001 10



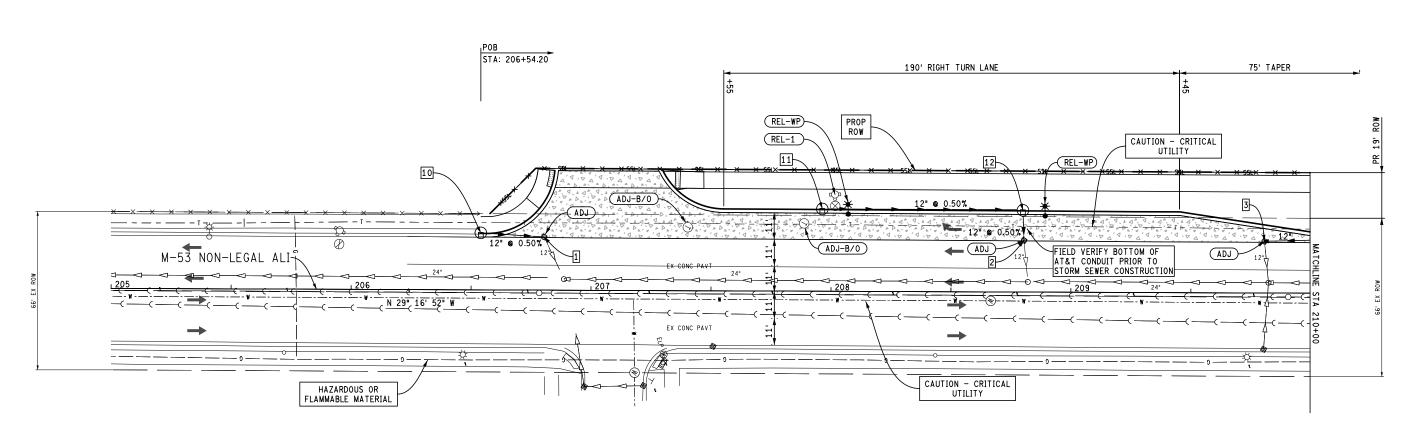

Structure Number	STRUCTUR Station	RE AND SEV	WER TABLE	Inverts	Sewer, CL A, 12 inch, Tr Det B	Dr Structure, 48 inch dia	Dr Structure Cover, Sewer MH, Modified	Dr Structure Cover, Type K
		FT			FT	EA	EA	EA
1 (Ex.)	206+80.37	22.15	623.49	Ex 12" NE - 618.39 12" S - 618.39			1	
2 (Ex.)	208+80.80	21.5	624.19	Ex 12" E - 618.89 12" W - 618.89			1	
3 (Ex.)	209+80.61	21.5	624.55	Ex 12" E - 617.90 12" N - 617.90			1	
10	206+54.00	22.65	623.41	12" N - 618.45	12	1		1
11	206+96.00	34.25	623.68	12" N - 619.38	84	1		1
12	208+80.00	34.25	624.01	12" S - 618.96 12" E - 618.96	13	1		1
			•	Total	109	3	3	3

FINAL ROW PLAN REVISIONS (SUBMITTAL DATE:

NO. DATE AUTH

CONSTRUCTION QUANTITIES - THIS SHEET

Curb and Gutter, Conc, Det F2
Curb Ramp Opening, Conc
Sidewalk Ramp, ADA, Modified
Sidewalk, Conc, 4 inch, Modified
Detectable Warning Surface Tile, Modified
Conc Pavt, Nonreinf, 10 inch
Aggregate Base, 12 inch
Underdrain, Pipe, Open-Graded, 4 inch
Dr Structure Cover, Adj, Case 1, Modified
Embankment, CIP
Joint, Contraction, Cp 300 F+ 23 F+ 215 S++ 215 Sff 1922 Sff 14 Ff 474 Syd 562 Syd 250 Ff 3 Ea 17 Cyd 300 Ff 98 Ea 3 Ea

Joint, Contraction, Cp
Lane Tie, Epoxy Anchored
Sewer Tap, 12 inch
* Drainage Quantities in Table

DESCRIPTION

Mannik Smith GROUP






MEDBURY STREET

DRAWN BY: ASH	DATE: 04/17/2020	CS:	CONSTRUCTION	DRAWING	SHEET
CHECKED BY: DAR	DESIGN UNIT:	JN: PW#7027	M-53 STA 205+00 TO STA 210+00	M-53 CON	SECT 1
FILE: D1170223_CN001	TSC:			001	1 1



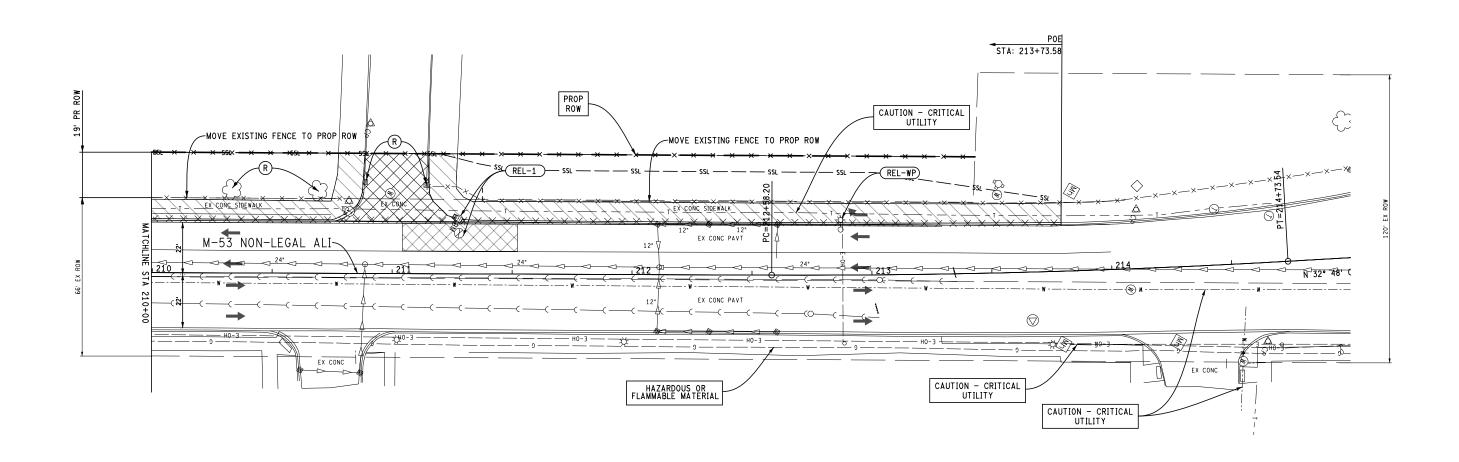

REMOVAL QUANTITIES - THIS SHEET

Curb and Gutter, Rem, Modified Fence, Moving Pavt, Rem Pavt Repr, Rem Saw Cut, Intermediate Sidewalk, Rem Hydrant, Relocate, Case 1 Tree, Rem, 6 inch to 18 inch Excavation, Earth, Modified Dr Structure, Abandon Wood Pole 380 F+ 380 F+ 98 Syd 61 Syd 22 F+ 354 Syd 1 Eq 2 Eq

300 Cyd 2 Ea 1 Ea


LAMBERT STREET

CONGER STREET

		FIN	AL ROW PLAN REVISIONS	(SUB	BMITTAL	DATE:)	<i>1</i>				DRAWN BY: ASH
NO.	DATE	AUTH	DESCRIPTION	NO.	DATE	AUTH	DESCRIPTION	Mannik			_	CHECKED BY: DAR
								Smith			- 40	
									U U	HORZ. (FT)	70	FILE: D1170223_RM002

DATE: 04/17/2020 CS: REMOVAL DRAWING SHEET M-53 SECT 1 REM 002 12 DESIGN UNIT: M-53 STA 210+00 TO STA 215+00 JN: PW#7027 TSC:



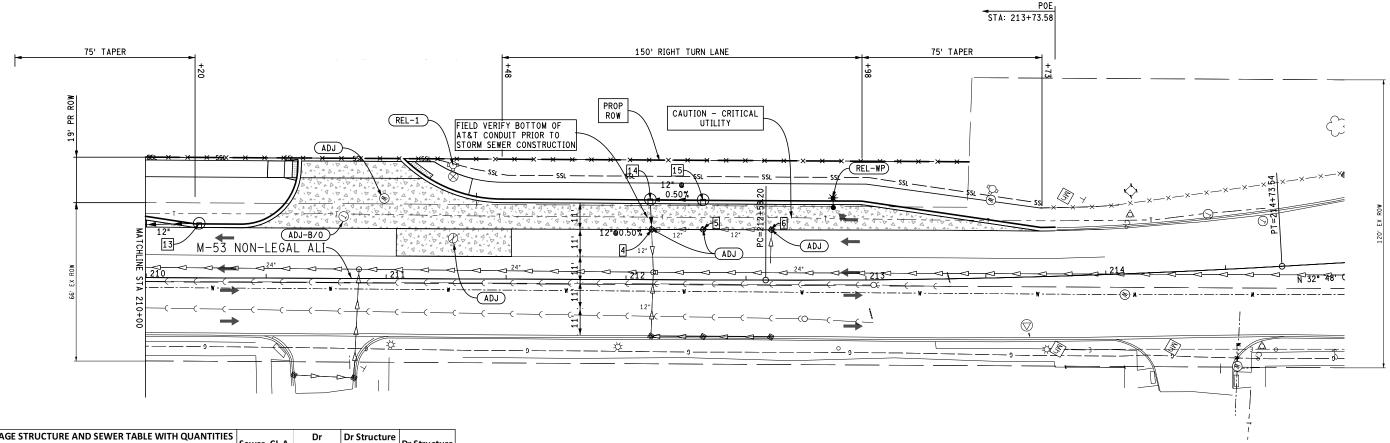

Structure Number	E STRUCTUF Station	Offset	WER TABLE	Inverts	Sewer, CL A, 12 inch, Tr Det B	Dr Structure, 48 inch dia	Dr Structure Cover, Sewer MH, Modified	Dr Structure Cover, Type K
		FT			FT	EA	EA	EA
4 (Ex.)	212+10.61	21.95	624.84	Ex 12" E - 618.44 Ex 12" N - 618.44 12" W - 618.44			1	
5 (Ex.)	212+32.06	21.95	624.85	Ex 12" N - 619.65 Ex 12" S - 618.65			1	
6 (Ex.)	212+60.53	21.95	624.85	Ex 12" S - 619.70 Ex 10" E - 621.25			1	
13	210+22.00	22.72	624.69	12" S - 618.11	42	1		1
14	212+10.00	33.44	624.60	12" N - 618.54 12" E - 618.54	13	1		1
15	212+32.00	33.37	624.53	12" N - 618.62 12" S - 618.62	22	1		1
				Total	77	3	3	3

CONGER STREET

		F IIV	AL KOW FLAN KEVISIONS	1300	DIVITIAL	DATE.	,
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DRAWN BY: ASH	DATE: 04/17/2020
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FILE: D1170223_CN002	TSC:


CS:	
JN: PW#7027	

CONSTRUCTION	DRAWING	SHEET
M-53 STA 210+00 TO STA 215+00	M-53 CON	SECT 1
	002	1 3

CONSTRUCTION QUANTITIES - THIS SHEET

Curb and Gutter, Conc, Det F2
Curb Ramp Opening, Conc
Sidewalk Ramp, ADA, Modified
Sidewalk, Conc, 4 inch, Modified
Detectable Warning Surface Tile, Modified
Conc Pavt, Nonreinf, 10 inch
Pavt Repr, Nonreinf Conc, 10 inch
Aggregate Base, 12 inch
Underdrain, Pipe, Open-Graded, 4 inch
Dr Structure Cover, Adj, Case 1, Modified
Water Shutoff, Adj, Case 1, Modified
Embankment, CIP
Joint, Contraction, Cp
Lane Tie, Epoxy Anchored
Joint, Contraction, Crg
Sewer Tap, 12 inch
* Drainage Quantities in Table
REET 324 F+
34 F+
258 Sf+
2082 Sf+
18 F+
447 Syd
61 Syd
608 Syd
253 F+
4 Ea
1 Ea
68 Cyd
305 F+
119 Ea
22 F+
1 Ea

LAMBERT STREET

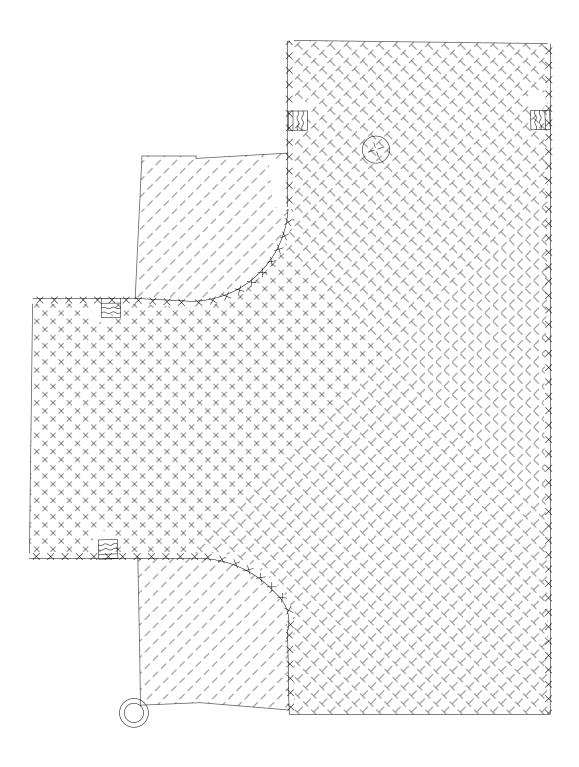

MEDBURY STREET

REMOVAL QUANTITIES - THIS SHEET

160 Ft Curb and Gutter, Rem 48 Syd Sidewalk, Rem 287 Syd Pavt, Rem


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DRAWN BY:	DATE: 04/17/2020	CS:	REMOVAL	DRAWING	SHEET
CHECKED BY:	DESIGN UNIT: DETROIT	JN: PW#7027	TOWNSEND AND MEDBURY INTERSECTION	REM	SECT 1
FILE: D1170223_RM003.dgn	TSC: WARREN			003	14



CONSTRUCTION QUANTITIES - THIS SHEET

217 Syd 19 Ft 211 Sft 12 Ft Conc Pavt with Integral Curb, Nonreinf, 9 inch Curb Ramp Opening, Conc Sidewalk Ramp, ADA, Modified Detectable Warning Surface Tile, Modified

232 Syd Aggregate Base, 8 inch

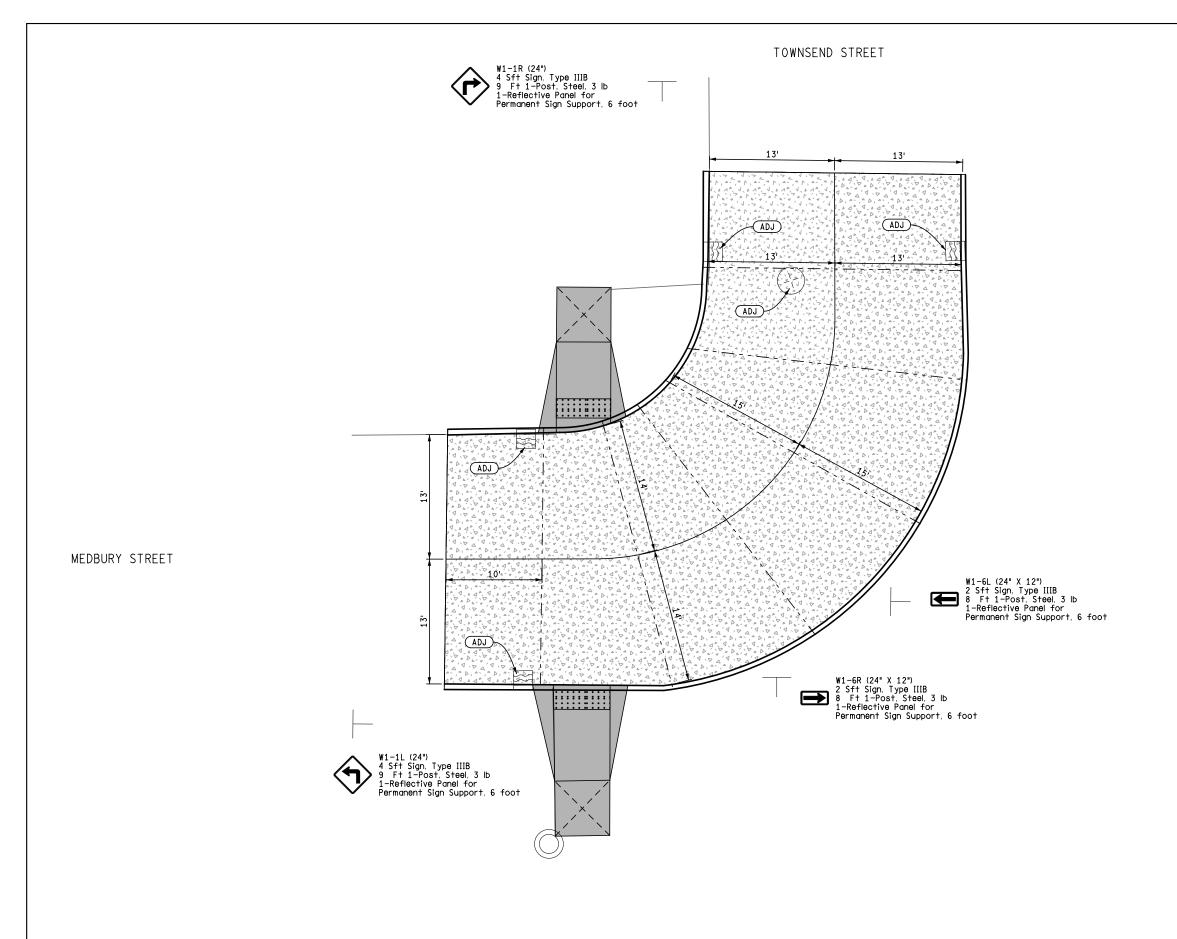52 174 Ft Joint, Expansion, E2
Ft Joint, Contraction, C3p

25 Ea Lane Tie, Epoxy Anchored

Ea F†

Ed Dr Structure Cover, Adj. Case 1. Modified Ft Post, Steel, 3 lb Sft Sign, Type IIIB


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NO.	DATE	AUTH	DESCRIPTION	NO.	DATE	AUTH	DESCRIPTION	Mannik
1								GROUP







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DRAWN BY:	DATE: 04/17/2020	CS:	CONSTRUCTION	DRAWING	SHEET
CHECKED BY:	DESIGN UNIT: DETROIT	JN: PW#7027	TOWNSEND AND MEDBURY INTERSECTION	CON	SECT 1
FILE: D1170223_RM003.dgn	TSC: WARREN			003	15



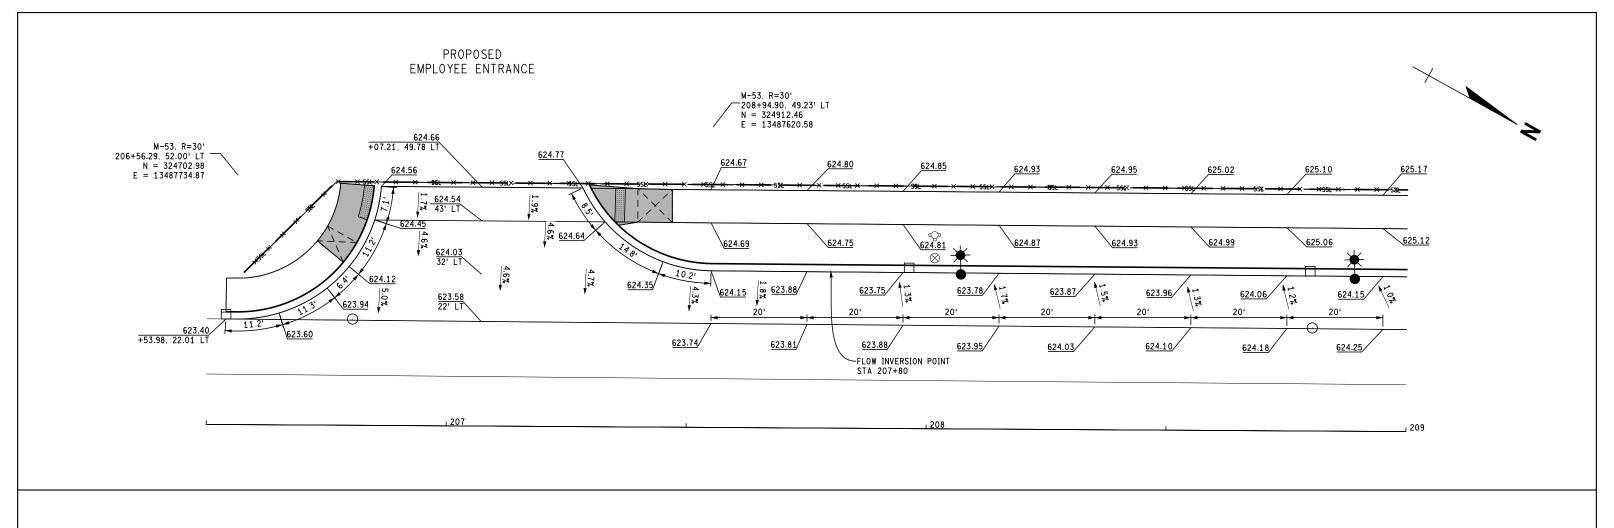


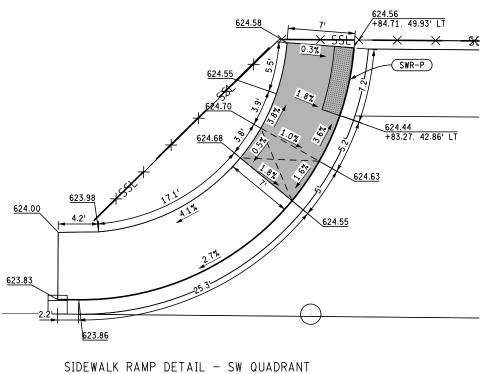
NOT TO SCALE

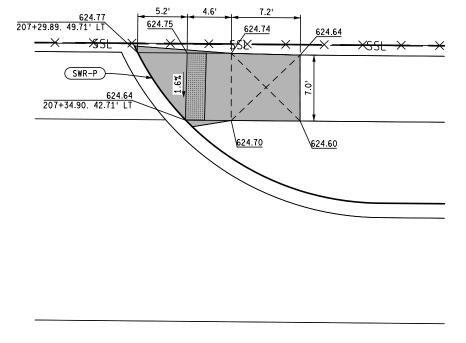


SIDEWALK RAMP DETAIL - NW QUADRANT NOT TO SCALE

FIN	AL ROW PLAN REVISIONS	(SUBMITTAL DATE:)	Mannik	~ **		DRAWN BY: ASH	DATE: 04/17/2020	CS:	DETAIL GRADES	DRAWING SHEET
NO. DATE AUTH	DESCRIPTION	NO. DATE AUTH	DESCRIPTION	Smith			CHECKED BY: DAR	DESIGN UNIT:	JN: PW#7027	M-53 STA 206+50 TO STA 209+00	M-53 SECT 1
				GROUP	City of Detroit	0 HORZ. (FT) 20	FILE: D1170223_DETG001	TSC:			001 16

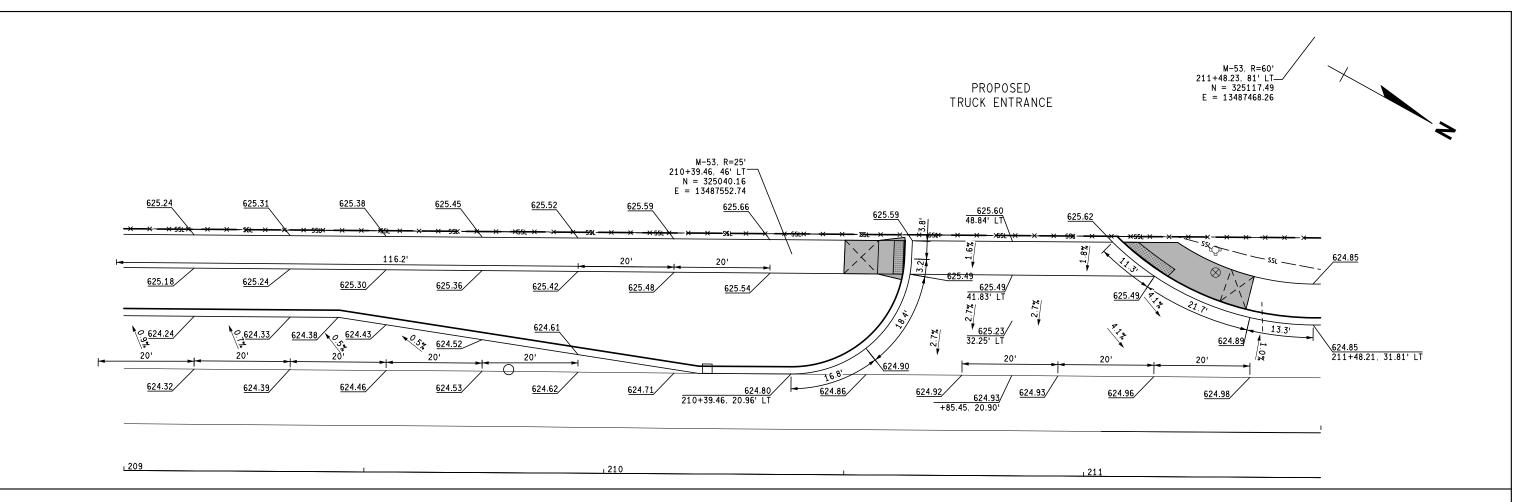

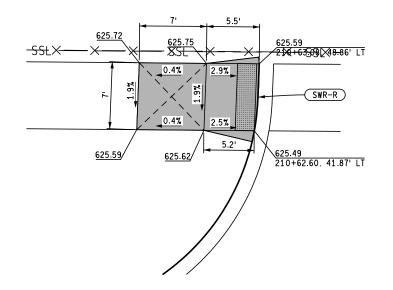


SIDEWALK RAMP DETAIL - SW QUADRANT
NOT TO SCALE

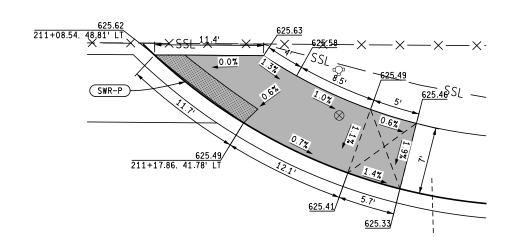

SIDEWALK RAMP DETAIL - NW QUADRANT
NOT TO SCALE


FINAL ROW PLAN REVISIONS (SUBMITTAL DATE:)	Mannik		DRAWN BY: ASH	DATE: 04/17/2020	CS:	DETAIL GRADES	DRAWING SHEET
NO. DATE AUTH DESCRIPTION NO. DATE AUTH DESCRIPTION	Mannik Smith GROUP		CHECKED BY: DAR	DESIGN UNIT:	JN: PW#7027	M-53 STA 209+00 TO STA 211+50	M-53 SECT 1
	GROUP City of Detroit	O HORZ. (FT) 20	FILE: D1170223_DETG002	TSC:			002 17

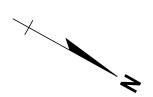

DRAWING SHEET

M-53 SECT 1

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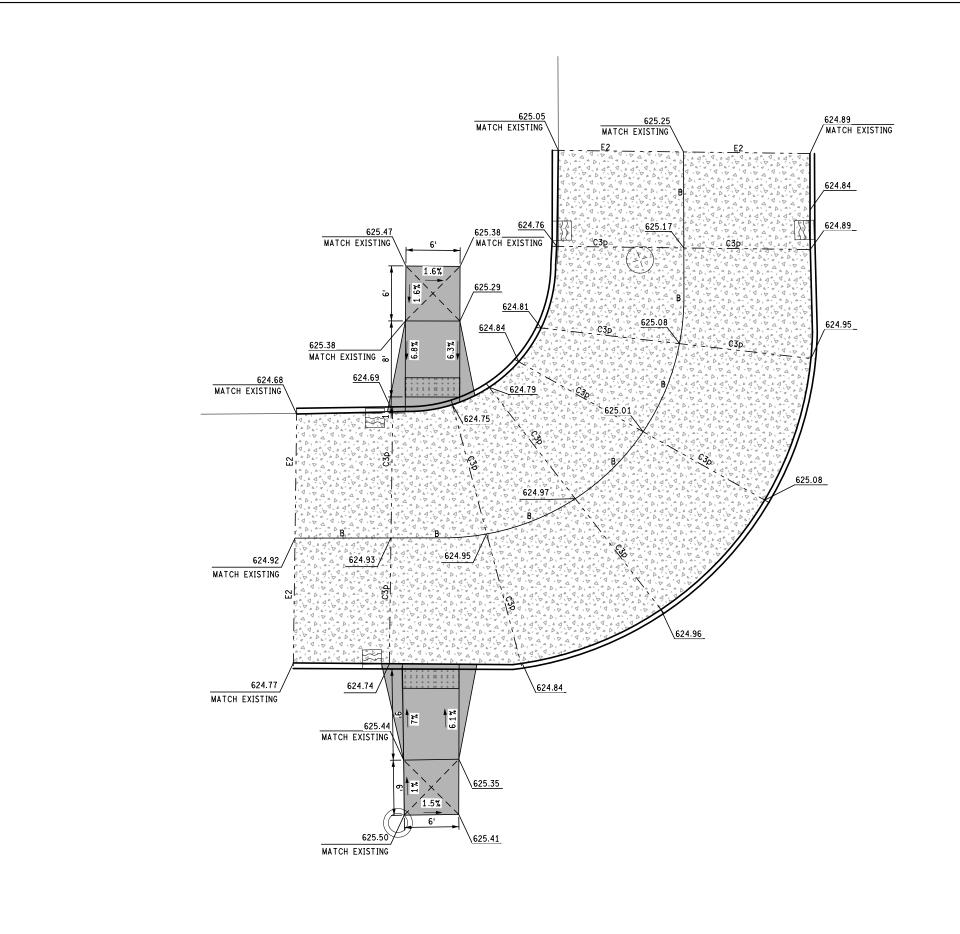
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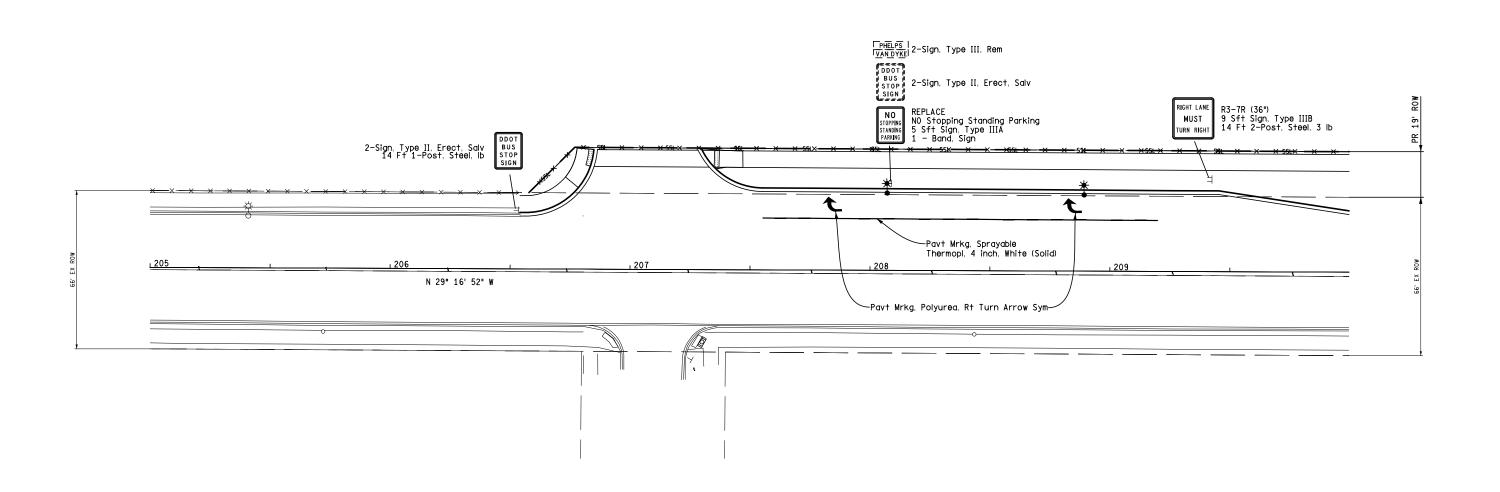
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DRAWN BY: ASH	DATE: 04/17/2020	CS:	DETAIL GRADES
CHECKED BY: DAR	DESIGN UNIT:	JN: PW#7027	M-53 STA 211+50 TO STA 214+00
FILE: D1170223_DETG003	TSC:		

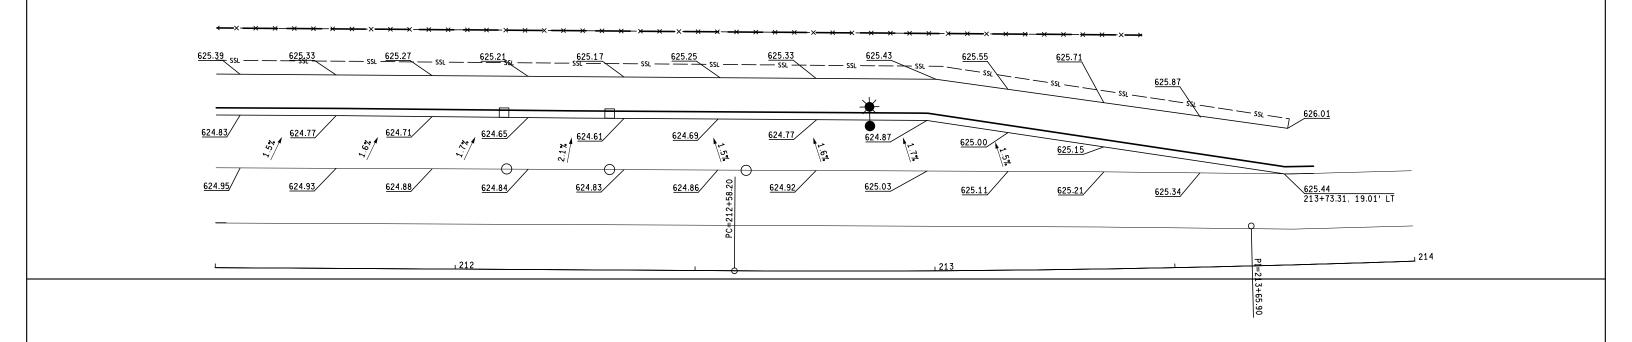

FINAL ROW PLAN REVISIONS (SUBMITTAL DATE:)		DRAWN BY: D.	DATE: 04/17/2020	CS:	DETAILED GRADES & JOINT PLAN	DRAWING	; SHEET
NO. DATE AUTH DESCRIPTION NO. DATE AUTH DESCRIPTION 1 DESCRIPTION GROUP		CHECKED BY: DI	DESIGN UNIT: DETROIT	JN: PW#7027	TOWNSEND AND MEDBURY INTERSECTION	DET	SECT 1
GROUP	O HORZ. (FT) 10	FILE: D1170223_DETG004.dgn T	SC: WARREN			004	19





PERMANENT PAVEMENT MARKING AND SIGNING QUANTITIES - THIS SHEET

Pavt Mrkg, Polyurea, Rt Turn Arrow Sym Pavt Mrkg, Sprayable Thermopl, 4 inch, White Post, Steel, 3 lb Sign, Type IIIB Sign, Type IIIA Band, Sign Sign, Type III, Rem Sign, Type III, Erect, Salv 2 Ea 165 F†

42 Ft 9 Sft 5 Sft 1 Ea 3 Ea 2 Ea

MEDBURY STREET

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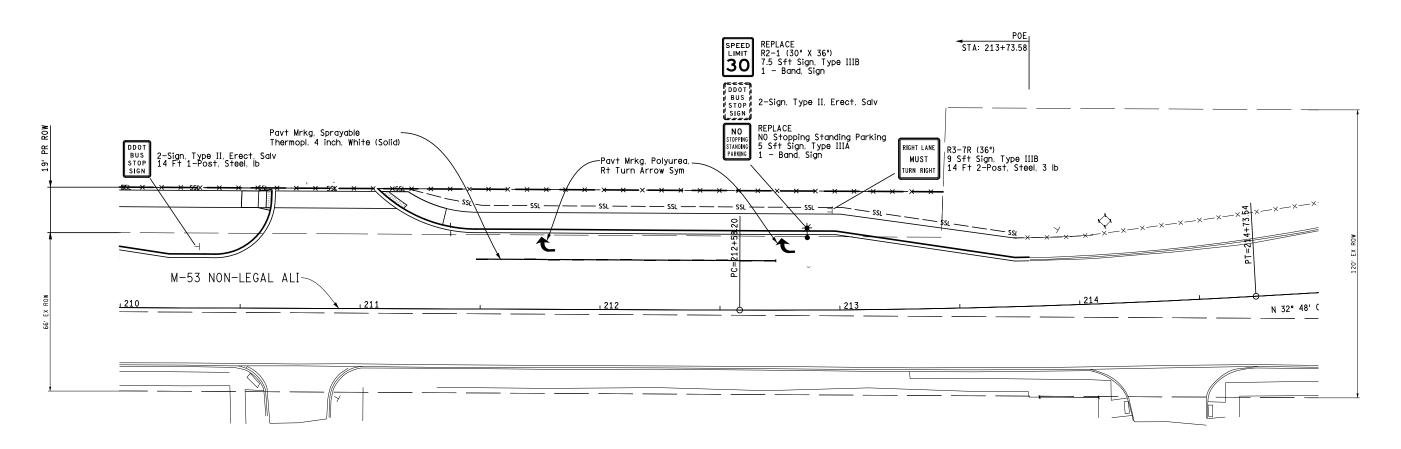
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	roit	0	HORZ. (FT)	4

DRAWN BY: ASH	DATE: 04/17/2020		
CHECKED BY: DAR	DESIGN UNIT:		
FILE: D1170223_PM001	TSC:		

CS:	
JN: PW#7027	

PERMANENT PAVEMENT MARKING AND SIGNING	DRAWING	SHEET
M-53 STA 205+00 TO STA 210+00	M-53 PM	SECT 1
	001	20





PERMANENT PAVEMENT MARKING AND SIGNING - THIS SHEET

125 Ft Pavt Mrkg, Sprayable Thermopl, 4 inch, White

16.5 Sft Sign, Type IIIB
42 Ft Post, Steel, 3 lb
2 Ea Pavt Mrkg, Polyurea, Rt Turn Arrow Sym
5 Sft Sign, Type IIIA
2 Ea Band, Sign
2 Ea Sign, Type III, Rem
2 Ea Sign, Type III, Erect, Salv

CONGER STREET

LAMBERT STREET

		FIN	IAL ROW PLAN REVISIONS	(205	SMILLAL	DATE:)
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d)	HORZ.	(FT)	40

DRAWN BY: ASH	DATE: 04/17/2020	CS:
CHECKED BY: DAR	DESIGN UNIT:	JN: PW#7027
FILE: D1170223_PM002	TSC:	

PERMANENT PAVEMENT MARKING AND SIGNING	DRAWING	SHEET
M-53 STA 210+00 TO STA 215+00	M-53 PM	SECT 1
	UU3	21