
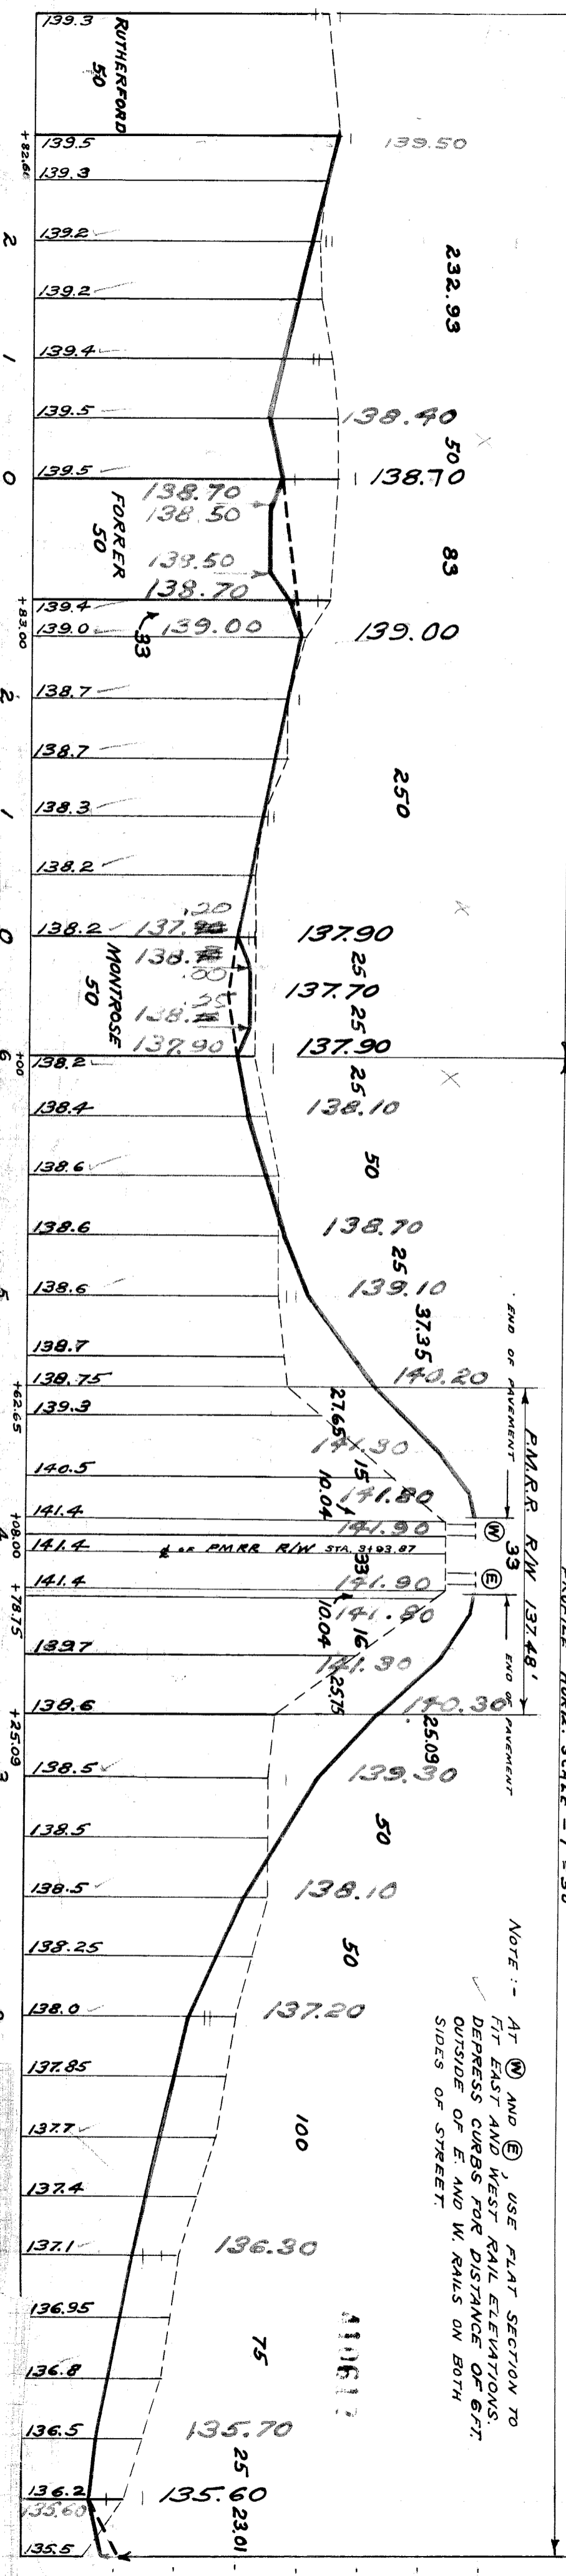
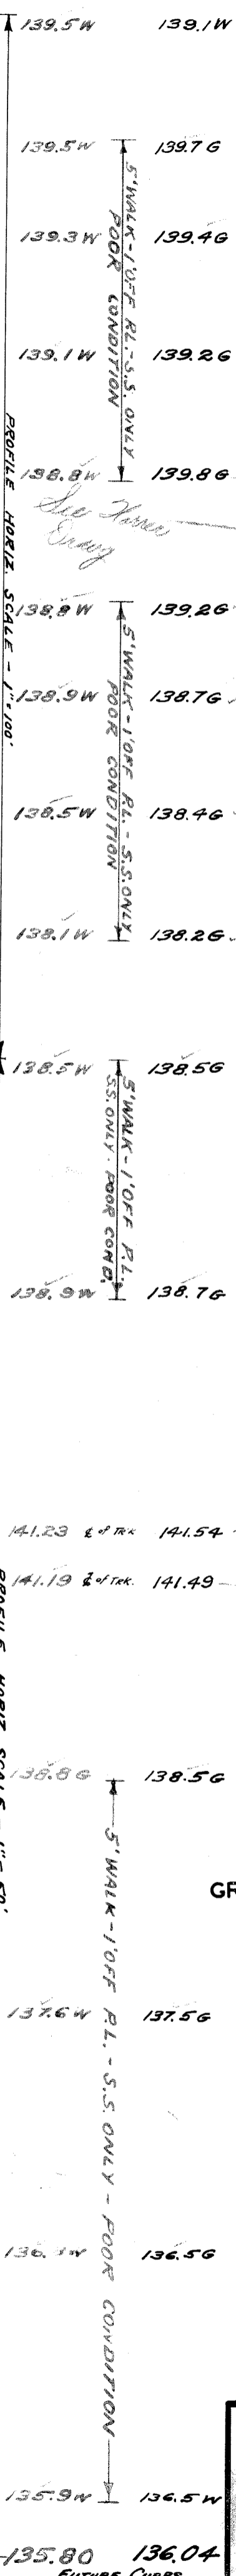


See Rutherford  
1-10-44

SEWER	OK 4/1/44	JOB NO.		QUANTITIES	LOTS	CITY	LOTS	CITY	CONDEMNATION OF NORTH HALF OF ST. PENDING 1-10-44	DESIGNED BY	J.P. HANOVER
INDEXED		BLUE PRINT ISSUED FOR:	DATE	EXCAVATION	2 516	439			VER. SCALE 1" = 2'	DRAWN BY	J.P. HANOVER
REVISIONS:	GAS MAIN ADDED 6-9-52	GRADE ONLY	START	STRAIGHT CURB NEW	2 350	12			PLAN	TRACED BY	
		CATCH BASINS	FINISH	OLD CURB RESET	-	-			CHECKED	CHECKED BY	
		PAVING-CLASS		CIRCULAR CURB	-	-			PROF. GRADE	CHECKED BY	
		DEPT. OF WATER SUPPLY		PAVING	5 223	236			PLAN	CHECKED BY	
		GAS CO.		CONCRETE BASE	-	845			CITY	CHECKED BY	
				M.H.'S - ADJUST	1	1			PROF. GRADE	CHECKED BY	
				BASINS - CONST.	3	4			CITY	CHECKED BY	
				Sewers 12" (11/4")	330	55			PROF. GRADE	CHECKED BY	

CARD NO.	40 99	INDEX	40	TORO	99
NAME OF STREET	W.P.L. OF RUTHERFORD	RECORD NO.			
FROM	E. OF W.P.L. OF GREENFIELD	TYPE OF PAVEMENT	8" ONE COURSE CONCRETE	WIDTH	40'
TO					
DEPARTMENT OF PUBLIC WORKS					
CITY ENGINEER'S OFFICE - DIVISION OF PAVING DESIGN					
STREET PAVING PLAN					
TIREMAN					
AP-3-1					
NUMBER OF SHEETS	1				
SHEET NO.	1				

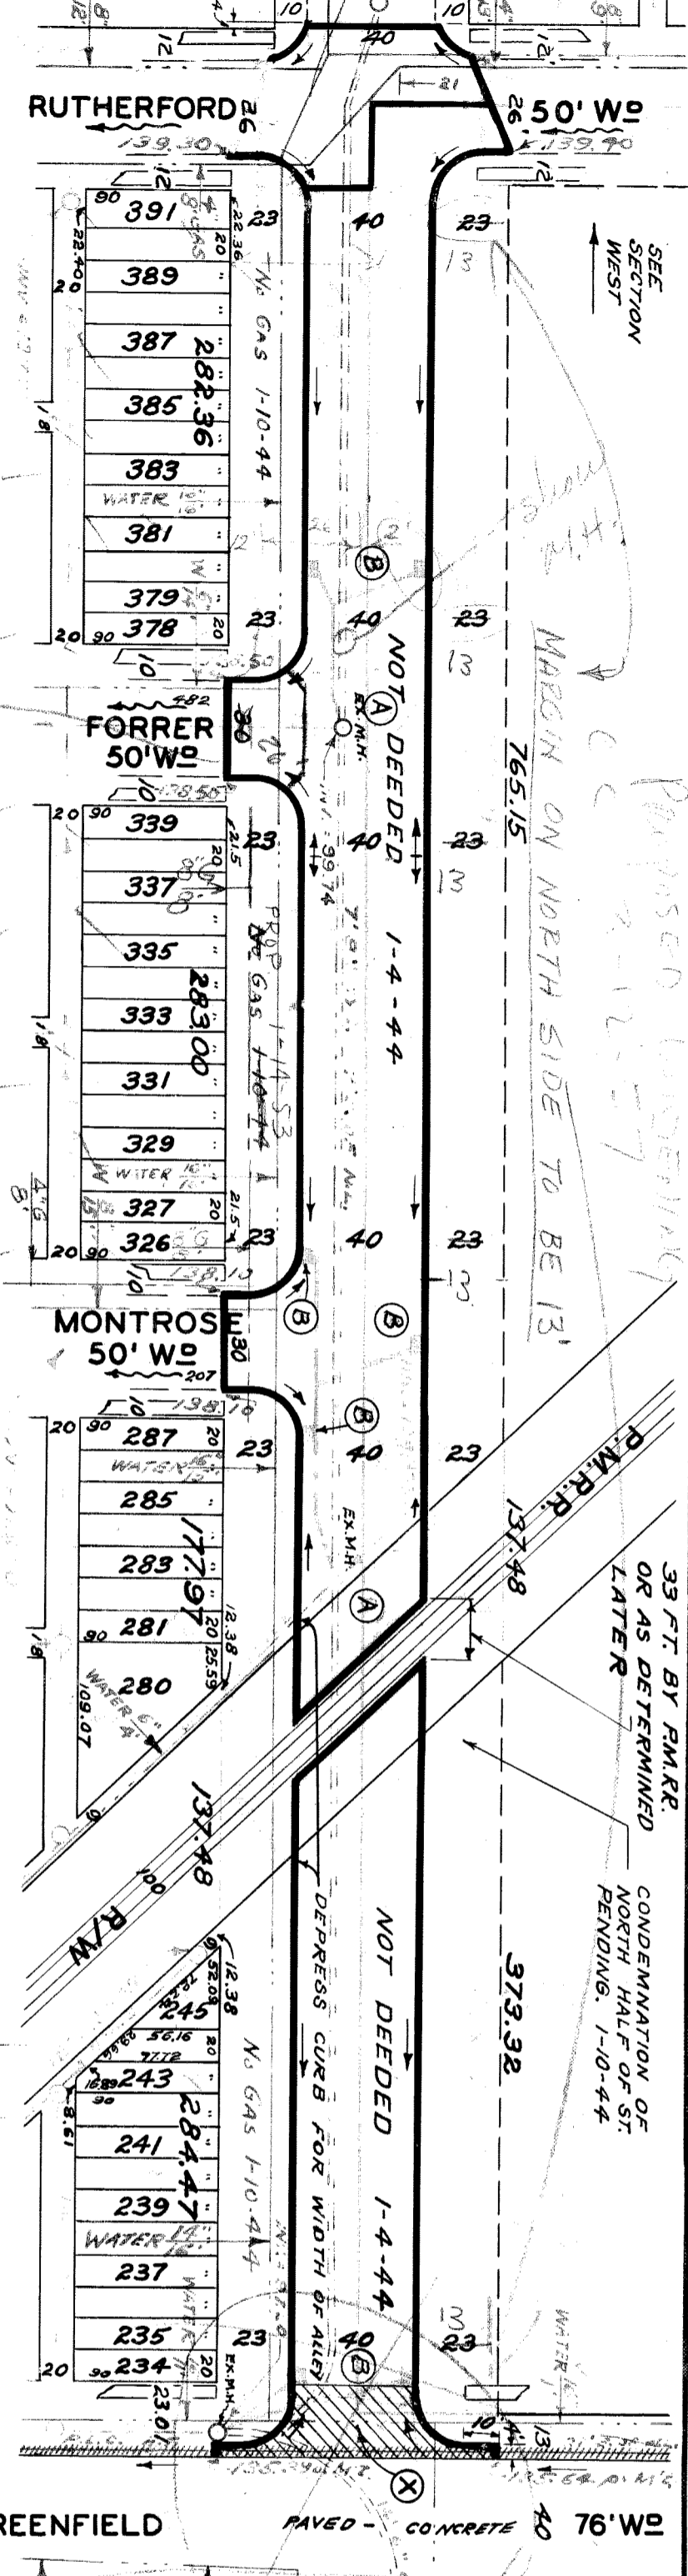

NOTE: - AT (A) ADJUST TOPS OF 2 EXISTING MANHOLES.  
 AT (B) CONSTRUCT 7 STD 18"x12" Y. BASINS COMP. AND CONNECT TO EXISTING SEWER MANHOLES WITH 12" PIPE, AS SHOWN.  
 AT (X) CONSTRUCT RETURNS WITH 4 FT. WIDENING. (SEE STD. DETAIL SHEET #C-371). CONCRETE SLAB IN GREENFIELD TO BE 10" THICK.  
 PLAN SCALE DISTORTED  
 CONTRACTOR MUST CHECK WITH UTILITIES BEFORE BEGINNING CONSTRUCTION, ON LOCATION OF EXISTING MANHOLES, WHETHER SHOWN ON PLANS OR NOT.  
 DRAINAGE COMPLETED  
 PAVING COMPLETED  
 WEEK 1946 PROGRAM

NOTE: - AT (W) AND (E) USE PLAT SECTION TO FIT EAST AND WEST RAIL ELEVATIONS. DEPRESS CURBS FOR DISTANCE OF 6 FT. OUTSIDE OF E. AND W. RAILS ON BOTH SIDES OF STREET.