
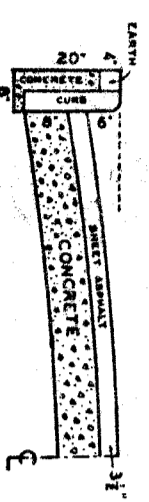


CROSS SECTIONS

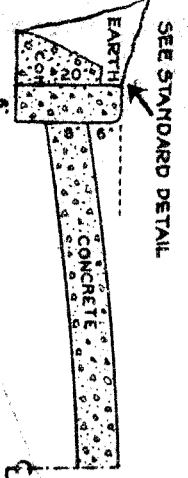

AT NO.	V.	RADIUS	TANG.	ARC	S.E.G.	QUANTITIES		LOTS	CITY	LOTS	CITY
						EXCAVATION	STRAIGHT CURB NEW				

DEPARTMENT OF PUBLIC WORKS
 CITY ENGINEERS OFFICE ... DIVISION OF PAVING DESIGN
STREET PAVING PLAN
PLAINVIEW 80
OUTER DRIVE
FENKELL



BOOK SCALE 1"=21' DATE 2-11-37
 PLAN C.L.W. PROFILE HBM. COMPUTED CHECKED 1/6
 CHECKED 1/6
 CITY 2. 26 LENGTH 13
 TOTAL 2. 1/759.65 LENGTH 879.83 CITY

INDEX TOTAL NO. 76 112


RECORD NO. FROM FENKELL TO FENKELL

TYPE OF PAVEMENT WITH

NUMBER OF SHEETS 1
 SHEET NO. 1

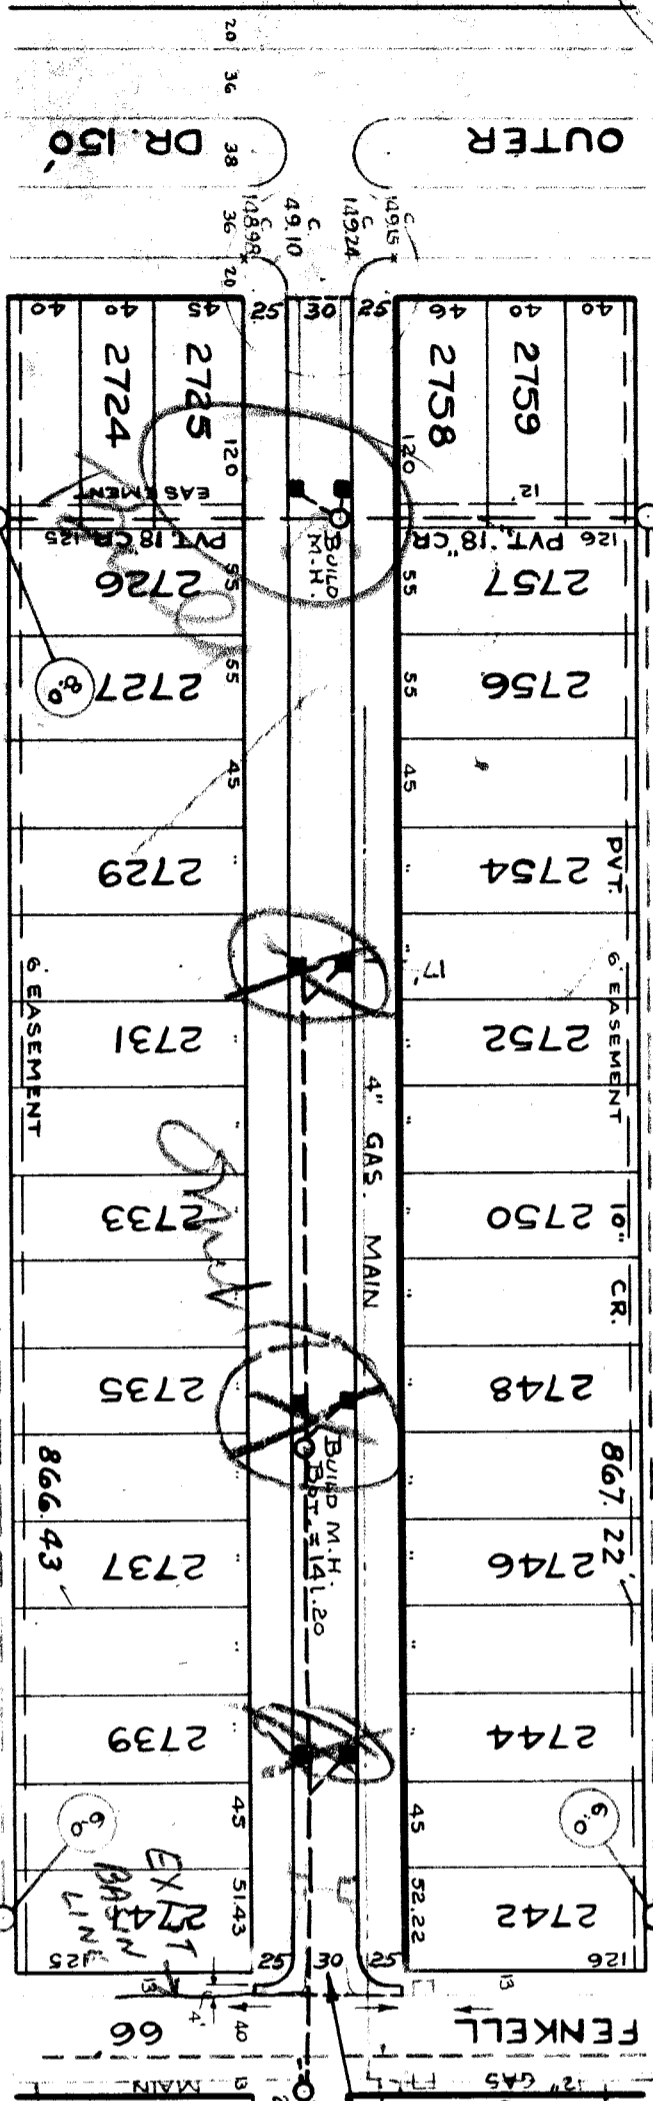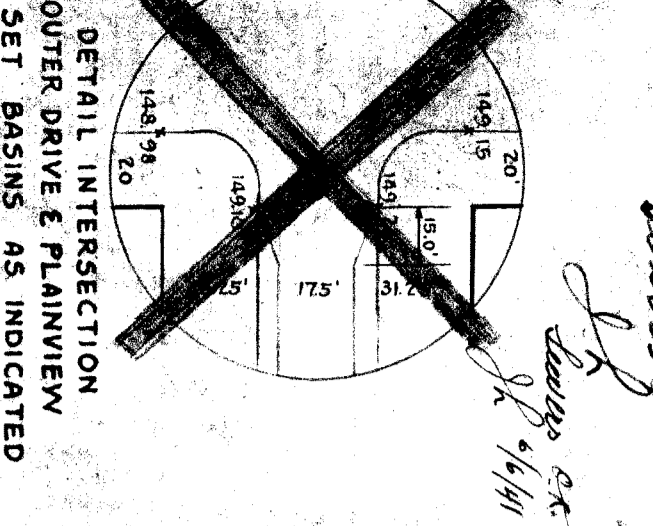

STATION	MARK	ALTIMETER	MARK	ALTIMETER
149.04	WKS.	149.14		
149.12	WKS.	149.22		
149.42	DR.	149.32		
149.62	WKS.	149.62		
149.62	WKS.	149.62		
149.62	WKS.	149.82		
149.62	DR.	149.82		
149.92	WKS.	149.92		
150.02	WKS.	150.02		
150.12	WKS.	150.12		
149.53	PAV.	149.62		
149.83	FUTURE CURB	149.92		

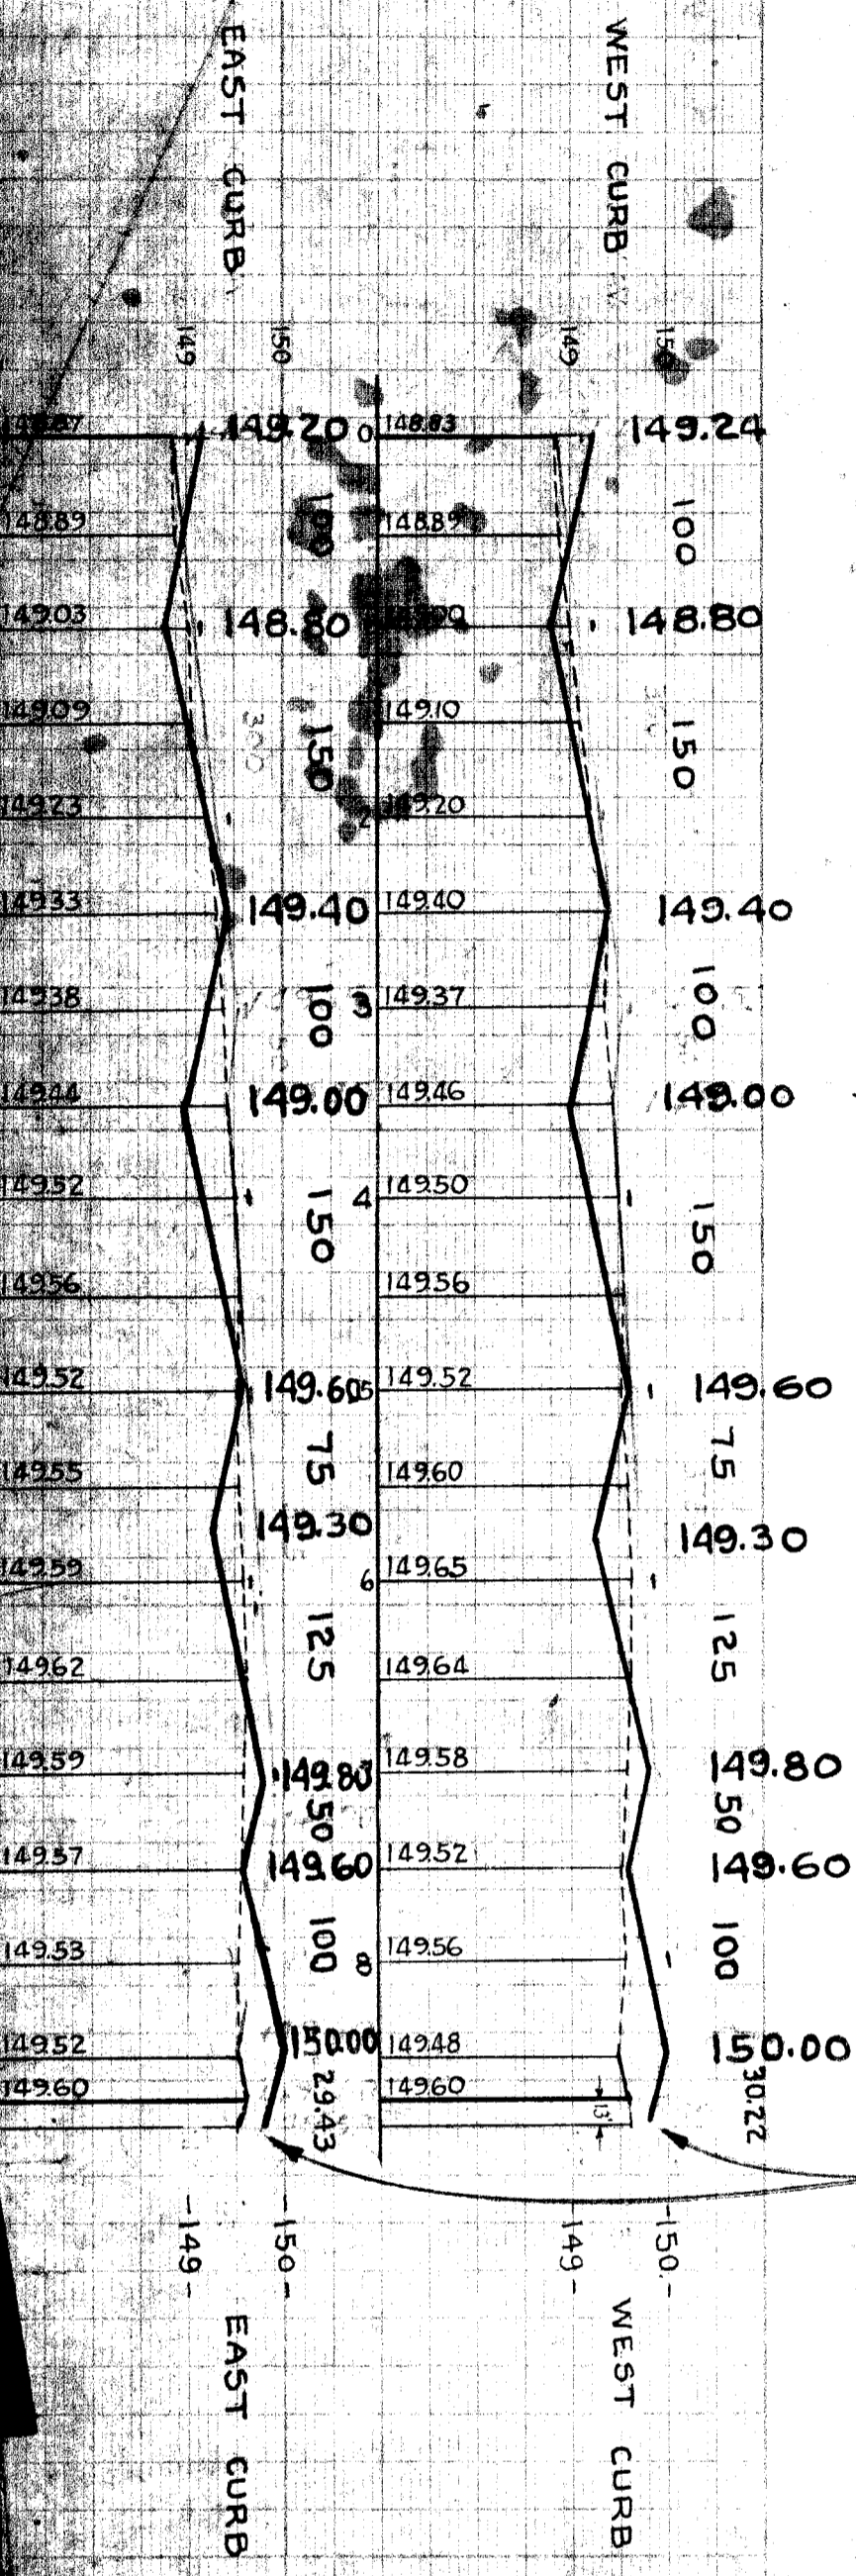

CONTRACTOR MUST CHECK WITH UTILITIES, RE: DEPTH OF EXISTING UTILITIES, AND WHETHER THERE ARE OTHER STRUCTURES, WHETHER SETBACK OR PLANS OR NOT.

BENCH MARKS
 SPIKE IN E. SIDE OF 36" ELM. 40' W. OF EVERGREEN & 25' S. OUTER DRIVE 149.944
 HYD. ARR. N.E. COR. PLAINVIEW & OUTER DRIVE 151.68
 HYD. ARR. S.E. COR. FENKELL & PLAINVIEW 152.60

NEW EXISTING POOLS & BASINS



DESIGNED BY
 DRAWN BY
 CHECKED BY
 APPROVED
Walter R. Anderson
 CIVIL CITY ENGINEER

JOB-NO. D-2128

DRAINAGE ONLY