

REVISIONS	4-20-48	CHANGED ALLEY CURB RADIIUS
REVISIONS		BEHM
SUPPLEMENTAL DIMENSIONS		
C-324A	C-327	C-328
C-325	C-326	C-329
C-328A	C-328B	C-329A
C-327	C-328	C-329B




NOTE:
 BEFORE STARTING CONSTRUCTION CONTRACTOR MUST CHECK WITH UTILITIES FOR LOCATIONS OF EXISTING STRUCTURES WHETHER OR NOT INDICATED ON PLANS.
 PLAN SCALE: 1" = 50'
 LOTS & ALLEYS: 1" = 50'
 STREET WIDTHS: 1" = 50'
 DRAINAGE COMPLETED 7-20-48
 PAVING COMPLETED C.C. 7-20-48

QUANTITIES	ESTIMATED	FINAL
EXCAVATION CU YDS	282	282
NEW CURB LIN FT	61	61
PAVING 8-6-8 SQ YDS	106	106
50-00 WALK SQ FT	216	216
MANHOLES ADJUST	2	2
CONSTRUCT	1	1
SEWER 12" LIN FT	3	3
SEWER 18" LIN FT	150	150

MOB SCALE	1" = 50'	1999	23
DATE	1-13-46		
DATE	9-29-47		
DATE	P.M.		
DATE	5.5		
DATE	465.93		
DATE	36.00		
DATE	501.93		
DATE	11.65		
DATE	58.24		
DATE	4.50		
DATE	90		
DATE	232.97		
DATE	18.00		
DATE	250.97		

DESIGNED BY: SAM ASMITH
 DRAWN BY: H B LO FRANCE
 CHECKED BY: S.A.S. - ROBERT R. BOON
 APPROVED BY: *S.K. Bunker*
 ENGINEER OF STREETS
Martin R. Trahan
 ASSIST. CITY ENGINEER

DEPARTMENT OF PUBLIC WORKS
 CITY ENGINEERS OFFICE - DIVISION OF PAVING DESIGN
 STREET PAVING PLAN
 HARRY
 E.P.L. MC CLELLAN
 25097' E. OF E.P.L. MC CLELLAN
 8: 6: 8
 Alfred Goebel et al
 Forced Paving CCR 7-29-47
 10-29-46
 236-11
 3456
 25 57
 26428'

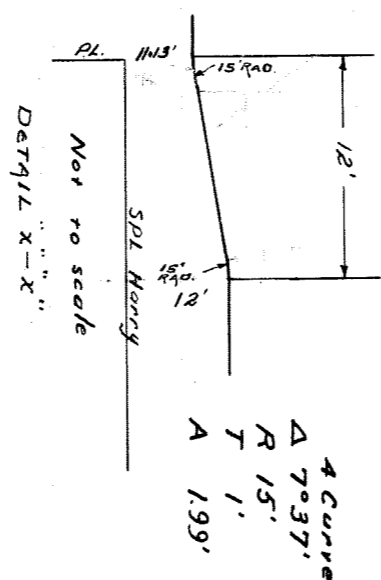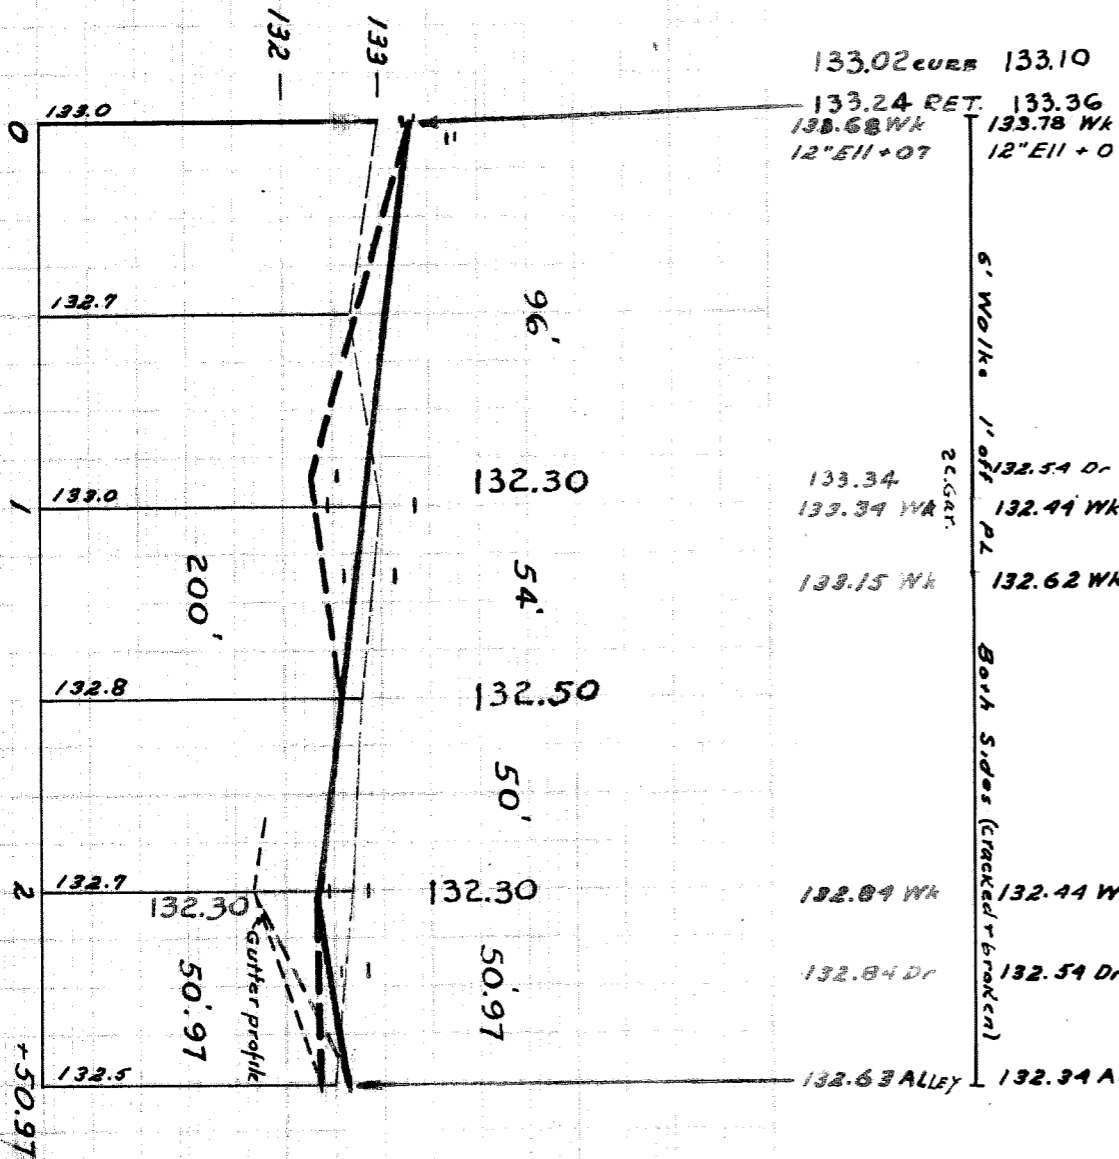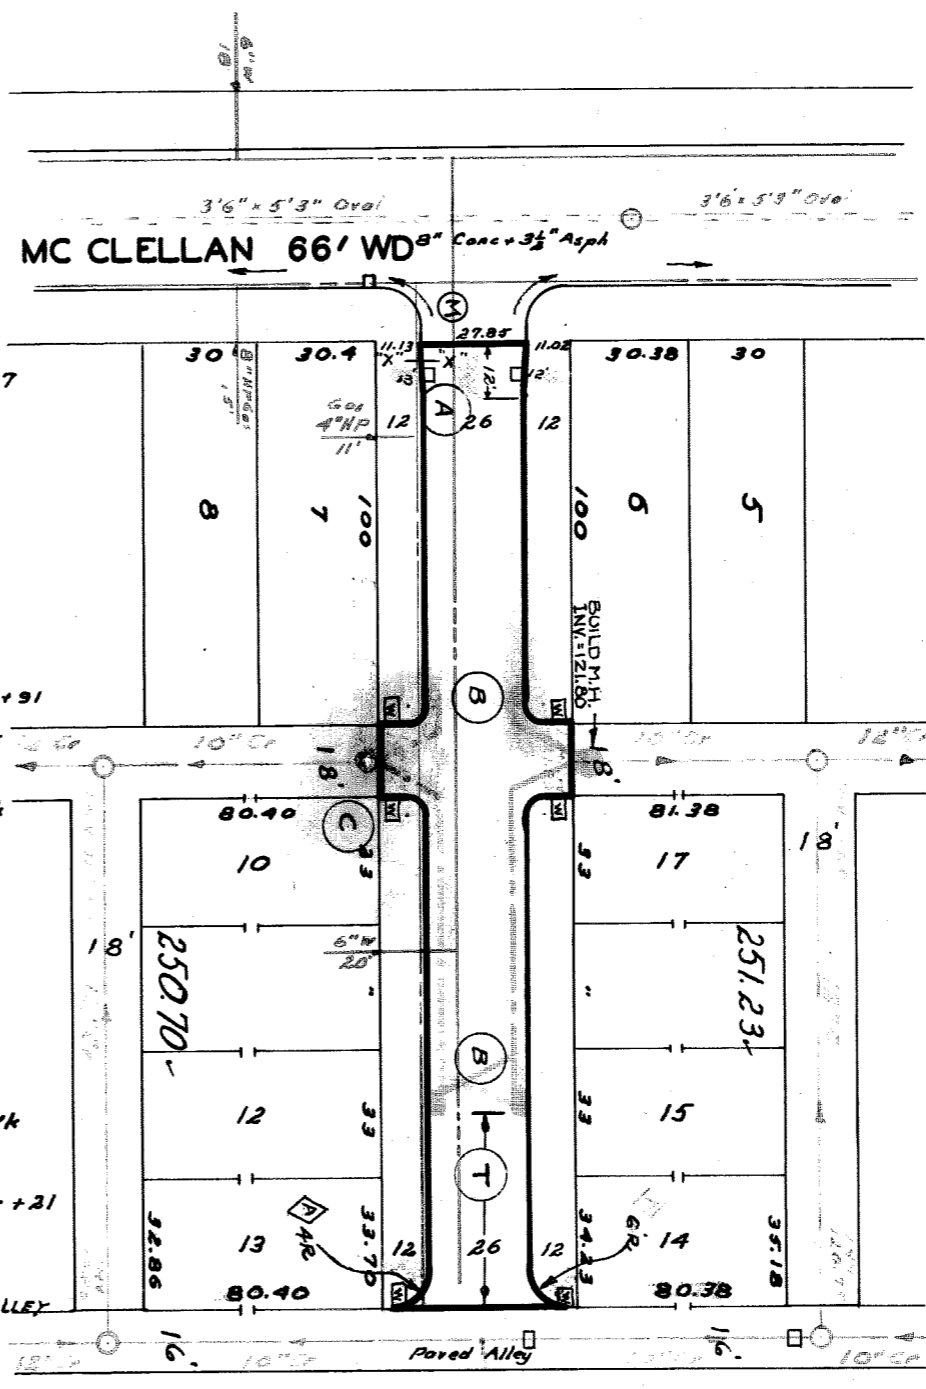

BENCH MARKS
 PLBM 51-250 A NW Cor McClellan & Corney 133.327
 Arrow hyd SE Cor McClellan & Harry 136.33

- Notes
- (A) REMOVE 2 EXISTING 12" BASINS, PUG OUTLETS & FILL BASINS WITH CLASS "C" CONCRETE.
 - (B) CONSTRUCT 3 STD. 18" 1/2" Y-BASINS AND CONNECT AS SHOWN.
 - (C) CONSTRUCT 1 STD. MANHOLE COMPLETE FROM STANDARD CROWN TO FLAT SECTION IN 50.97 FT.
 - (T) CONSTRUCT 216 SQ. FT. OF STD. 4" WALK.
 - (W) CONTRACTOR SHALL REMOVE CONC. HEADER & BROKEN ASPHALT BACK OF JUNCTION AS REQUIRED. FILL WITH GOLD PATCH TO MEET NEW GRADE & INCLUDE COST IN EXCAVATION TOTALS. ADJUST TOPS OF 2 SEWER OR WATER MANHOLES.
- CONTRACTOR SHALL HAUL ALL OLD CASTINGS TO D.R.W. YARD AT STATE FAIR & JOHN R. BACKFILL SEWER PIPE TRENCH WITH APPROVED SAND GRAVEL MATERIAL. CONTRACTOR SHALL FURNISH AND INSTALL STD. FLAT TYPE CATCH BASIN FRAMES & GRATES.

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