

STREET PAVING PLAN
GREYDALE

A. O. 7944
A.P. 196-15
72 114

NAME OF STREET: N. P. L. OF CLARITA
FROM: 462 N. OF N. P. L. OF CLARITA
TO: 5'-6'-6" ONE COURSE CONCRETE INTERIOR CURB

APPLICATION 248-54 2-10-48



BENCH MARKS ELEV.

P.L. B.M. NO 114-251 N.E. COR. CURTIS & LAHSER 158.32 ✓
B.M. SPIKE IN N.S. OF POLE S.S. OF CLARITA & 25' 159.68 ✓
W. OF W. LINE OF GREYDALE 156.18 ✓
B.M. SPIKE IN S.W. SIDE OF 48' OAK TREE 25' E. OF
E. LINE OF GREYDALE & 463 N. OF CLARITA

NOTES:
✓ AT (A) CONSTRUCT 2 STANDARD 10"x12" Y BASINS COMPLETE
AND CONNECT AS SHOWN
✓ AT (B) CONSTRUCT 1 STANDARD MANHOLE COMPLETE.

DESIGNED BY	R. E. E.
DRAWN BY	T. KANDOV
TRACED BY	T. K.
CHECKED BY	Room
APPROVED	<i>(Signature)</i>

DATE	1948	PROJECT	CLARITA
SCALE	1" = 100'	CHECKED	5.5
CITY	DETROIT	PROJECT	923-851
YEAR	4	LENGTH	461 92'
COST ESTIMATING		CHECKED	
COST INSPECTION		CHECKED	


NO. SCALE	1" = 100'	BOOK	1519	PAGE	57-58
DATE	MAY 16, 1948				
PLAN	T.K.				
CHECKED	5.5				
DATE	MAY 16, 1948				
CITY	DETROIT				
YEAR	4				
COST ESTIMATING					
COST INSPECTION					

QUANTITIES	ESTIMATED	FINAL
EXCAVATION	367 ✓	
NEW CURB	1 386 ✓	
PAVING		
SEWER		
MANHOLE		
ADJUST		
CONSTRUCTION	320 ✓	
SEWER		
CONSTRUCTION		
SWER		
CONSTRUCTION		


NOTE:
BEFORE STARTING CONSTRUCTION CONTRACTOR
MUST CHECK WITH UTILITIES FOR LOCATIONS OF
EXISTING STRUCTURES WHETHER OR NOT HUD-
DATED ON PLANS

PLAN SCALE DISTORTED
LOTS & ALLEYS 1" = 100'
STREET WIDTHS 1" = 50'
DRAINAGE COMPLETED
PAVING COMPLETED

SEWER	OK
REVISIONS	
SUPPLEMENTARY DETAILS	
DRAWING NO.	

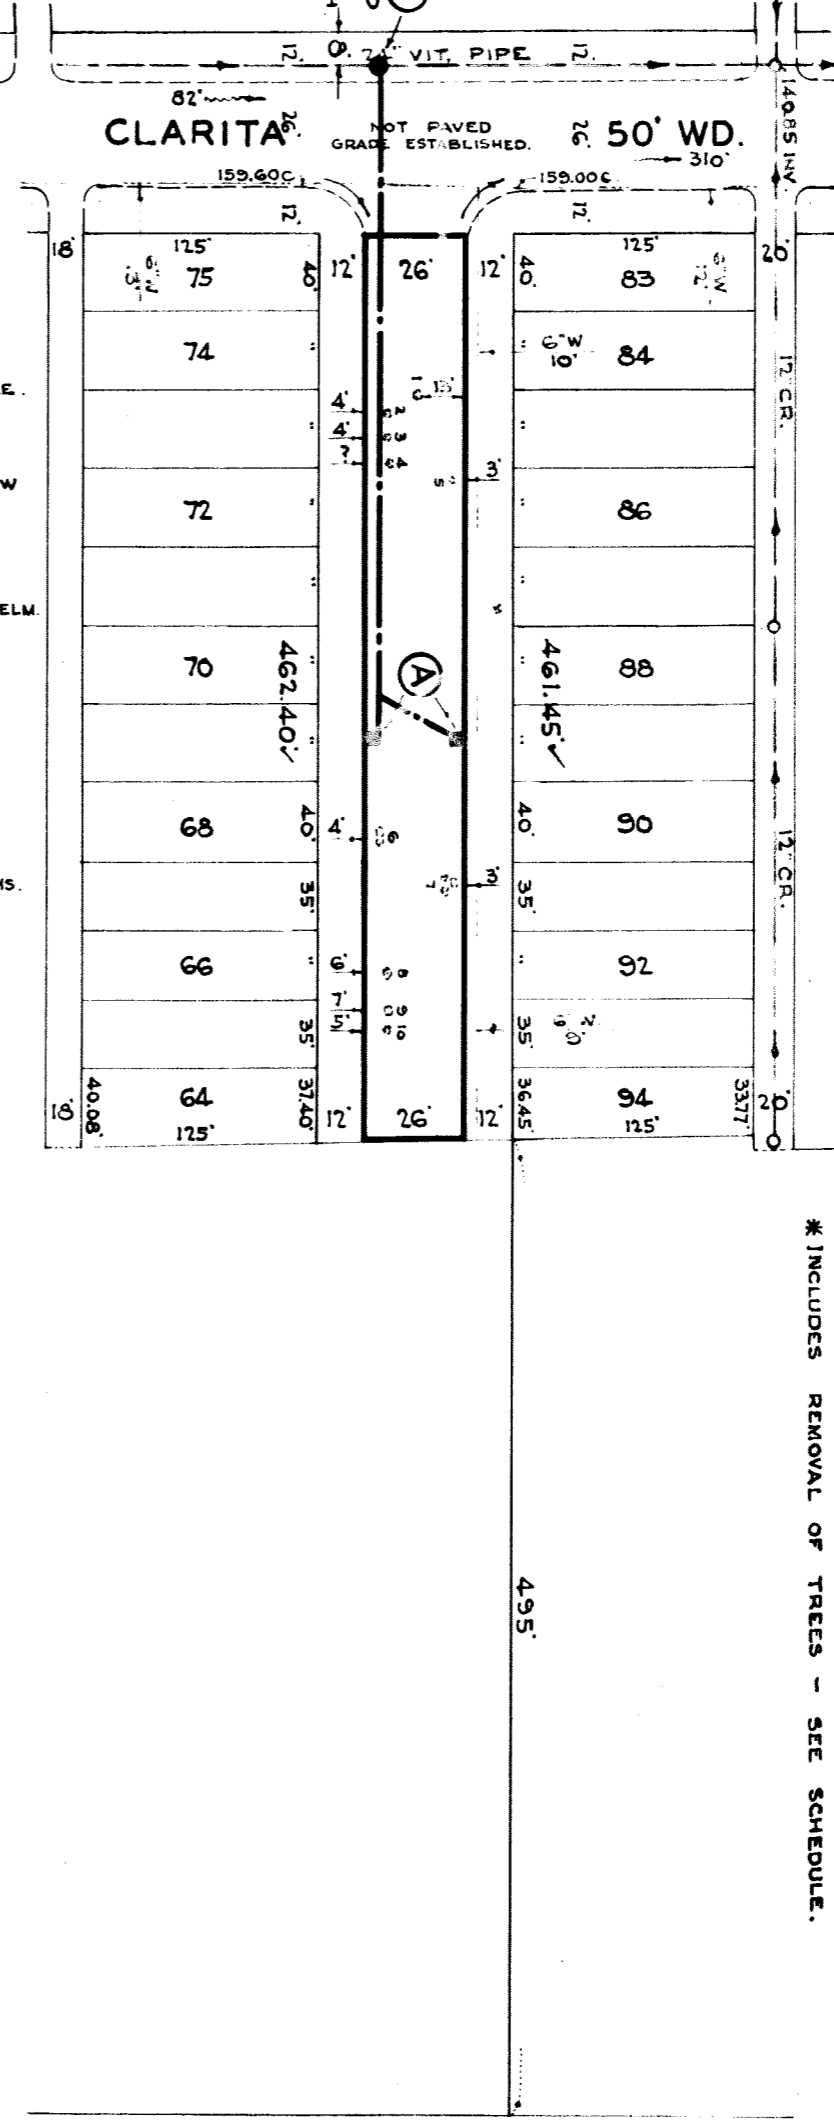

158.8 GR.	0+80 - 8' MAPLE.
158.9 GR.	156.4 GR.
158.0 GR.	1+21 - 5' WILLOW
158.3 GR.	1+87 - TWIN 6' ELM.
155.3 GR.	155.2 GR.
154.7 GR.	3+15 - 3-3' ELM.
154.3 GR.	154.3 GR.
153.7 GR.	153.7 GR.

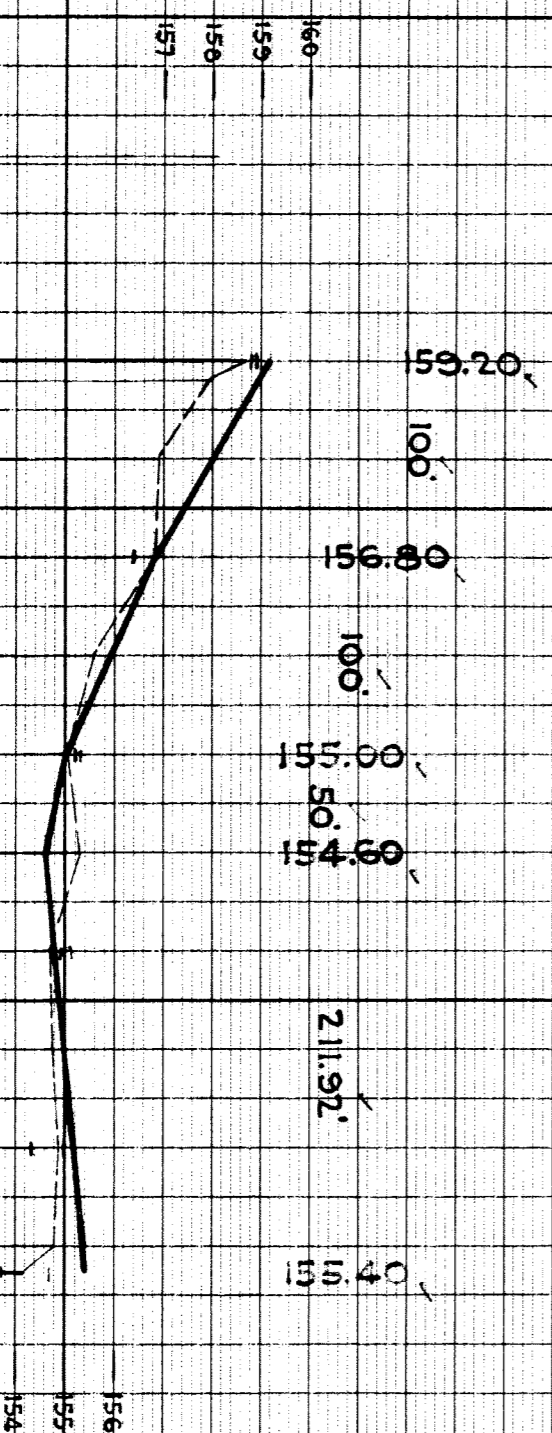

NOTE:
FOR TREE REMOVAL SEE
TREE REMOVAL SCHEDULE.

SEVEN MILE 66' WD.

TREE NUMBER	KIND OF TREE	SIZE
1	MAPLE	8"
2	OAK	6"
3	CHERRY	6"
4	TWIN MAPLES	6"
5	WILLOW	5"
6	CLUMP OF ELM	1"
7	3 ELM	3"
8	ELM	4"
9	ELM	3"
10	ELM	3"