


NOTE FOR BIDDERS
 Drawings of existing Korte Ave Arch Bridge are on file in the office of the City Engineer and may be inspected by prospective bidders.

Profile on E of Bridge
 Curb Grades shown

SHEET — OF — SHEETS		JOB NO.		DRWG NO.	
DATE		SCALE		BOOK NO.	
CITY OF DETROIT		DEPARTMENT OF PUBLIC WORKS		CITY ENGINEERS OFFICE	
DESIGNED BY	APPROVED:	DESIGNED BY	APPROVED:	DESIGNED BY	APPROVED:
DRAWN BY		DRAWN BY		DRAWN BY	
TRACED BY		TRACED BY		TRACED BY	
CHECKED BY		CHECKED BY		CHECKED BY	
DATE		DATE		DATE	
DESCRIPTION		DESCRIPTION		DESCRIPTION	
REVISIONS		REVISIONS		REVISIONS	


1926
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3/17/11/11/11

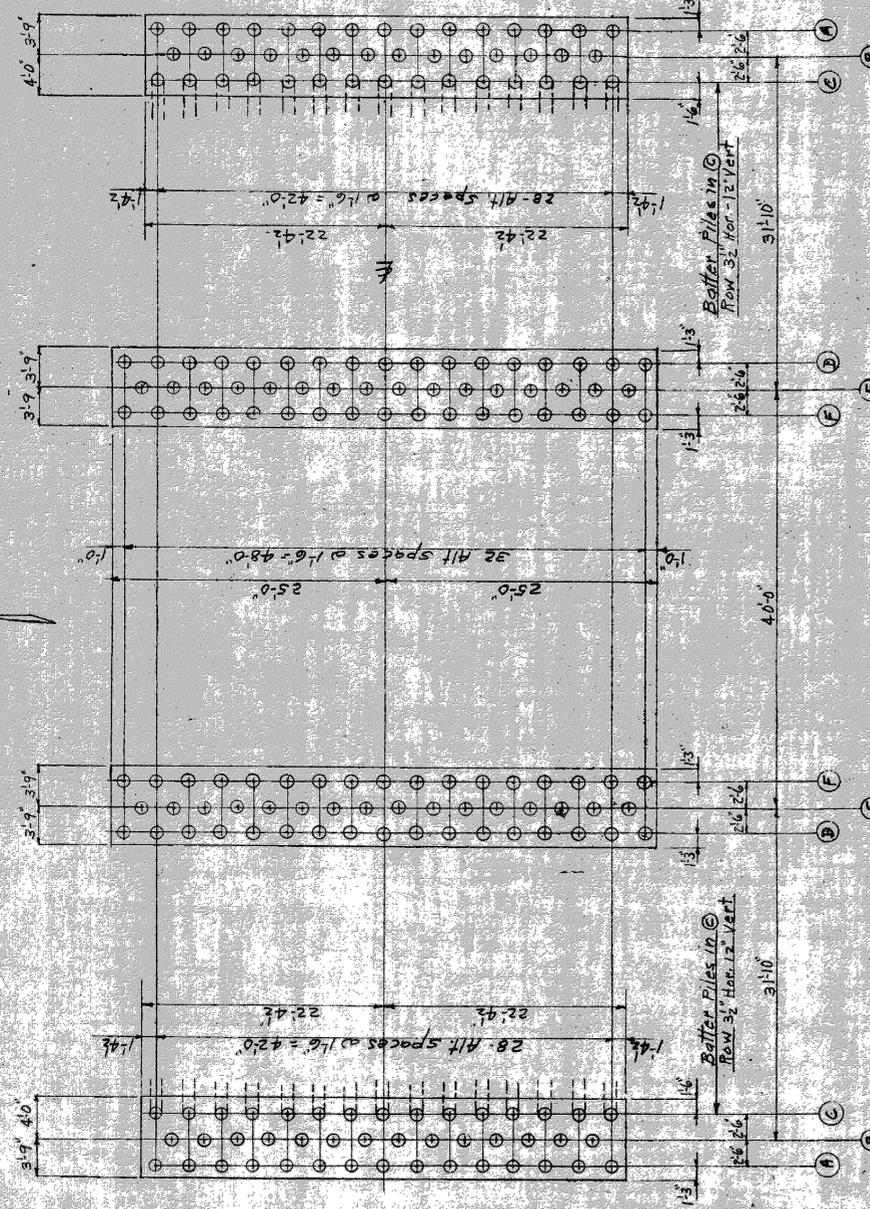


Foundation & Pile Plan
Scale 1/8" = 1'-0"

Note: Tops of Finished Piles El. 78.8 (Corkoff)
 Piles for Wing Walls not shown see DWG. ST 248
 All piles in Bridge Foundations shall be driven to
 safely sustain a load of 30 tons each.

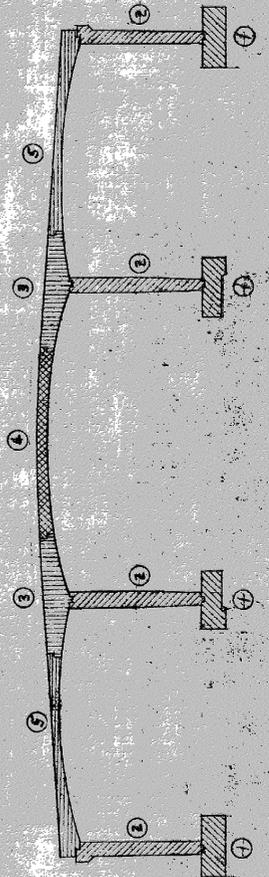


Concrete Placing Schedule
Order of Placement as follows:


- 1st Operation
- 2nd "
- 3rd "
- 4th "
- 5th "

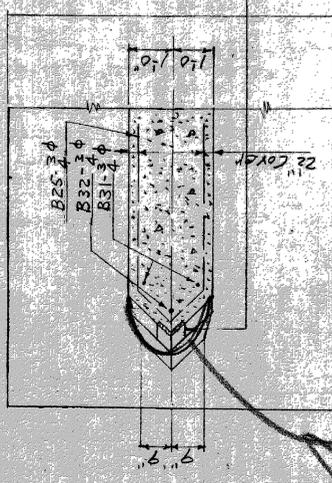


Plan Sect. E-E

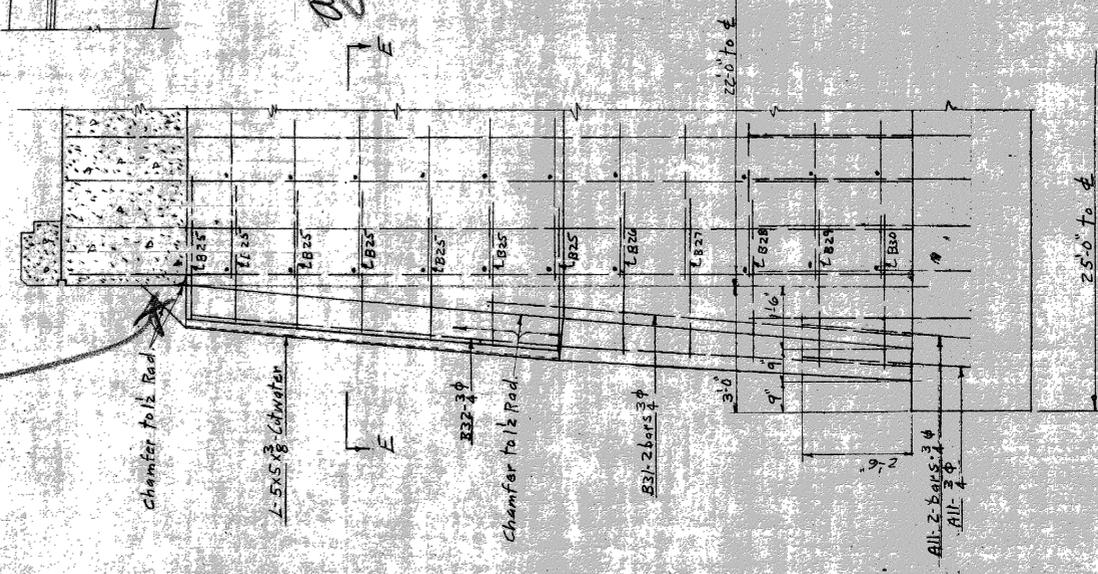

Sect. D-D

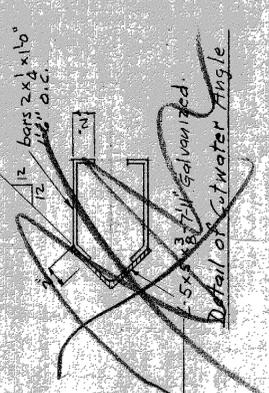


Detail of Cutwater Angle

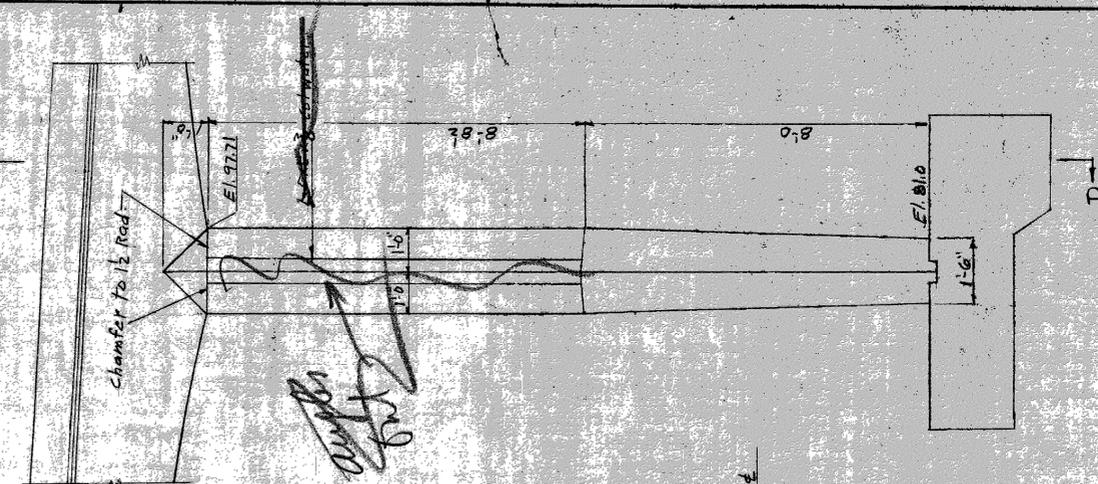


Detail of Cutwater At Interior Pier Ends

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DESCRIPTION		REVISIONS		DATE		BY		BY		BY	
CITY OF DETROIT DEPARTMENT OF PUBLIC WORKS CITY ENGINEERS OFFICE											
SHEET 1 OF 1 SHEETS JOB NO. 10/20/15 DRAWING NO. 872											
FOUNDATION PLAN - PIER DETAIL III PREPARED BY: [Signature] DATE: 10/20/15											

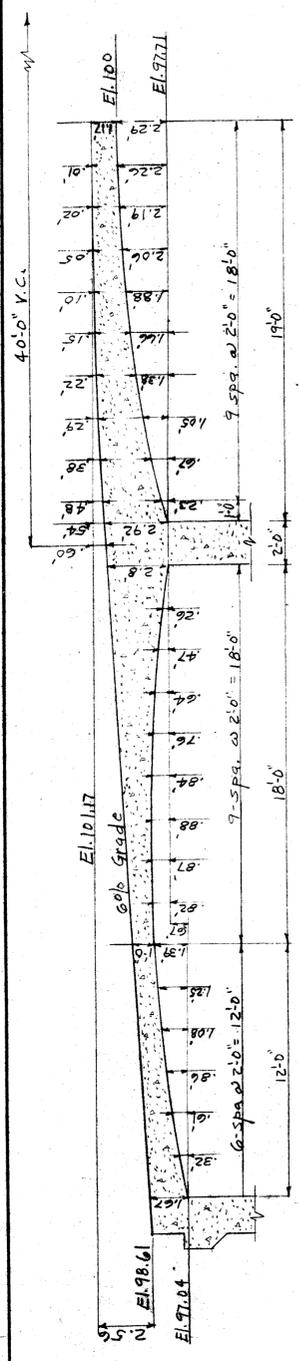


Half Longitudinal Section on Roadway Center Line
Showing Soffit and Grade Elevations
Scale 1/4" = 1'-0"

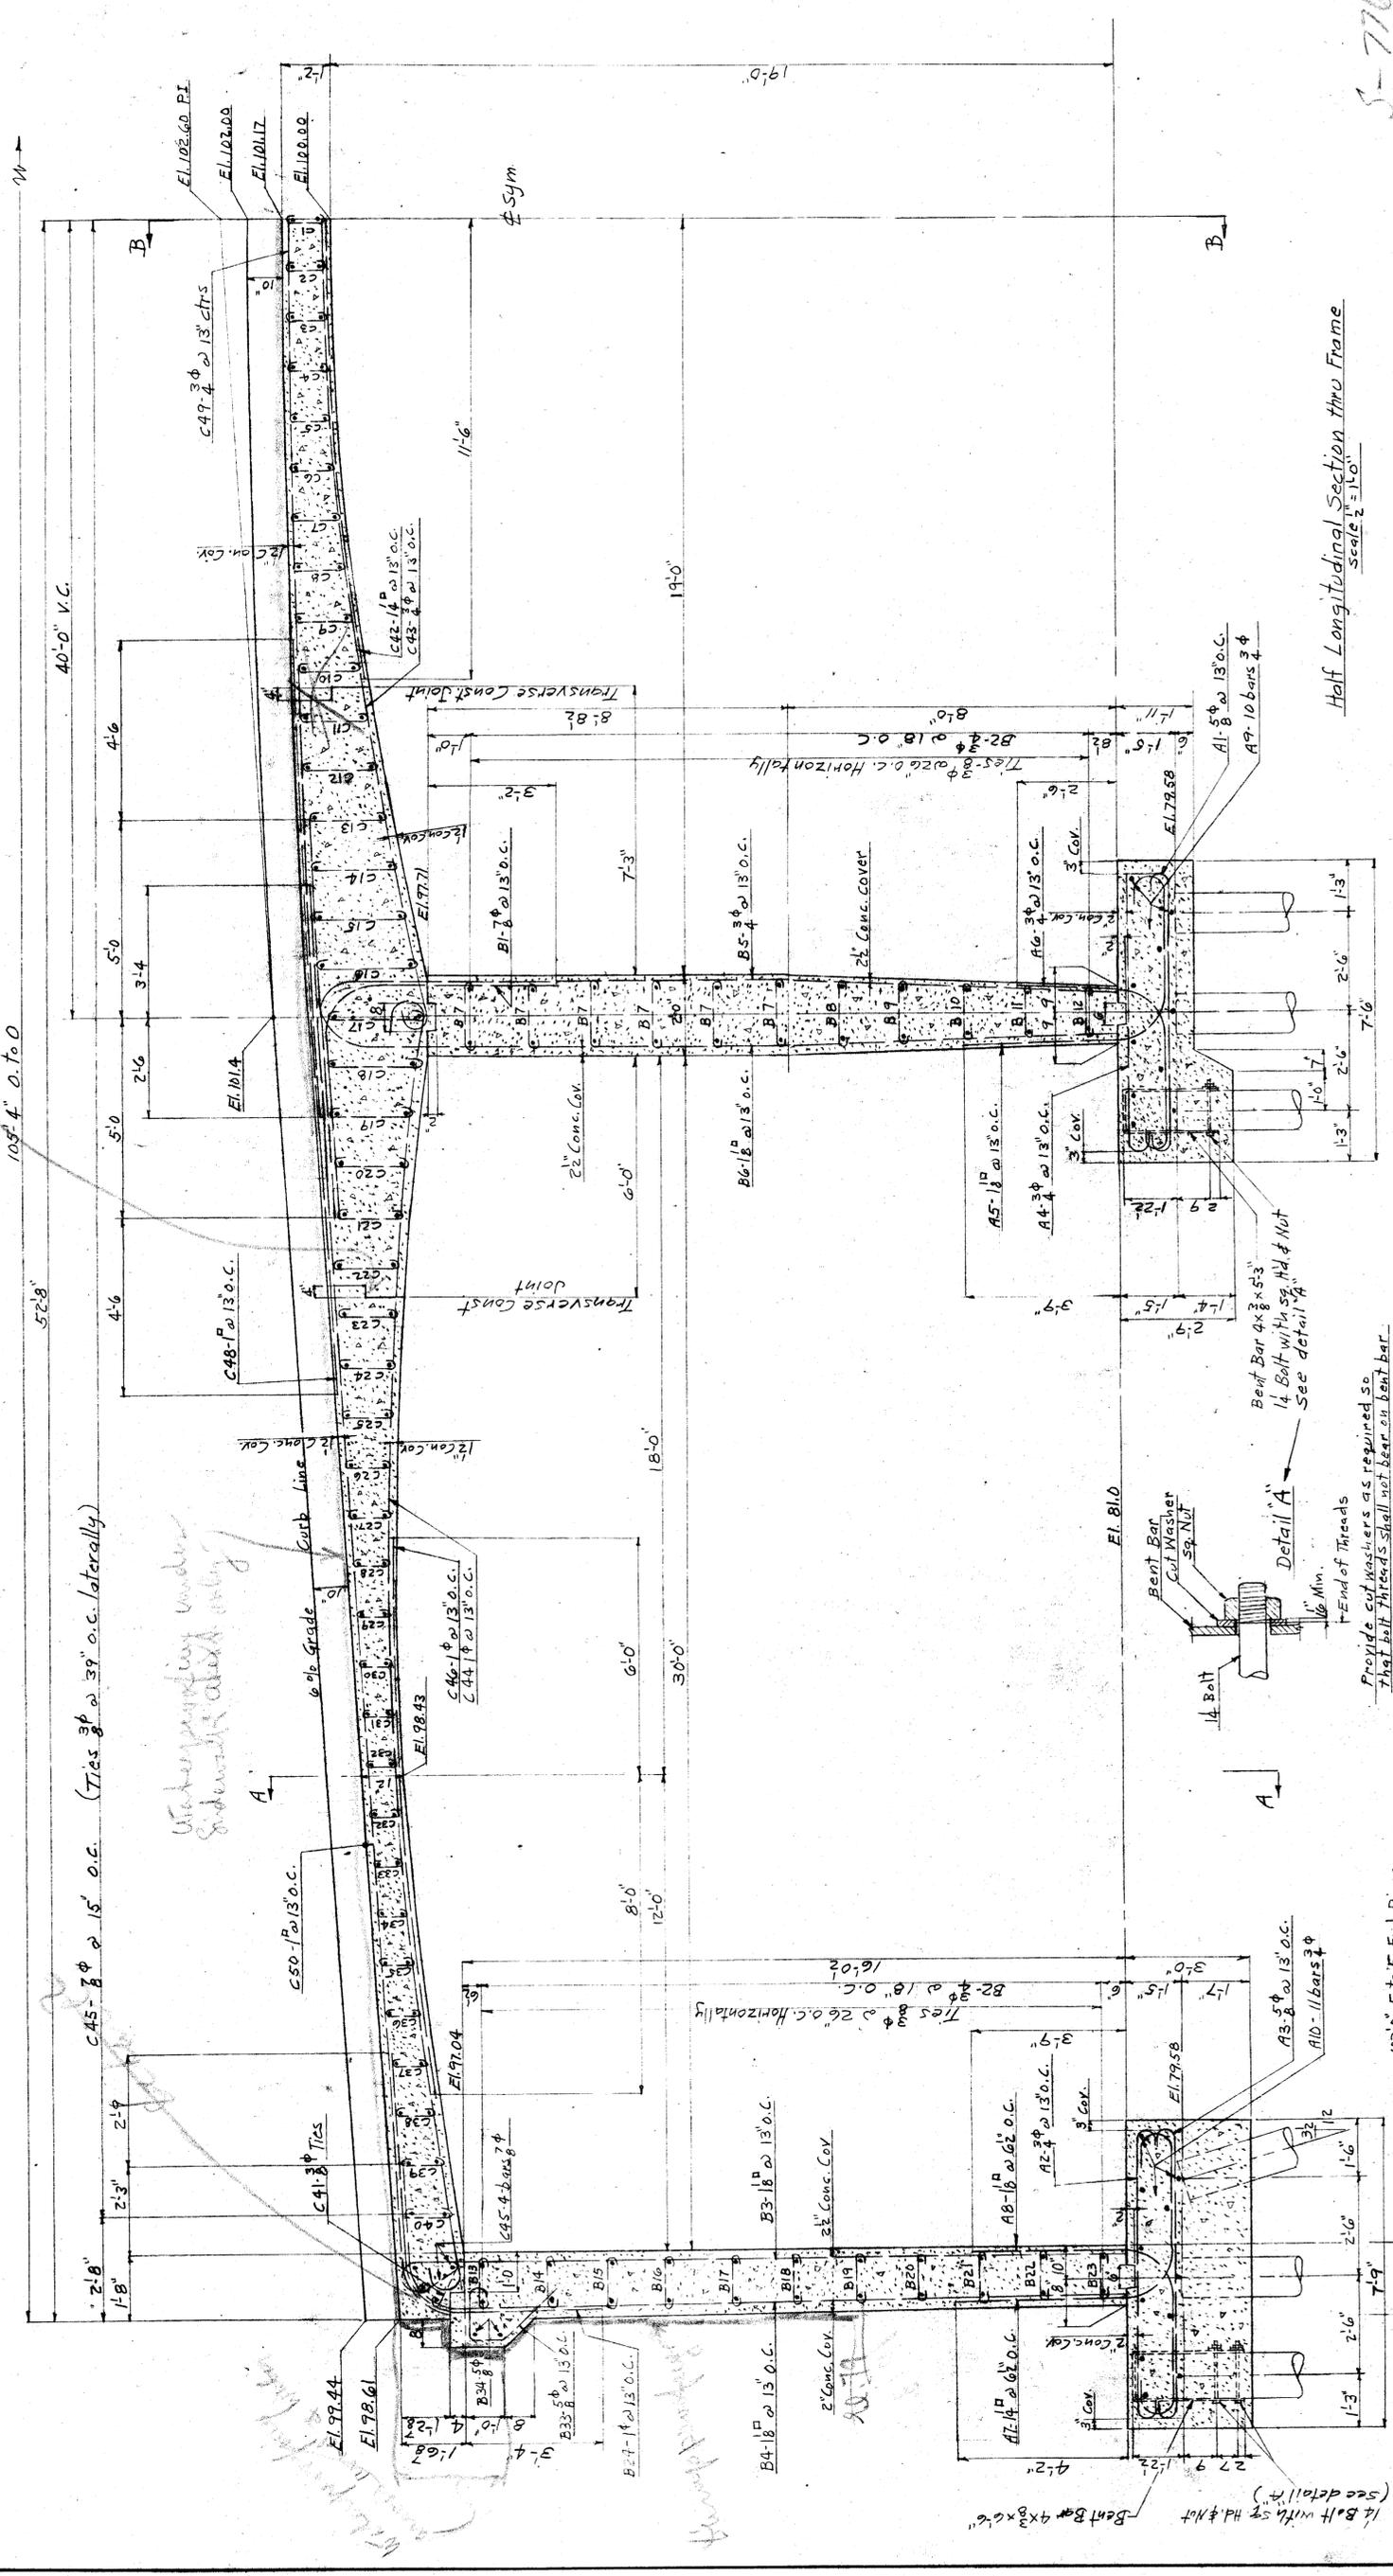

Mark	No.	Size	Length	Type	Distance L	Distance W	Remarks
C6	30	3/4	1-9"	H	1-0"		Deck Center Span
C7	30	3/4	1-9"	H	1-1"		"
C8	30	3/4	2-0"	H	1-24		"
C9	30	3/4	2-0"	H	1-32		"
C10	30	3/4	2-3"	H	1-54		"
C11	30	3/4	2-3"	H	1-7"		"
C12	30	3/4	2-6"	H	1-9"		"
C13	30	3/4	2-9"	H	1-11"		"
C14	30	3/4	2-9"	H	2-18		"
C15	30	3/4	3-0"	H	2-38		"
C16	30	3/4	3-3"	H	2-64		"
C17	30	3/4	3-6"	H	2-98		"
C18	30	3/4	3-3"	H	2-42		Deck End spans
C19	30	3/4	3-0"	H	2-18		"
C20	30	3/4	2-9"	H	1-14		"
C21	30	3/4	2-6"	H	1-82		"
C22	30	3/4	2-3"	H	1-62		"
C23	30	3/4	2-0"	H	1-42		"
C24	30	3/4	2-0"	H	1-22		"
C25	30	3/4	1-9"	H	1-18		"
C26	30	3/4	1-9"	H	1-2		"
C27	30	3/4	1-6"	H	1-2		"
C28	30	3/4	1-6"	H	95		"
C29	30	3/4	1-6"	H	84		"
C30	30	3/4	1-6"	H	84		"
C31	30	3/4	1-6"	H	78		"
C32	60	3/4	1-6"	H	74		"
C33	30	3/4	1-6"	H	8		"
C34	30	3/4	1-6"	H	82		"
C35	30	3/4	1-6"	H	9		"
C36	30	3/4	1-6"	H	98		"
C37	30	3/4	1-6"	H	108		"
C38	30	3/4	1-9"	H	118		"
C39	30	3/4	1-9"	H	148		"
C40	30	3/4	2-0"	H	1-28		"
C41	60	3/4	2-0"	H	1-12		"
C42	40	1/4	23-0"	straight			Deck Center Span
C43	41	3/4	42-9"	K			"
C44	82	1/4	34-6"	M			Deck End Spans
C45	170	3/4	43-6"	straight			Deck
C46	80	1/4	14-0"	"			Deck End Spans
C48	80	1/4	19-0"	straight			Over Center Piers
C49	41	3/4	45-0"	"			Deck Center Span
C50	82	1/4	36-6"	P			Deck End Spans
C51	170	2/4	5-3"	W	1-3		Deck Curbs
C52	170	2/4	4-3"	W	6		"
C53	60	2/4	20-0"	straight			"
D1	56	3/4	8-6"	J			Railings Posts
D2	60	3/4	4-3"	Y	1-1"		"
D3	12	3/4	7-3"	Y	2-08		"

Mark	No.	Size	Length	Type	Distance L	Distance W	Remarks
A1	94	5/8	8-6"	A			Interior Footings
A2	162	3/4	9-0"	A			End
A3	84	5/8	8-9"	A			"
A4	94	3/4	8-0"	B			Interior
A5	86	1/4	9-9"	C			"
A6	86	3/4	8-3"	D			"
A7	162	1/4	10-6"	E			End
A8	162	1/4	10-0"	F			"
A9	20	3/4	49-6"	straight			Interior
A10	22	3/4	44-3"	"			End
A11	12	3/4	4-9"	B		3-04	Interior
B1	80	3/4	11-3"	Q			Interior Piers
B2	88	3/4	43-6"	straight			End & Interior
B3	82	1/4	19-0"	B		17-7	End Piers
B4	82	1/4	20-9"	S			"
B5	82	3/4	22-6"	V			Interior Piers
B6	82	1/4	24-6"	G		1-58	"
B7	252	3/4	2-3"	H		1-48	"
B8	42	3/4	2-3"	H		1-52	"
B9	42	3/4	2-0"	H		1-28	"
B10	42	3/4	2-0"	H		1-12	"
B11	42	3/4	1-9"	H		1-08	End
B12	42	3/4	1-9"	H		1-12	"
B13	42	3/4	2-0"	H		1-14	"
B14	42	3/4	2-0"	H		1-14	"
B15	42	3/4	1-9"	H		1-12	"
B16	42	3/4	1-9"	H		1-18	"
B17	42	3/4	1-9"	H		1-14	"
B18	42	3/4	1-9"	H		1-14	"
B19	42	3/4	1-9"	H		1-04	"
B20	42	3/4	1-9"	H		1-08	"
B21	42	3/4	1-9"	H		1-04	"
B22	42	3/4	1-9"	H		1-04	"
B23	42	3/4	1-9"	H		1-04	"
B24	80	1/4	10-9"	N		2-6	"
B25	28	3/4	7-5"	R		3-0 1-7	Interior
B26	4	3/4	8-0"	R		3-0 1-6	"
B27	4	3/4	8-0"	R		3-0 1-48	"
B28	4	3/4	7-9"	R		3-0 1-37	"
B29	4	3/4	7-9"	R		3-0 1-28	"
B30	4	3/4	7-6"	R		3-0 1-12	"
B31	8	3/4	10-0"	straight			"
B32	4	3/4	16-9"	"			"
B33	60	5/8	4-6"	T			End
B34	4	5/8	31-0"	straight			End
C1	15	3/4	1-6"	H		9-4	Deck Center Span
C2	30	3/4	1-6"	H		9-6	"
C3	30	3/4	1-6"	H		10-8	"
C4	30	3/4	1-6"	H		10-2	"
C5	30	3/4	1-9"	H		11-4	"

NO.	DATE	DESCRIPTION	REVISIONS

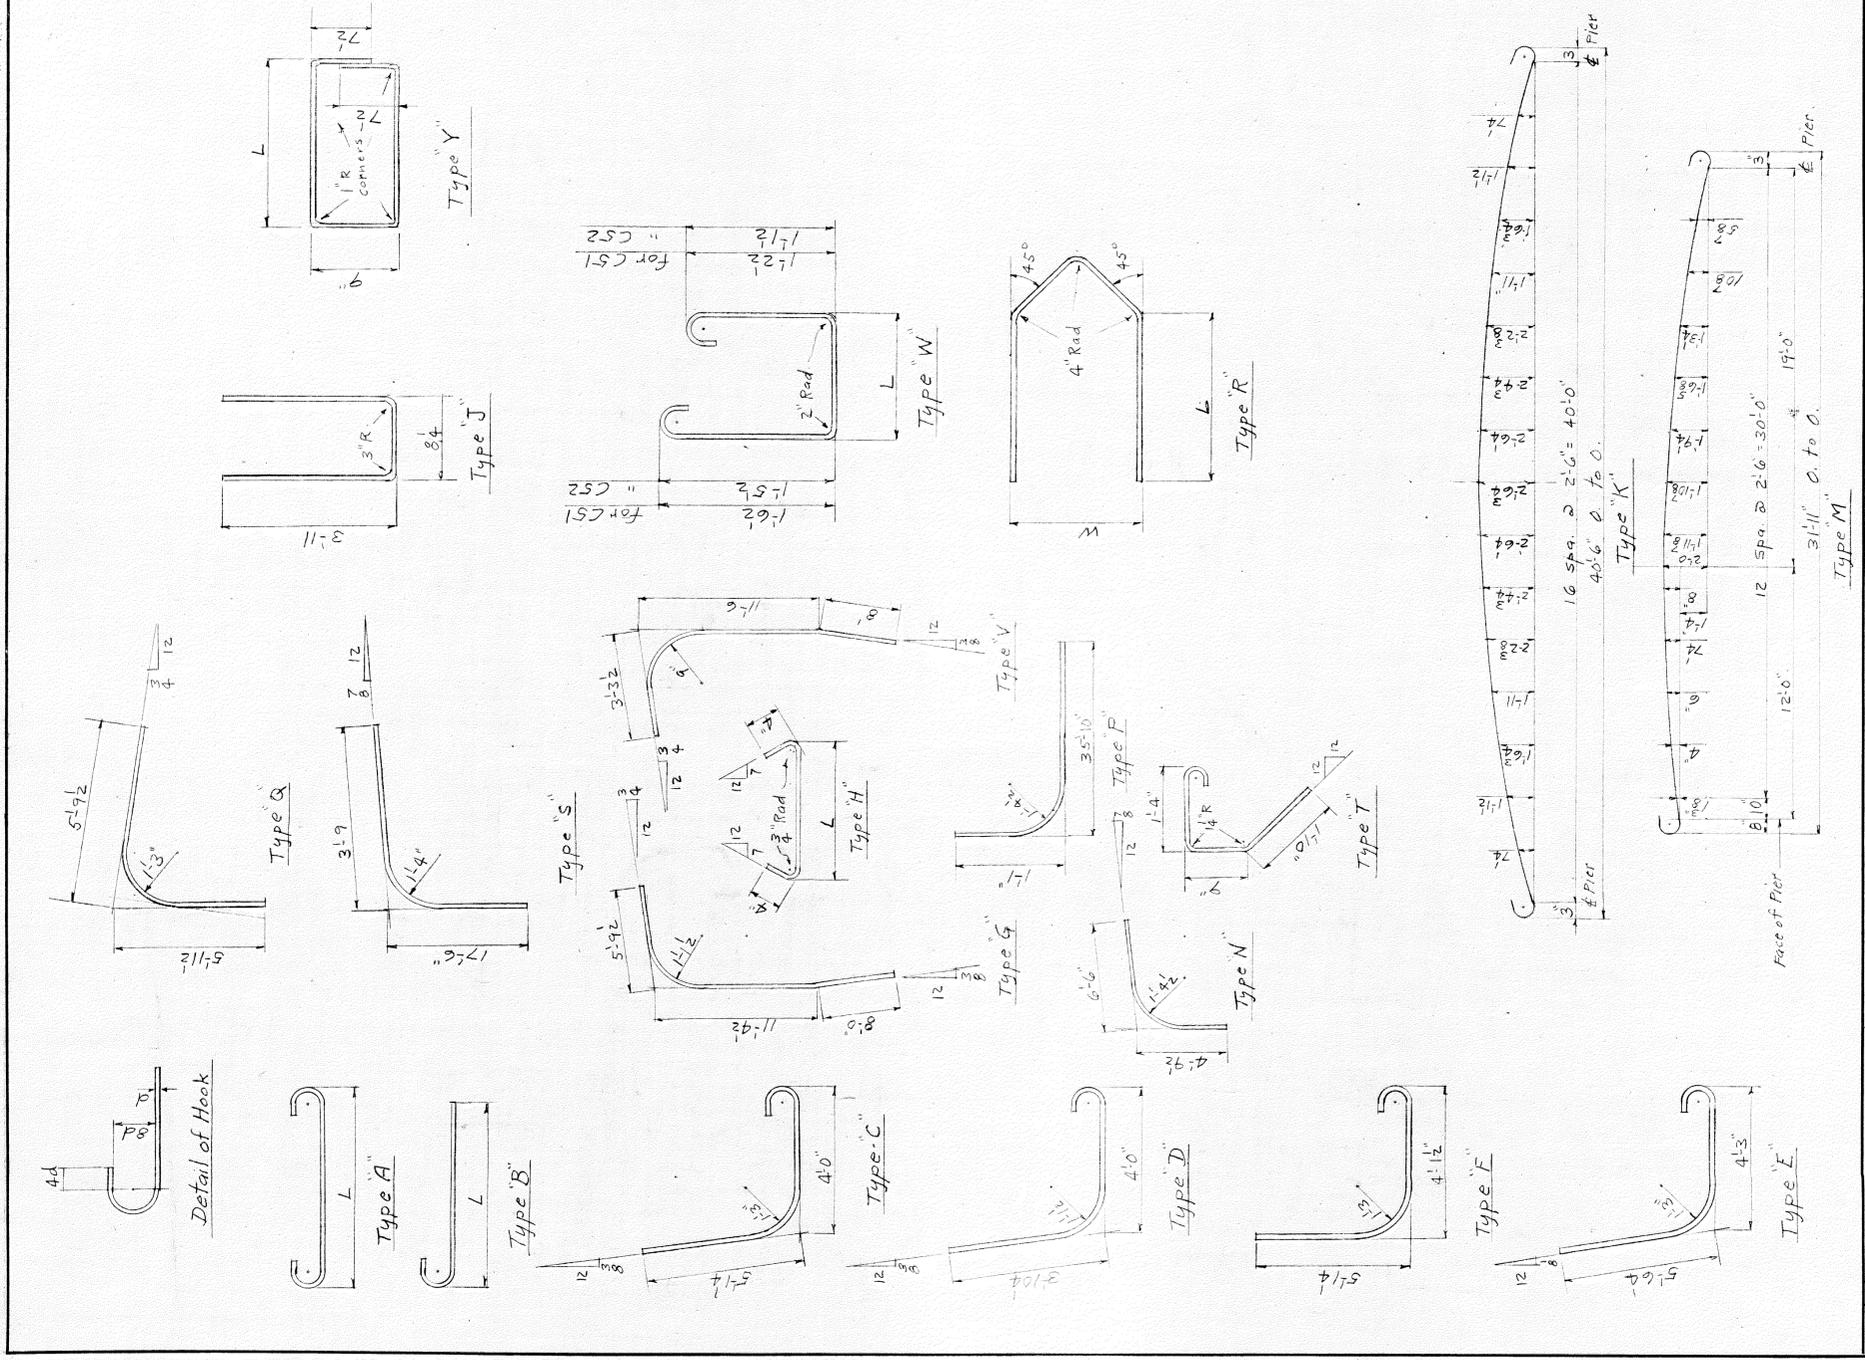

CITY OF DETROIT
DEPARTMENT OF PUBLIC WORKS
CITY ENGINEERS OFFICE

APPROVED: _____
ENGINEER OF _____
CITY ENGINEER

DESIGNED BY _____
DRAWN BY _____
TRACED BY _____
CHECKED BY _____


SHEET OF SHEETS
JOB NO. _____
DRAWG NO. 1022145
DATE _____

SCALE _____

BOOK NO. _____
PAGE _____

301/9-26-95

MARK	NO.	SIZE	LENGTH	TYPE	DIMENSION		LOCATION
					L	W	
F1	192	5/8"	9'-6"	B	8'-9 1/2"	—	Units "A" 8" C West Abut. Pier Wing Wall do "A" East do do do do
F2	132	5/8"	6'-0"	B	5'-3 1/2"	—	Units "A" 8" C West Abut. Pier Wing Wall do "A" East do do do do
F3	34	1/2"	10'-6"	Straight	—	—	Unit "A" do do do do do do
F4	16	1/2"	29'-6"	Straight	—	—	do "A" do do do do do do
F5	238	1/2"	7'-0"	Straight	—	—	Units "A" 8" C West Abut. Pier Wing Wall do "A" East do do do do
F6	16	1/2"	38'-3"	AB	9'-6 1/2"	28'-6 1/2"	Unit "A" do do do do do do
F7	34	3/4"	6'-0"	Straight	—	—	do "A" do do do do do do
F8	32	1/2"	21'-0"	Straight	—	—	Units "A" 8" C West Abut. Pier Wing Wall do "A" East do do do do
F9	18	1/2"	30'-0"	Straight	—	—	Unit "A" do do do do do do
F10	8	1/2"	21'-6"	Straight	—	—	do "A" do do do do do do
F11	4	1/2"	26'-0"	Straight	—	—	do "A" do do do do do do
F12	36	1/2"	21'-3"	Straight	—	—	do "A" do do do do do do
F13	4	1/2"	11'-9"	Straight	—	—	do "B" do do do do do do
F14	32	1/2"	13'-9"	Straight	—	—	do "B" do do do do do do
F15	38	1/2"	9'-0"	AC	4'-3 1/2"	0'-6 1/2"	do "A" do do do do do do
F16	16	1/2"	8'-0"	AC	3'-9"	0'-6 1/2"	do "A" do do do do do do
F17	16	1/2"	7'-0"	AC	3'-2 1/2"	0'-6 1/2"	do "A" do do do do do do
F18	18	1/2"	5'-9"	AC	2'-8"	0'-6 1/2"	do "A" do do do do do do
F19	16	1/2"	4'-9"	AC	2'-1 1/2"	0'-6 1/2"	do "B" do do do do do do
F20	14	1/2"	3'-9"	AC	1'-6 1/2"	0'-6 1/2"	do "B" do do do do do do

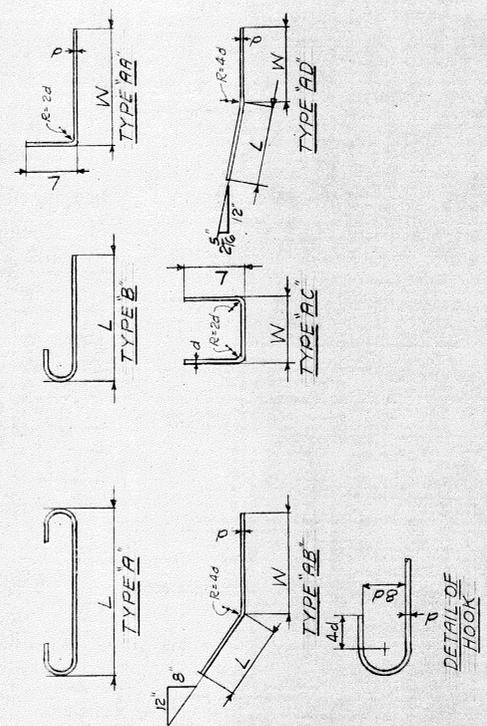

MARK	NO.	SIZE	LENGTH	TYPE	DIMENSION		LOCATION
					L	W	
E1	480	5/8"	11'-0"	A	9'-6"	—	Unit "A" West Abut. Pier Wing Wall do "A" East do do do do
E2	162	3/4"	12'-3"	AA	9'-6 1/2"	28'-6 1/2"	do "A" West do do do do do do
E3	2	3/4"	37'-6"	AB	9'-2"	28'-2"	do "A" East do do do do do do
E4	2	3/4"	33'-3"	AB	7'-0 1/2"	26'-0 1/2"	do "A" West do do do do do do
E5	4	1/2"	39'-0"	AB	9'-5 1/2"	28'-5 1/2"	do "A" do do do do do do do do
E6	2	1/2"	37'-6"	AB	9'-2"	28'-2"	do "A" do do do do do do do do
E7	4	1/2"	36'-9"	AB	8'-10 1/2"	27'-10 1/2"	do "A" do do do do do do do do
E8	4	1/2"	36'-3"	AB	8'-7"	27'-7"	do "A" do do do do do do do do
E9	4	1/2"	35'-9"	AB	8'-3 1/2"	27'-3 1/2"	do "A" do do do do do do do do
E10	4	1/2"	35'-0"	AB	8'-0"	27'-0"	do "A" do do do do do do do do
E11	4	1/2"	34'-6"	AB	7'-8"	26'-8"	do "A" do do do do do do do do
E12	4	1/2"	33'-9"	AB	7'-8"	26'-8"	do "A" do do do do do do do do
E13	2	1/2"	33'-3"	AB	7'-0 1/2"	26'-8"	do "A" do do do do do do do do
E14	4	1/2"	32'-6"	AB	6'-9"	25'-9"	do "A" do do do do do do do do
E15	28	3/4"	8'-9"	A	7'-0"	—	do "B" do do do do do do do do
E16	28	1/2"	10'-3"	Straight	—	—	do "B" do do do do do do do do
E17	2	3/4"	10'-9"	Straight	—	—	do "B" do do do do do do do do
E18	18	1/2"	9'-9"	AA	7'-0 1/2"	26 1/2"	do "B" do do do do do do do do
E19	80	5/8"	7'-6"	A	6'-0"	—	do "C" do do do do do do do do
E20	26	3/4"	14'-0"	Straight	—	—	do "B" East do do do do do do
E21	2	1/2"	23'-0"	Straight	—	—	do "C" West do do do do do do
E22	54	1/2"	8'-9"	AA	6'-0 1/2"	23 1/2"	Units "B" 8" C West Abut. Pier Wing Nails
E23	2	3/4"	40'-0"	AD	9'-4 1/2"	30'-7 1/2"	Unit "C" West Abut. Pier Wing Nails do "A" East do do do do do do
E24	2	3/4"	39'-6"	AD	8'-8 1/2"	30'-5 1/2"	do "A" do do do do do do do do
E25	4	1/2"	40'-0"	AD	9'-5 1/2"	30'-6 1/2"	do "A" do do do do do do do do
E26	2	1/2"	40'-0"	AD	9'-4 1/2"	30'-7 1/2"	do "A" do do do do do do do do
E27	4	1/2"	40'-0"	AD	9'-3 1/2"	30'-5 1/2"	do "A" do do do do do do do do
E28	4	1/2"	40'-0"	AD	9'-2 1/2"	30'-3 1/2"	do "A" do do do do do do do do
E29	4	1/2"	40'-0"	AD	9'-1"	30'-11"	do "A" do do do do do do do do
E30	4	1/2"	40'-0"	AD	9'-0"	31'-0"	do "A" do do do do do do do do
E31	4	1/2"	40'-0"	AD	8'-10 1/2"	30'-10 1/2"	do "A" do do do do do do do do
E32	4	1/2"	39'-9"	AD	8'-9 1/2"	30'-9 1/2"	do "A" do do do do do do do do
E33	2	1/2"	39'-6"	AD	8'-8 1/2"	30'-5 1/2"	do "A" do do do do do do do do
E34	4	1/2"	39'-3"	AD	8'-7 1/2"	30'-7 1/2"	do "A" do do do do do do do do
E35	28	3/4"	17'-6"	Straight	—	—	do "B" do do do do do do do do

SHEET — OF — SHEETS
JOB NO.
DRAWG NO. E-13-87
DATE

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CITY ENGINEERS OFFICE


APPROVED: H.O. Titus
DESIGNED BY: H.O. Titus
DRAWN BY: H.O. Titus
TRACED BY: H.O. Titus
CHECKED BY: H.O. Titus

REVISIONS


ENGINEER OF CITY ENGINEER

Remforming Units for Abut. Pier Wing Walls
Preliminary For Office Use Only
Job: A-1667-15-90-100-100


PLAN OF RAILING AND SPANDREL WALL

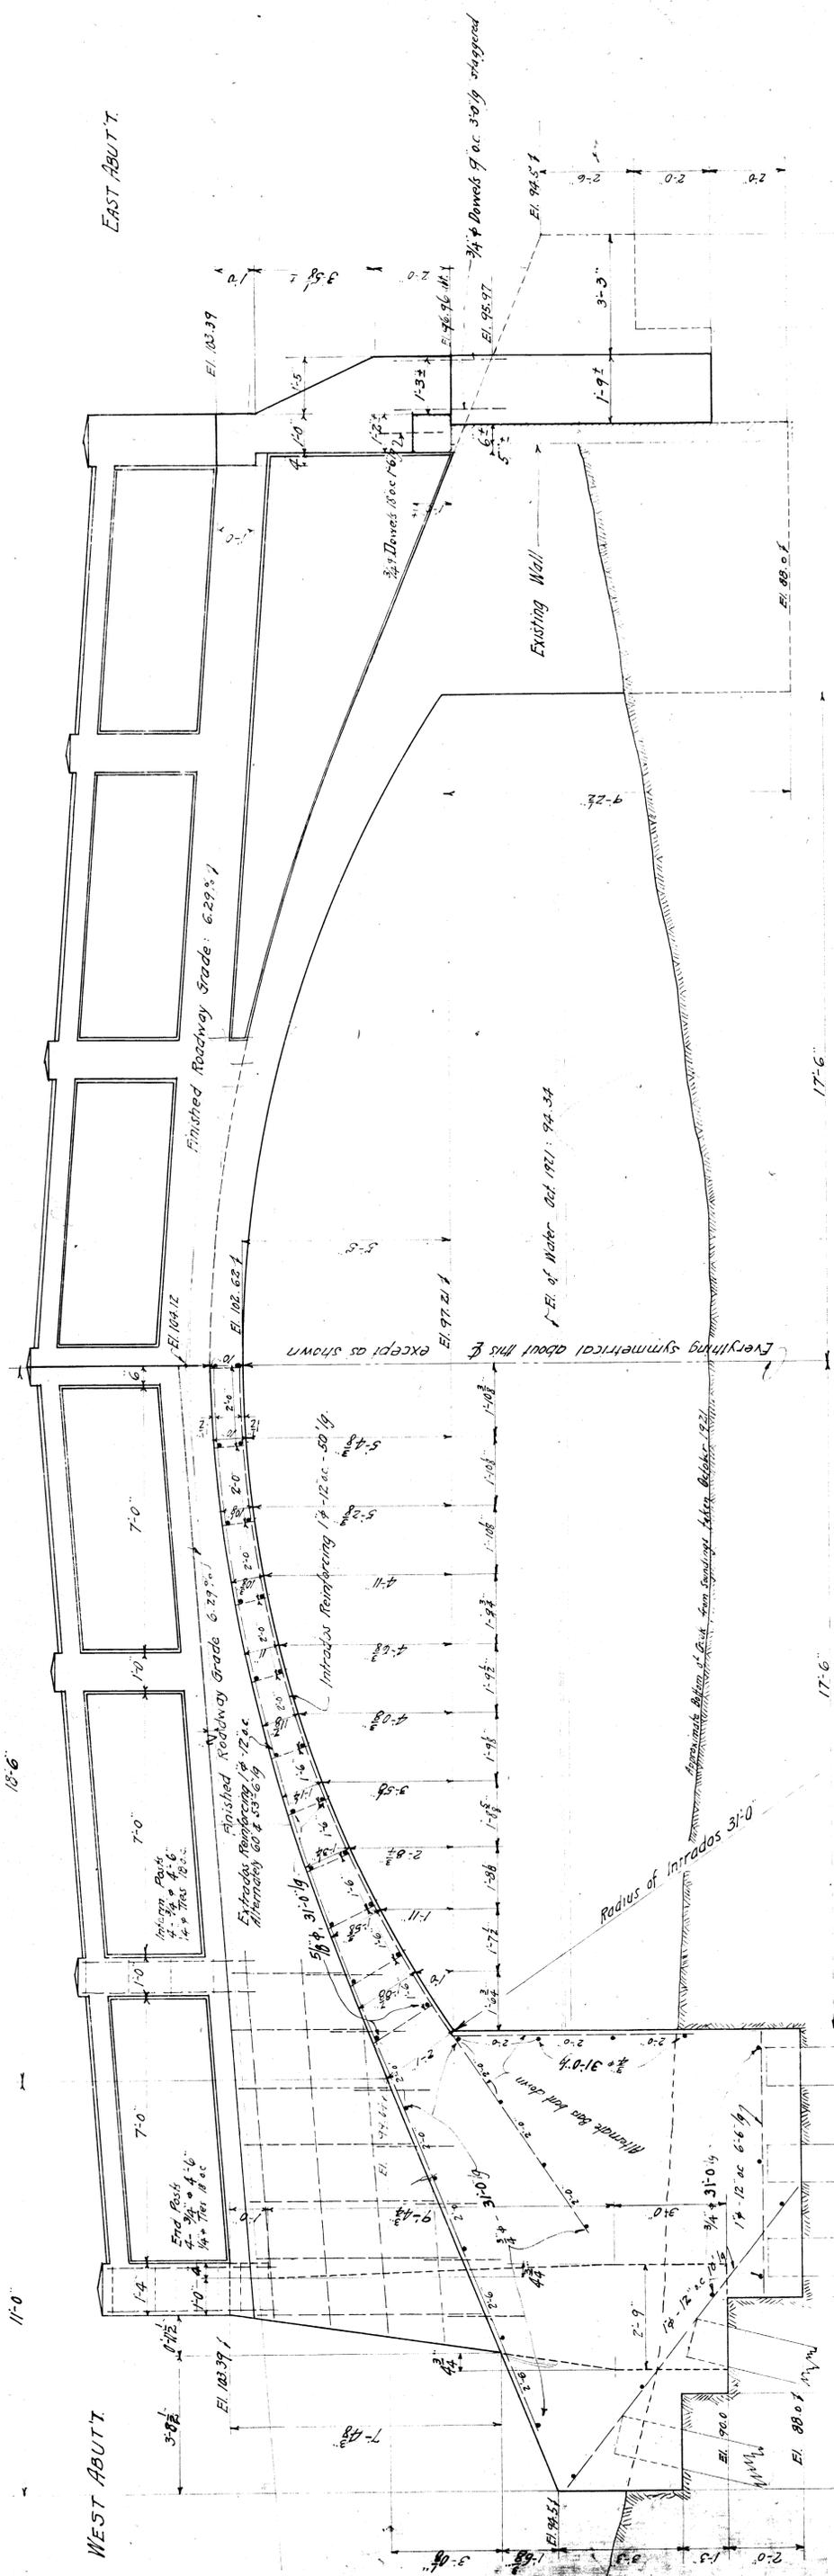

SECTION THRU WEST HALF OF ARCH.

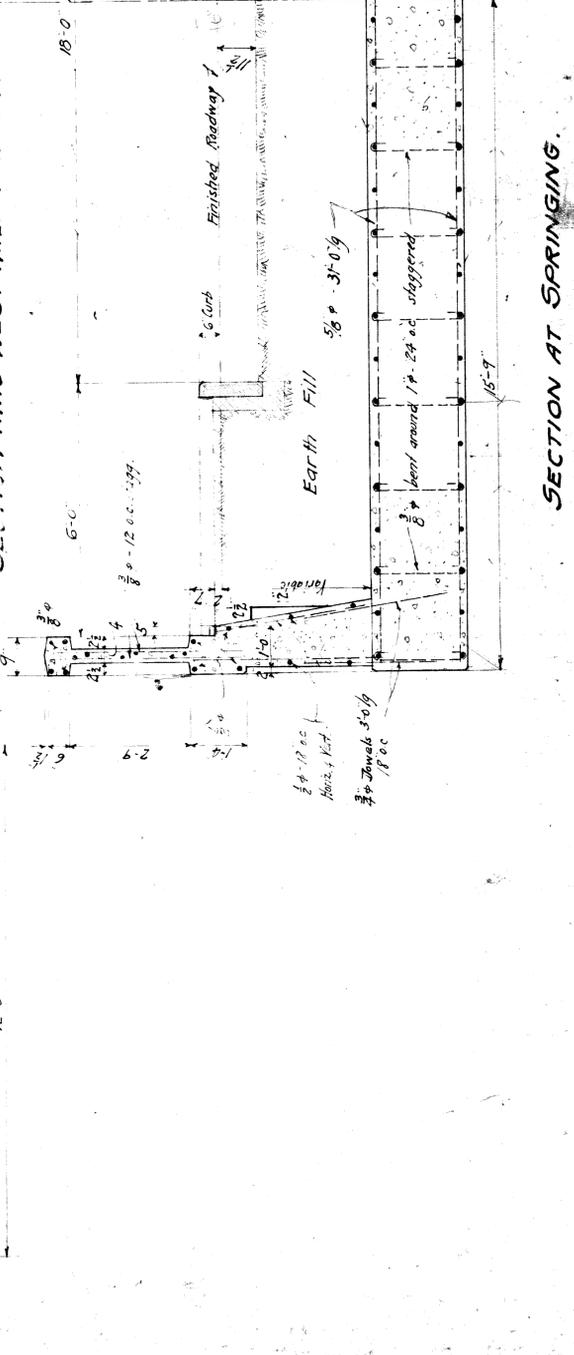

ELEVATION OF EAST HALF OF ARCH.

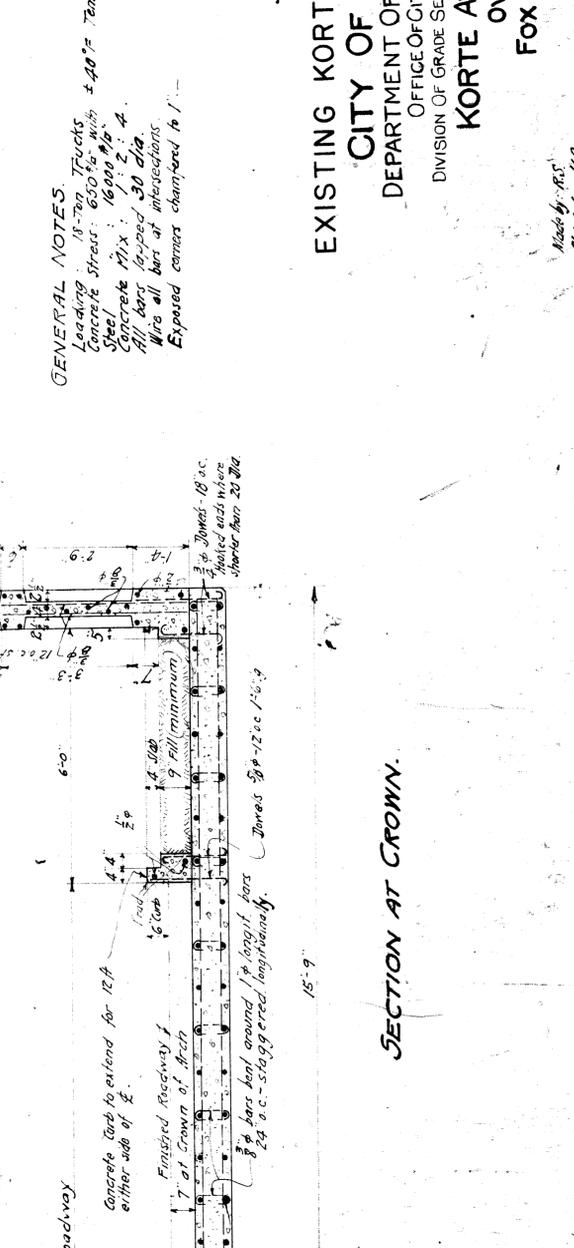

GENERAL NOTES.
 Leading 18-20 Trucks
 Concrete Strength: 6000 lbs. per sq. in. $\pm 40\%$ Temperature Change included.
 Steel Stress: 16000 lbs. per sq. in.
 Concrete Mix: 10 parts 1" to 2" aggregate to 1 part cement to 3 parts sand.
 All bars shall be lap spliced 30 dia.
 All bars at intersections shall be staggered to 1'-0".
 Exposed corners chamfered to 1"

EXISTING KORTE AVE. BRIDGE
CITY OF DETROIT
 DEPARTMENT OF PUBLIC WORKS
 OFFICE OF CITY ENGINEER
 DIVISION OF GRADE SEPARATION AND BRIDGES
KORTE AVE. ARCH
OVER
FOX CREEK

Made by: R.S.
 Check by: J.B.
 Scale: 1/8" = 1'-0"

