

UTILITIES	
ELECTRIC	DETROIT EDISON 2000 SECOND AVE. ROOM 607 G.O., DETROIT, MICHIGAN 48226 ATTN.: JOHN SOUTIRES PHONE No.: (313) 235-6597
TELEPHONE	AMERITECH 4000 ALLEN RD., ROOM 101 ALLEN PARK, MICHIGAN 48101 ATTN.: DAVE BUCIENSKI PHONE No.: (313) 389-9819
GAS	MICHIGAN CONSOLIDATED GAS CO. DRAFTING CLERK MAIN REPLACEMENT TEAM NOBLE SECOND FLOOR 3200 HOBSON DETROIT, MICHIGAN 48201 PHONE No.: (313) 577-7236
WATER & SEWAGE	CITY OF DETROIT WATER & SEWERAGE DEPARTMENT 735 RANDOLPH ST. DETROIT, MICHIGAN 48226 PHONE No.: (313) 224-4800
LIGHTING	CITY OF DETROIT PUBLIC LIGHTING DEPARTMENT 9449 GRINDEL DETROIT, MICHIGAN 48226 PHONE No.: (313) 267-7336

EXISTING STRUCTURE
ONE - SPAN REINFORCED CONCRETE ARCH STRUCTURE MEASURING 12.80 METERS REFERENCE LINE TO REFERENCE LINE - BUILT IN 1909, 9144 mm CLEAR ROADWAY.

BENCH MARK
B.M. #62-258
MONUMENT BOX IN SIDEWALK, NORTHEAST QUADRANT OF JEFFERSON AVE. AND CHALMERS
ELEV. 175.773



B.M. #62-255A
MONUMENT BOX IN SIDEWALK, NORTHEAST QUADRANT OF FRIED AND CHALMERS
ELEV. 174.776


PROPOSED REPLACEMENT RIVERSIDE AVE. BRIDGE
MOOT - BOT OF 1038
CITY - BW-242

EXISTING STRUCTURE TO BE REMOVED

DRIVEWAYS TO BE PAVED TO PROVIDE A SMOOTH TRANSITION BETWEEN PROPOSED PAVEMENT AND EXISTING DRIVEWAY AS DIRECTED BY ENGINEER. INCLUDED IN PAY ITEM "CONCRETE PAVEMENT".

WITNESSES	
WITNESS TO SURVEY	STA. 9+900 (MAG NAIL) N & S IN W. SIDE 254 mm LOCUST N & S IN W. SIDE 203 mm LOCUST S 10° W N & S IN E. SIDE POWER POLE 10-766 m 9-372 m 16-278 m
WITNESS TO SURVEY	STA. 10+100 (PK. SET) N & S IN S. SIDE 762 mm MAPLE N & S IN N. SIDE POWER POLE N & S IN E. SIDE POWER POLE 11-950 m 33-000 m 18-530 m

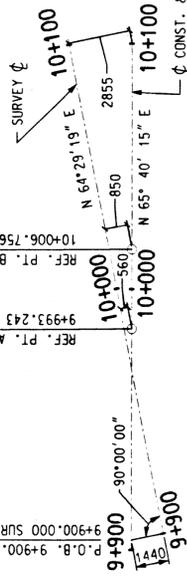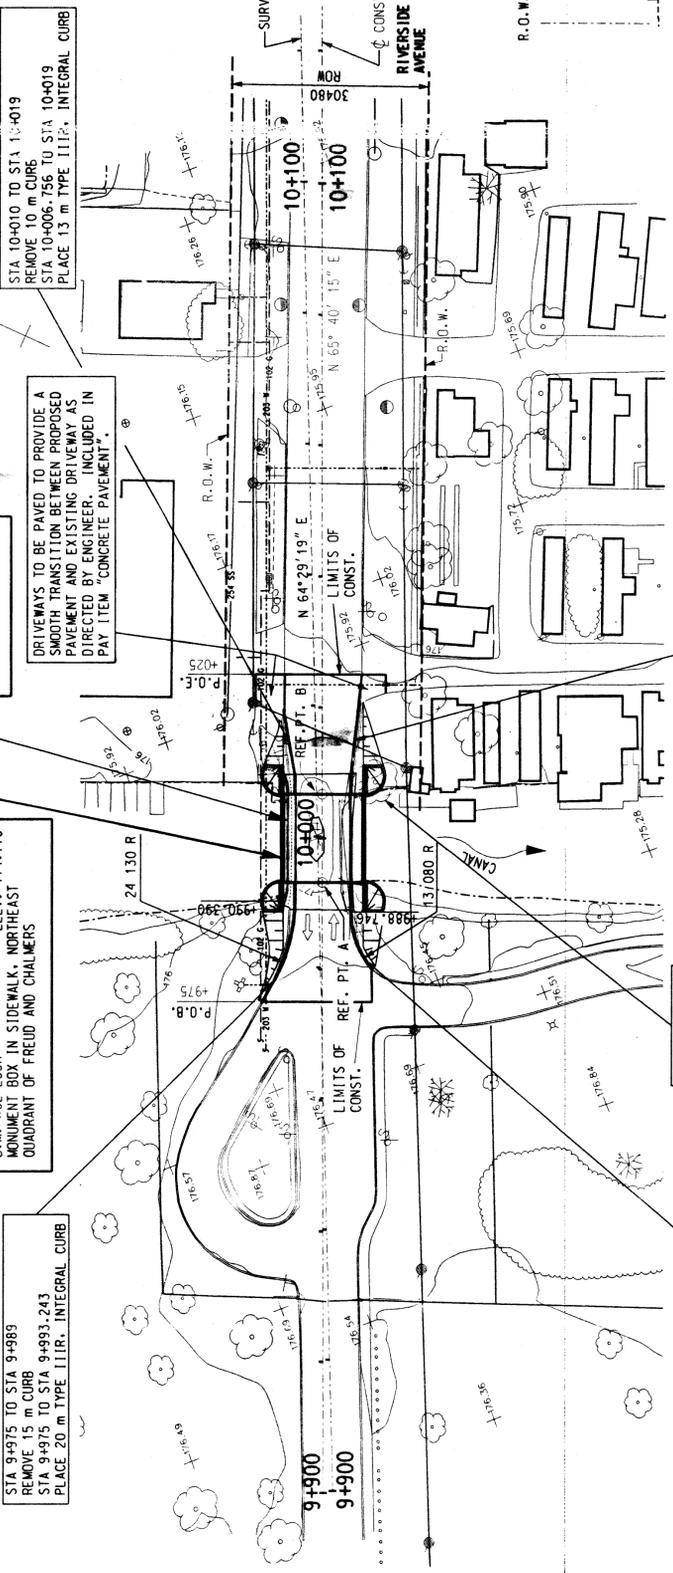

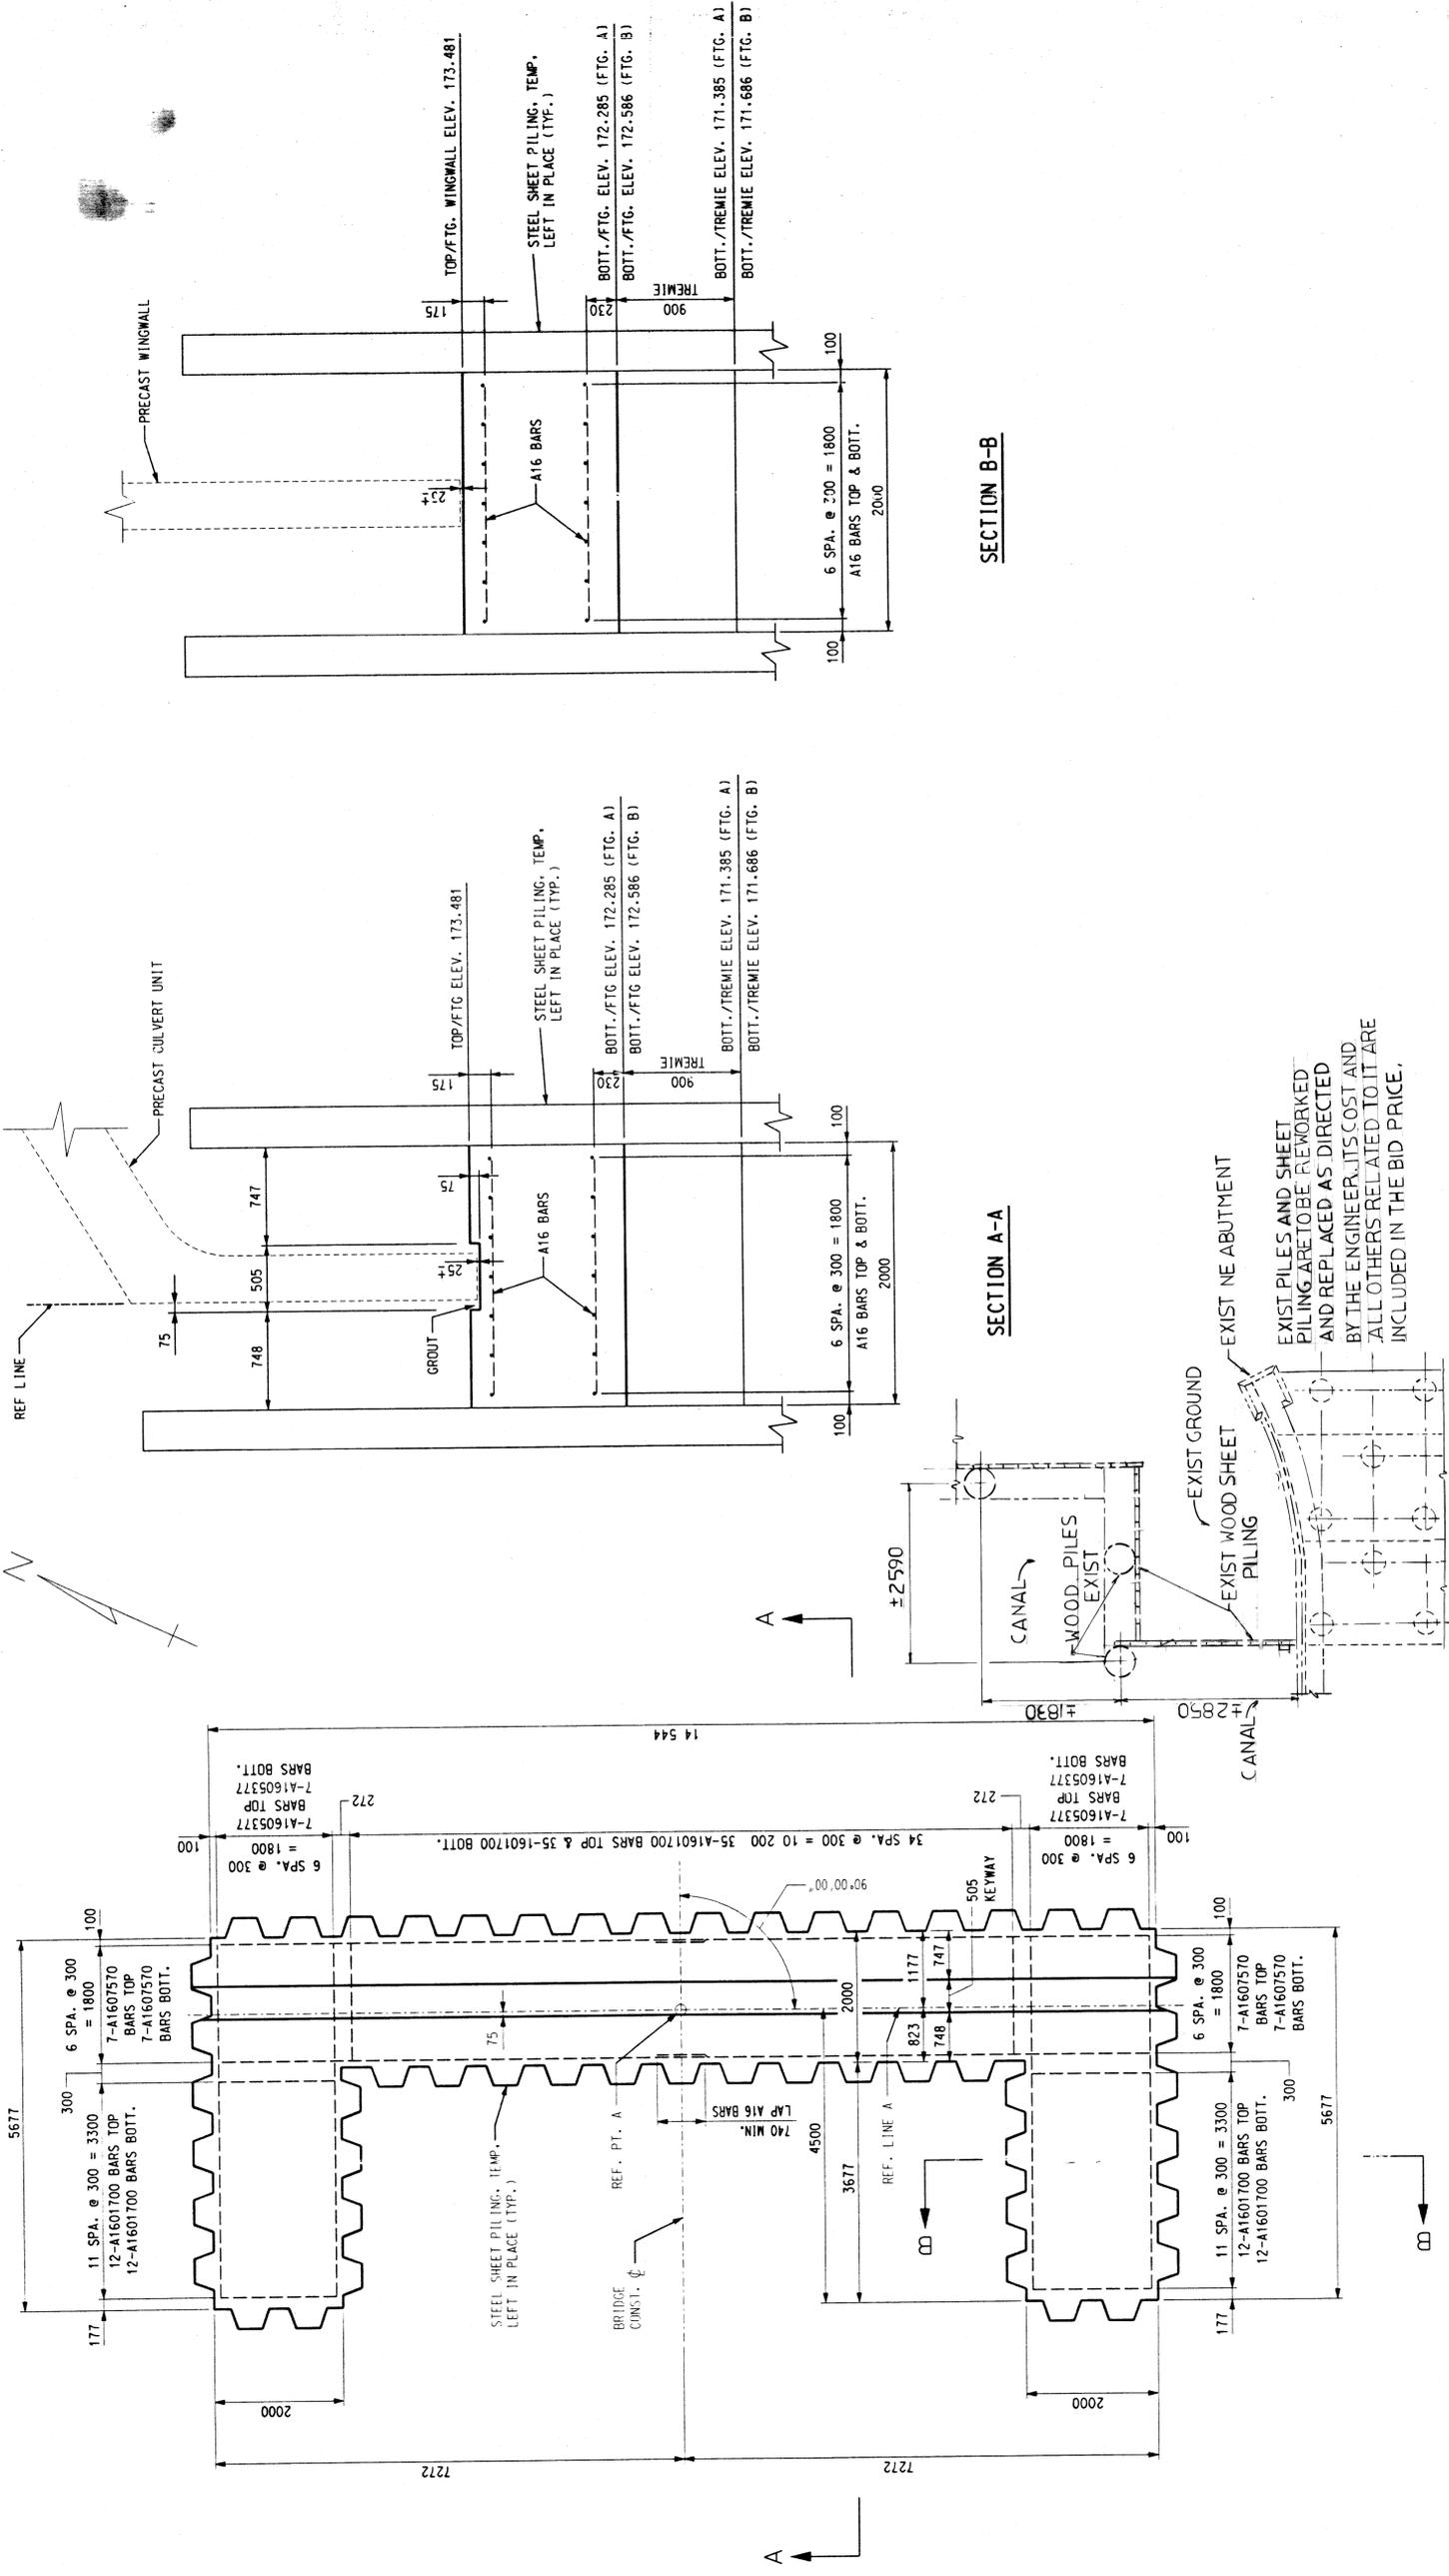

PLAN OF FOOTING LAYOUT
(ABUTMENT A SHOWN ABUTMENT B OPPOSITE HAND)

SECTION A-A

SECTION B-B

DETAIL A (EXIST)
NTS REF SHTR4

METRIC

DIMENSIONS ARE IN MILLIMETERS UNLESS OTHERWISE SHOWN. ELEVATIONS, COORDINATES, CURVE AND ALIGNMENT DATA ARE IN METERS. STATIONS ARE IN KILOMETERS + METERS.

SCALE	NOT TO SCALE
PROJECT NO.	9641-5160-01
SHEET NO.	R5 OF 8

RIVERSIDE AVE
OVER CANAL
(BW-242)

CITY OF DETROIT
MICHIGAN




SNELL ENVIRONMENTAL GROUP, INC.
A DLZ Company
151 W. CONGRESS, SUITE 328
DETROIT, MICHIGAN 48226
TELEPHONE: (313) 281-6000




DESIGN BY	C.D.P.	12-97
DR'N BY	R.J.D.	5-97
CK'D BY	R.G.W.	5-97
FINAL CK'D BY	M.D.W.	2-99
APP'D BY		


REVISIONS	

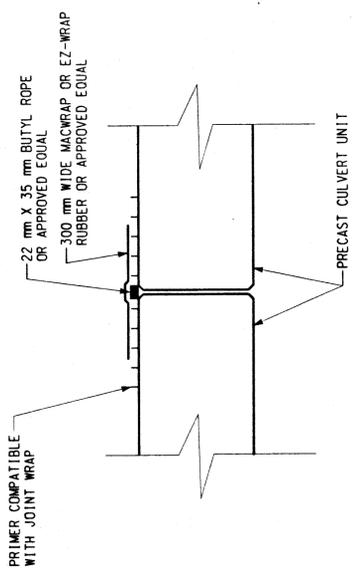


STANDARD JOINT DETAIL

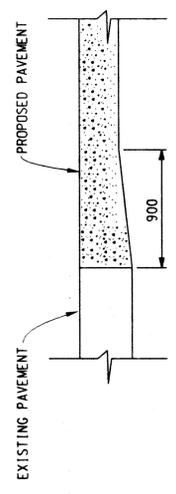


DETAIL OF THICKENED EDGE
PROVIDE THIS THICKENED EDGE WHERE PROPOSED PAVEMENT MEETS EXIST. PAVEMENT

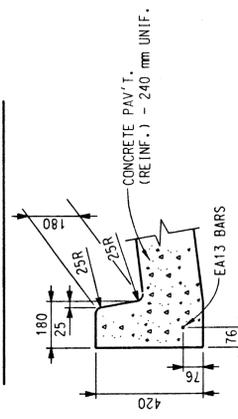


TYPE IIR, INTEGRAL CURB

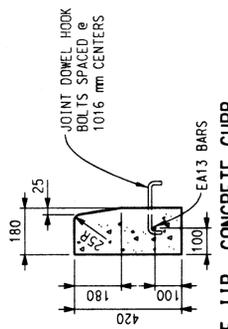


TYPE IIR, CONCRETE CURB (OPTIONAL)

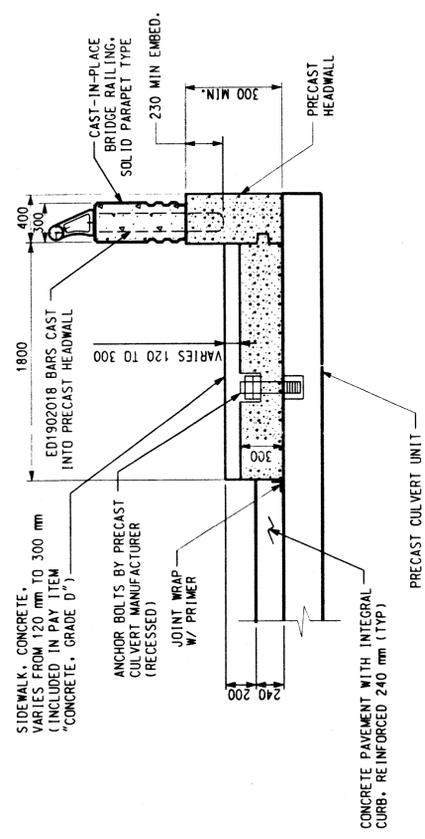


DETAIL A

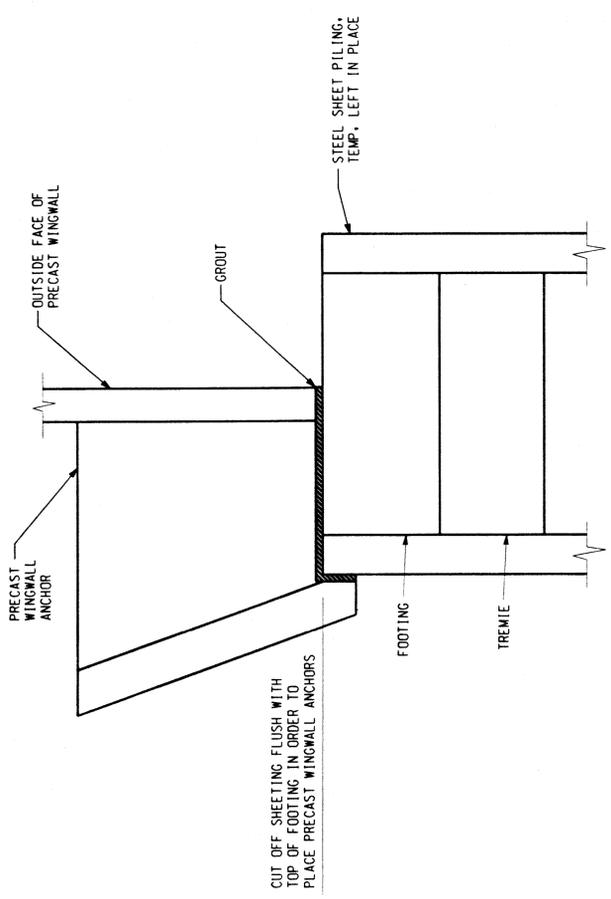

TYPICAL SECTION THRU PRECAST WINGWALL

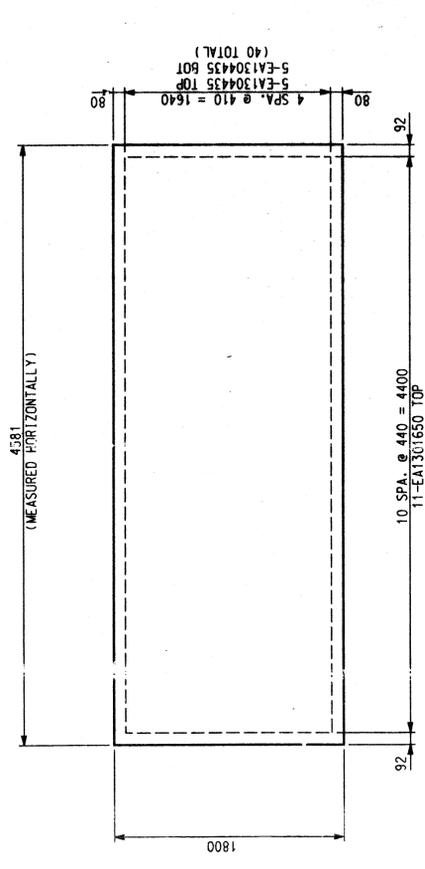

TYPICAL SIDEWALK, CONCRETE, 300 mm DETAIL
(TYPICAL ALL 4 QUADRANTS)

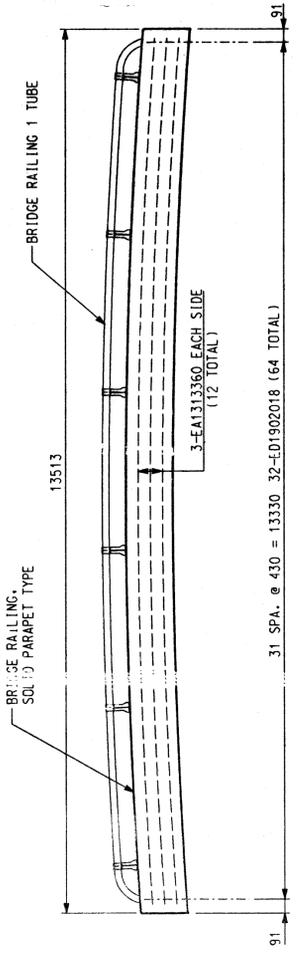

BRIDGE RAILING ELEVATION

NOTE:
DEWATERING SHALL BE INCLUDED IN PAY ITEM "STEEL SHEET PILING, TEMP. LEFT IN PLACE"

METRIC

DIMENSIONS ARE IN MILLIMETERS UNLESS OTHERWISE SHOWN. ELEVATIONS, COORDINATES CURVE AND ALIGNMENT DATA ARE IN METERS. STATIONS ARE IN KILOMETERS + METERS.

SCALE	NOT TO SCALE
PROJECT NO.	9641-5160-01
SHEET NO.	R6 OF 8

MISCELLANEOUS DETAILS

RIVERSIDE AVE. OVER CANAL (BW-24?)

CITY OF DETROIT MICHIGAN

SNELL ENVIRONMENTAL GROUP, INC. A DLZ Company
151 W. CONGRESS, SUITE 328
DETROIT, MICHIGAN 48226
TELEPHONE: (313) 281-0000
FAX: (313) 281-0000






DESIGN BY	C.D.P.	12-97
DR'N BY	R.J.D.	5-97
CR'D BY	R.G.W.	5-97
FINAL CR'D BY	M.D.W.	2-99

REVISIONS	
-----------	--

BAR	DIMENSIONS											NO. REOD	TOTAL MASS	
	a	b	c	d	e	f	g	h	j	k	m			
A1601700	1700												236	623
A1605377	5377												56	467
A1607570	7570												56	658
SUBTOTAL = 1748 kg														
EAI301650	1650												88	144
EAI304435	4435												40	176
EAI313360	13360												12	159
ED1902018*	940	138	940										64	289
EPOXY SUBTOTAL = 768 kg														

* SHALL BE CAST IN PRECAST CULVERT HEADWALL.
 REINFORCEMENT SHALL BE BUNDLED AND TAGGED AS TO THE LOCATION AS SHOWN ON THIS SHEET.
 ALL BENDS IN REINFORCING STEEL TO BE MADE ABOUT A PIN OF THE MINIMUM DIAMETER ALLOWED BY THE STANDARD SPECIFICATIONS.
 TOLERANCES IN CUTTING AND BENDING BARS ARE AS ESTABLISHED IN THE MANUAL OF STANDARD PRACTICE OF THE CONCRETE REINFORCING STEEL INSTITUTE AND DETAILING MANUAL OF THE AMERICAN CONCRETE INSTITUTE.
 WHERE FIELD CUTTING OF EPOXY BARS IS REQUIRED, THE CONTRACTOR SHALL REPAIR THE EPOXY COATING AT THE CUT END AS PROVIDED FOR IN STANDARD SPECIFICATION 706-03-E.8.

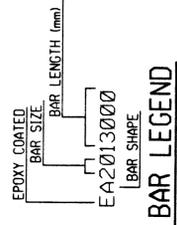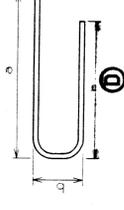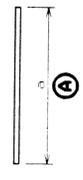

BAR LEGEND

ITEM NO.	ITEM DESCRIPTION	UNIT	QUANTITY
1500000	MOBILIZATION, MAX.	Lsum	1
2020002	TREE, REMOVE, 4ST TO 900 MM	ea	1
2040005	CURB, REMOVE	m	46
2040020	STRUCTURES, REMOVE	Lsum	1
2050010	EMBANKMENT, CIP	m ³	110
2060002	BACKFILL, STRUCTURE, CIP	m ³	400
2060011	EXCAVATION, FOUNDATION	m ³	500
2080025	EROSION CONTROL, SILT FENCE	m	210
3010002	SUBBASE, CIP	m ³	42
3020010	AGGREGATE BASE, 100 MM	m ²	556
3050001	BITUMINOUS BASE CRUSHING AND SHAPING	m ²	345
4017102	12.802 X 4267 PRECAST CONC THREE-SIDED BOX CULVERT	m	13
4040030	UNDERDRAIN, FOUNDATION, 100 mm	m	55
4040110	UNDERDRAIN, OUTLET ENDING, 100 mm	ea	2
6020206	CONCRETE PAVEMENT WITH INTEGRAL CURB (TYPE IIR), REINFORCED 240 MM	m ²	573
7040003	STEEL SHEET PILING, TEMP., LEFT IN PLACE	m ³	409
7060002	CONCRETE, GRADE 1	m ³	92
7060007	CONCRETE, GRADE 0	m ³	10
7060020	SUBSTRUCTURE CONCRETE	m ³	107
7060030	REINFORCEMENT, STEEL	kg	1748
7060031	CONCRETE, LOW TEMPERATURE PROTECTION	m ³	768
7060040	STRUCTURE NAME PLATE	ea	117
7110004	BRIDGE RAILING, SOLID PARAPET TYPE	m	2
7110007	BRIDGE RAILING, ONE TUBE	m	27
8030002	SIDEWALK, CONCRETE, 100 MM	m ²	33
8120036	BARRICADE, TYPE III, LIGHTER, FURN.	ea	4
8120037	BARRICADE, TYPE III, LIGHTER, OPER.	ea	3
8120041	CONCRETE BARRIER, TEMPORARY, FURNISHED	m	30.5
8120042	CONCRETE BARRIER, TEMPORARY, OPERATED	m	30.5
8120060	SIGN, TYPE B, TEMPORARY, PRISMATIC RETRIFLEC SHEETING	m ²	1
8130015	RIPRAP, HEAVY	m ²	66
8160003	WATER	KL	5
8160007	SEEDING, MIXTURE TUF	kg	4
8160020	FERTILIZER, CHEMICAL NUTRIENT, CLASS A	kg	5
8160072	MULCH ANCHORING	m ²	160
8160077	MULCH BLANKET	m ²	160

SUMMARY OF QUANTITIES

REVISIONS

DESIGN BY	CDP	12-97
DR'N BY	RJD	5-97
CK'D BY	RGW	5-97
FINAL CK'D BY	MDW	2-99
APP'D BY		

SNELL ENVIRONMENTAL GROUP, INC.
 151 W. CONGRESS, SUITE 528
 DETROIT, MICHIGAN 48226
 TELEPHONE (313) 961-4040

DETROIT
 MICHIGAN STATE UNIVERSITY
 FOR YOU

CITY OF DETROIT MICHIGAN

RIVERSIDE AVE. OVER CANAL (BW-242)

STEEL REINFORCEMENT AND QUANTITIES

SCALE NOT TO SCALE
 PROJECT NO. 9641-5160-01
 SHEET NO. RB OF 8

METRIC
 DIMENSIONS SHOWN IN METERS, METER-FRACTIONS, DECIMAL METERS, CURVE AND ALIGNMENT DATA ARE IN METERS. STATIONS ARE IN KILOMETERS + METERS.

UTILITIES

DETROIT EDISON
2000 SECOND AVE.
ROOM 607 G.O., DETROIT, MICHIGAN 48226
ATTN.: JOHN SOUTHERS
PHONE NO.: (313) 235-6597

AMERITECH
4000 ALLEN RD., ROOM 101
ALLEN PARK, MICHIGAN 48101
ATTN.: DAVE BUCIENSKI
PHONE NO.: (313) 389-9819

MICHIGAN CONSOLIDATED GAS CO.
DRAFTING CLERK
MAIN REPLACEMENT TEAM
NOBLE SECOND FLOOR
3200 HOBSON
DETROIT, MICHIGAN 48201
PHONE NO.: (313) 577-7236

CITY OF DETROIT WATER & SEWERAGE DEPARTMENT
735 RANDOLPH ST.
DETROIT, MICHIGAN 48226
PHONE NO.: (313) 224-4800

CITY OF DETROIT PUBLIC LIGHTING DEPARTMENT
9449 GRINNEL
DETROIT, MICHIGAN 48226
PHONE NO.: (313) 267-7336

EXISTING STRUCTURE

ONE - SPAN REINFORCED CONCRETE ARCH STRUCTURE MEASURING 12.80 METERS REFERENCE LINE TO REFERENCE LINE. BUILT IN 1909, 9144 mm CLEAR ROADWAY.

STA 9+975 TO STA 9+989
REMOVE 15 m CURB
STA 9+975 TO STA 9+993.243
PLACE 20 m TYPE I.I.I.R. INTEGRAL CURB

BENCH MARK

B.M. #62-258
MONUMENT BOX IN SIDEWALK, NORTHEAST QUADRANT OF JEFFERSON AVE. AND CHALMERS

B.M. #62-255A
MONUMENT BOX IN SIDEWALK, NORTHEAST QUADRANT OF FRED AND CHALMERS

PROPOSED REPLACEMENT RIVERSIDE AVE. BRIDGE
MOOT - B01 OF 1038
CITY - BW-242







EXISTING STRUCTURE TO BE REMOVED

DRIVEWAYS TO BE PAVED TO PROVIDE A SMOOTH TRANSITION BETWEEN PROPOSED PAVEMENT AND EXISTING DRIVEWAY AS DIRECTED BY ENGINEER. INCLUDED IN PAY ITEM "CONCRETE PAVEMENT".

WITNESSES

WITNESS TO SURVEY STA. 9+900 (MAG NAIL)
N 60° W 10.766 m
N 20° W 9.372 m
S 10° W 16.278 m

WITNESS TO SURVEY STA. 10+100 (PK SET)
N 70° W 11.950 m
S 80° E 33.000 m
N 15° W 18.530 m

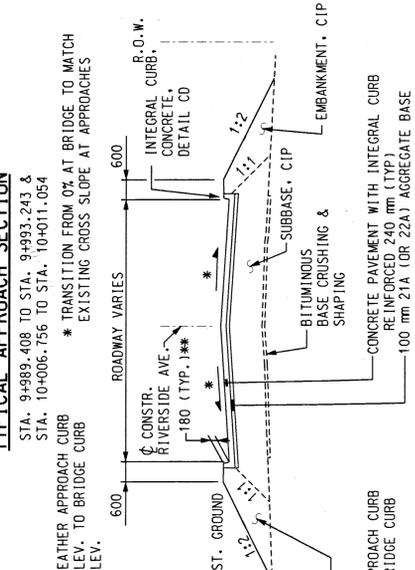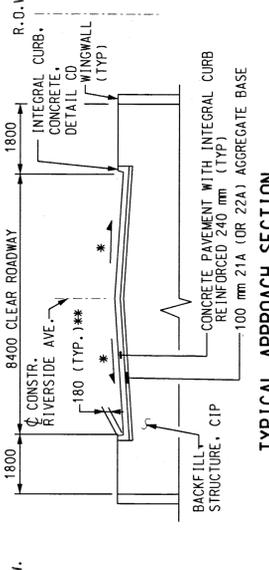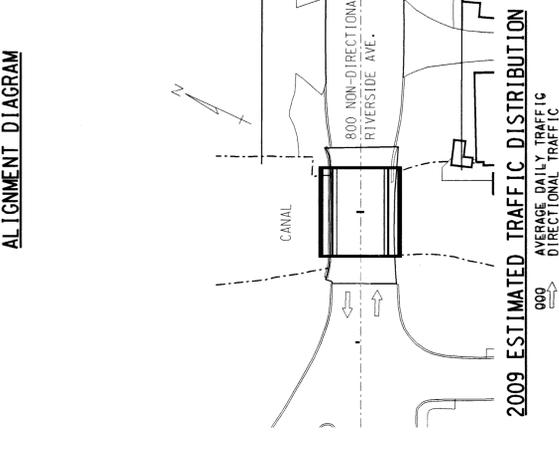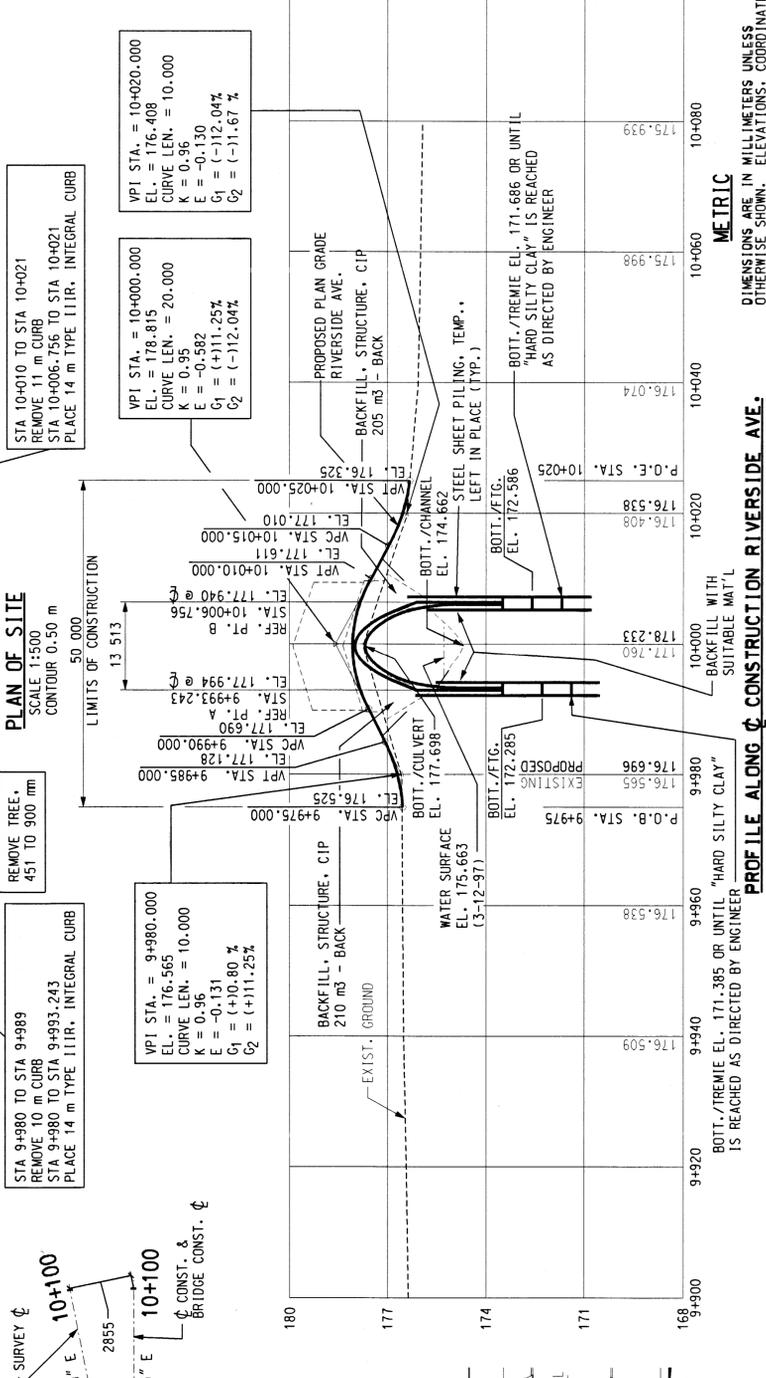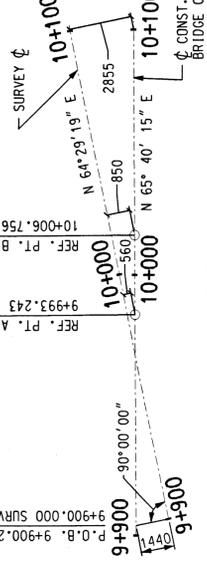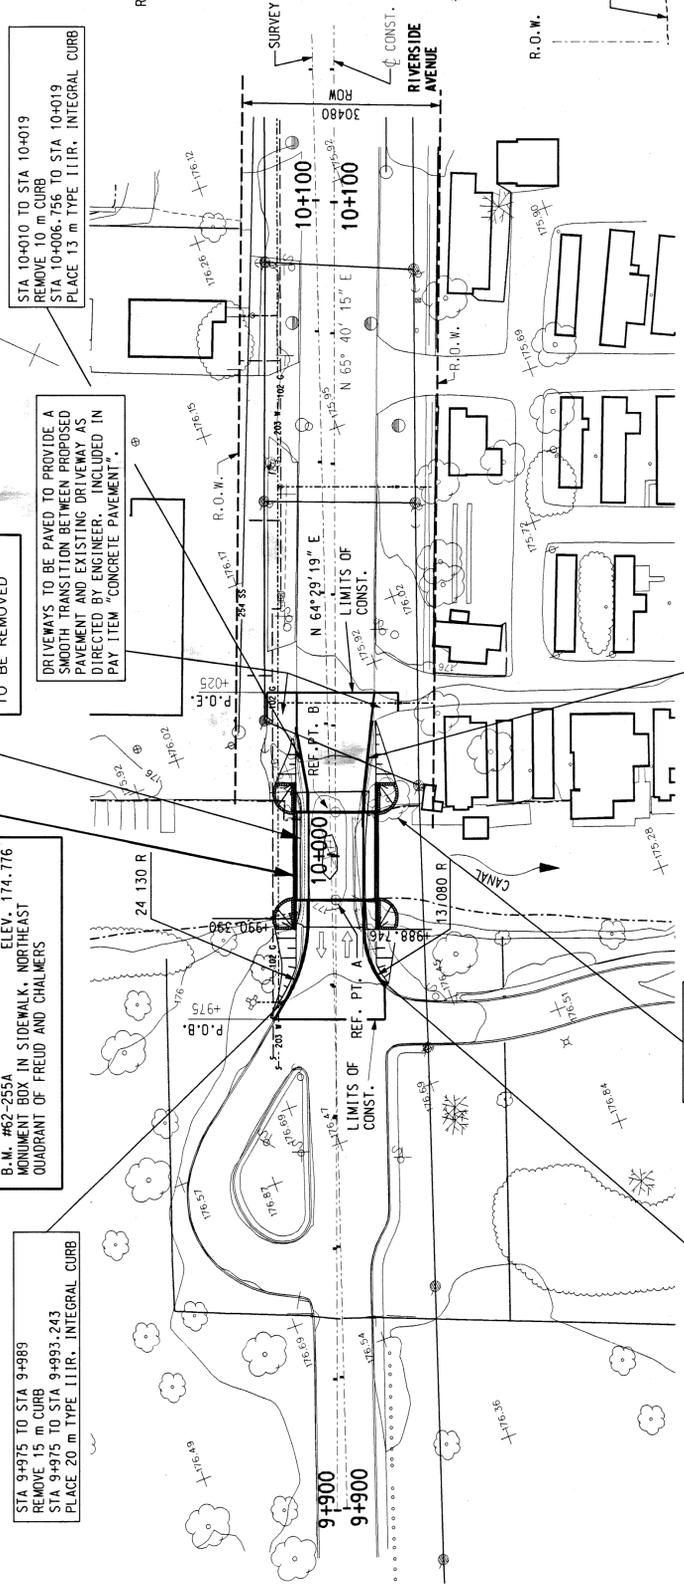

NOTES:

THE WORK COVERED BY THESE PLANS INCLUDES REMOVAL OF EXISTING BRIDGE, CONSTRUCTION OF THE PROPOSED BRIDGE, PLACING RIPRAP AND APPROACH WORK.

THE CONTRACTOR SHALL LOCATE ALL ACTIVE UNDERGROUND UTILITIES PRIOR TO STARTING WORK AND SHALL CONDUCT HIS OPERATIONS IN SUCH A MANNER AS TO ENSURE THAT THOSE UTILITIES NOT REQUIRING RELOCATION WILL NOT BE DISTURBED.

RIVERSIDE AVE. WILL BE CLOSED TO THRU TRAFFIC FOR THE PROJECT DURATION.

DATUM REFERS TO N.A.V.D. DATUM.



WATER LEVEL IS SUBJECT TO CHANGE. THE CONTRACTOR IS RESPONSIBLE FOR MAKING HIS OWN DETERMINATION OF WATER LEVELS THAT WILL EXIST DURING CONSTRUCTION.

MEASURES SHALL BE TAKEN TO PREVENT DEBRIS FROM FALLING FROM THE STRUCTURE. IF DEBRIS FALLS INTO THE WATERWAY, IT SHALL BE REMOVED WITHIN 24 HOURS. SINCE DISTURBANCE OF THE WATERWAY BOTTOM MAY BE AS HARMFUL AS THE DEBRIS ITSELF, THE PREVENTIVE MEASURES MUST BE MADE AS EFFECTIVE AS POSSIBLE. DEBRIS WHICH HAS PREVIOUSLY FALLEN FROM THE BRIDGE SHALL ALSO BE REMOVED AS DIRECTED BY THE ENGINEER.


TEMPORARILY STORED EXCAVATED MATERIAL SHALL NOT BE ALLOWED TO ERODE INTO THE WATERCOURSE. PRIOR TO PLACEMENT OF THE TREMIE SEAL, WATER PUMPED FROM THE "TEMPORARY STEEL SHEET PILING, TEMP. LEFT IN PLACE" SHALL BE DISCHARGED INTO A GEOTEXTILE FILTER BAG. AFTER TREMIE SEAL PLACEMENT, AND WHERE PERMITTED BY THE ENGINEER, PUMPS MAY OUTLET DIRECTLY INTO THE RIVER.

ALL DISTURBED EXISTING GROUND AND ANY NEW FILL SLOPES SHALL BE SEED, FERTILIZED, AND MULCHED AS DIRECTED BY THE ENGINEER. TO BE INCLUDED IN THE PAY ITEMS "SEEDING, MIXTURE TYP.", "FERTILIZER, CHEMICAL NUTRIENT, CLASS A," AND "MULCH BLANKET."

REVISIONS		CITY OF DETROIT MICHIGAN		RIVERSIDE AVE. OVER CANAL (BW-242)		GENERAL PLAN OF SITE	
DSGN BY	C.D.P.	12-97	SNELL ENVIRONMENTAL GROUP, INC.	SCALE	NOT TO SCALE	PROJECT NO.	9641-5160-01
DR'N BY	R.J.D.	5-97	DETROIT	SHEET		SHEET	19 OF 19
CK'D BY	R.G.W.	5-97	DETROIT				
FINAL CK'D BY	M.D.W.	2-99	DETROIT				
APP'D BY			DETROIT				

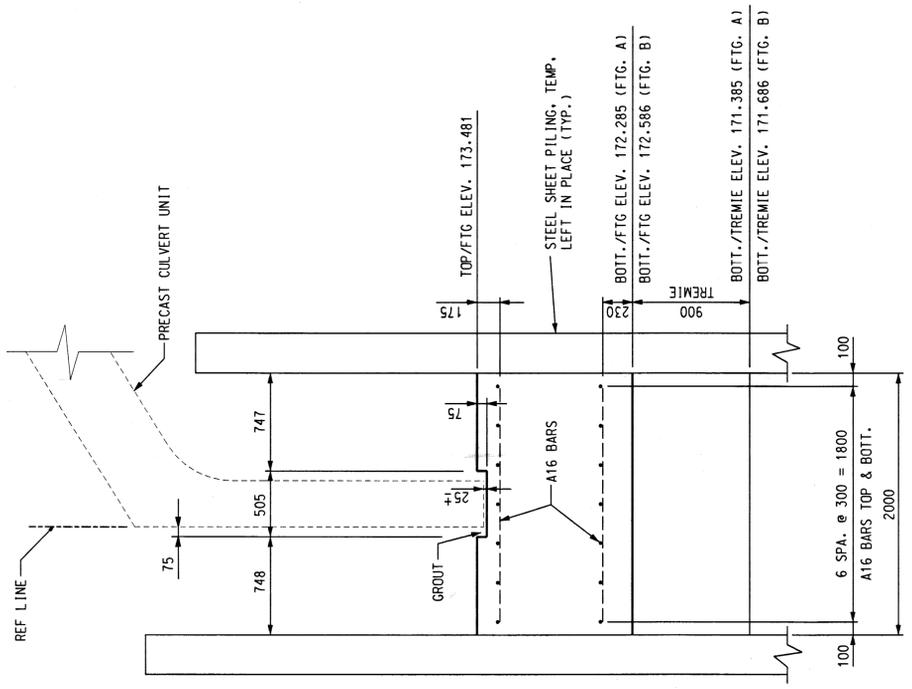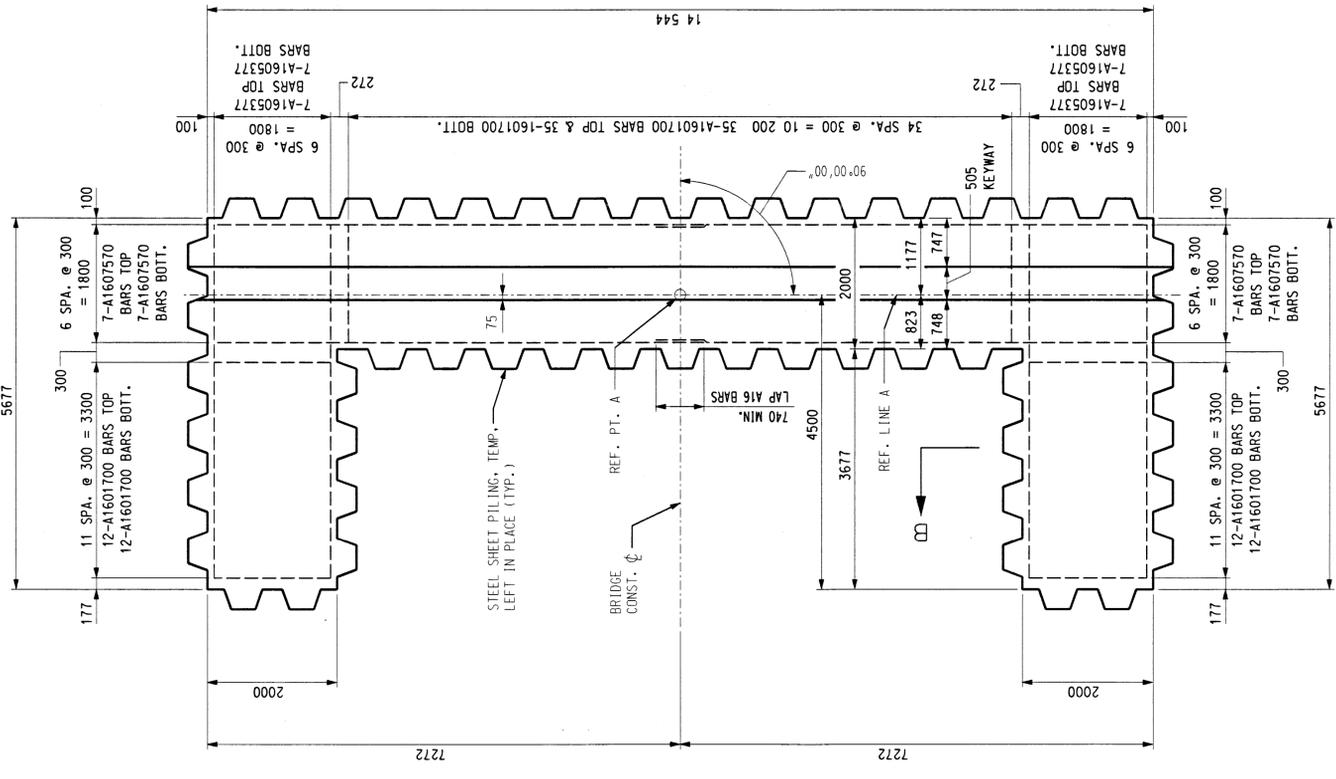

SECTION A-A

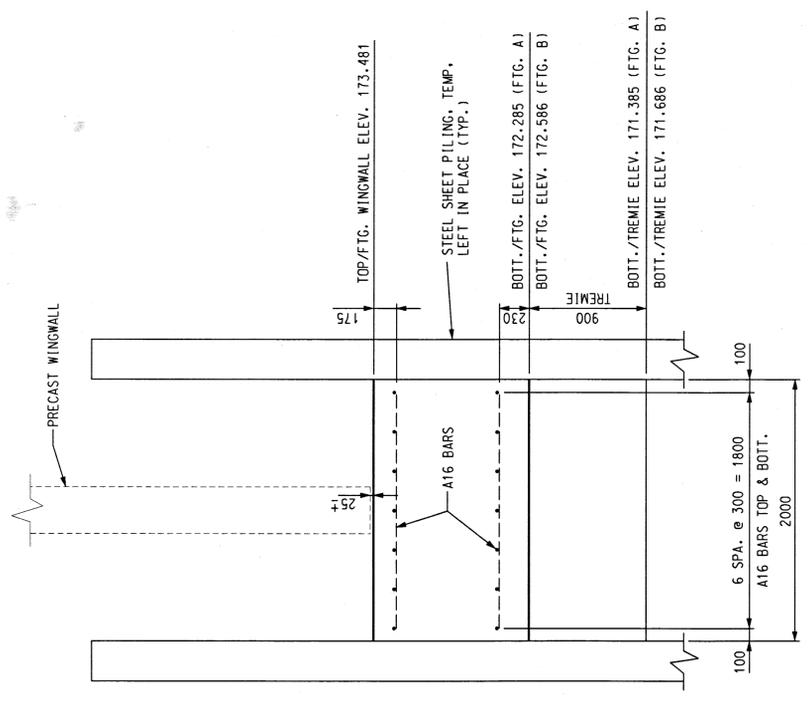

SECTION B-B

PLAN OF FOOTING LAYOUT
(ABUTMENT A SHOWN ABUTMENT B OPPOSITE HAND)

METRIC
DIMENSIONS ARE IN MILLIMETERS UNLESS OTHERWISE SHOWN. ELEVATIONS, COORDINATES, CURVE AND ALIGNMENT DATA ARE IN METERS. STATIONS ARE IN KILOMETERS + METERS.

SCALE	NOT TO SCALE
PROJECT NO.	9641-5160-01
SHEET NO.	R5 OF 19

FOOTING DETAILS

RIVERSIDE AVE
OVER CANAL
(BW-242)

CITY OF DETROIT
MICHIGAN



SNELL ENVIRONMENTAL GROUP, INC. A DLZ Company
CONSULTING ENGINEERS
DETROIT, MICHIGAN 48226
TELEPHONE (313) 961-4040



DESIGN BY	C.D.P.	12-97
DR'N BY	R.J.D.	5-97
CK'D BY	R.G.W.	5-97
FINAL CK'D BY	M.D.W.	2-99
APP'D BY		

REVISIONS	

BAR	DIMENSIONS											NO. RECD	TOTAL MASS	
	a	b	c	d	e	f	g	h	j	k	m			
A1601700	1700												236	623
A1605377	5377												56	467
A1607570	7570												56	658
SUBTOTAL = 1748 kg														
EA1301650	1650												88	144
EA1304435	4435												40	176
EA1313360	13360												12	159
ED1902018*	940	138	940										64	289
EPOXY SUBTOTAL = 768 kg														


* SHALL BE CAST IN PRECAST CULVERT HEADWALL.

REINFORCEMENT SHALL BE BUNDLED AND TAGGED AS TO THE LOCATION AS SHOWN ON THIS SHEET.


ALL BENDS IN REINFORCING STEEL TO BE MADE ABOUT A P IN OF THE MINIMUM DIAMETER ALLOWED BY THE STANDARD SPECIFICATIONS.

TOLERANCES IN CUTTING AND BENDING BARS ARE AS ESTABLISHED IN THE MANUAL OF STANDARD PRACTICE OF THE CONCRETE REINFORCING STEEL INSTITUTE AND DETAILING MANUAL OF THE AMERICAN CONCRETE INSTITUTE.

WHERE FIELD CUTTING OF EPOXY BARS IS REQUIRED, THE CONTRACTOR SHALL REPAIR THE EPOXY COATING AT THE CUT END AS PROVIDED FOR IN STANDARD SPECIFICATION 706.03.E.8.

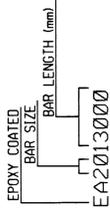

BAR LEGEND

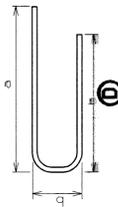

SUMMARY OF QUANTITIES

ITEM NO.	ITEM DESCRIPTION	UNIT	QUANTITY
1500000	MOBILIZATION, MAX.	Lsum	1
2020002	TREE, REMOVE, 4ST TO 900 mm	ea	1
2040005	CURB, REMOVE	m	46
2040020	STRUCTURES, REMOVE	Lsum	1
2050010	EMBANKMENT, CIP	m ³	110
2060002	BACKFILL, STRUCTURE, CIP	m ³	400
2060011	EXCAVATION, FOUNDATION	m ³	500
2080025	EROSION CONTROL, SILT FENCE	m	210
3010002	SUBBASE, CIP	m ²	42
3020010	AGGREGATE BASE, 100 mm	m ²	556
3050001	BITUMINOUS BASE CRUSHING AND SHAPING	m ²	345
4017102	12.802 X 4267 PRECAST CONC THREE-SIDED BOX CULVERT	m	13
4040030	UNDERDRAIN, FOUNDATION, 100 mm	m	55
4040110	UNDERDRAIN, OUTLET ENDING, 100 mm	ea	2
6020206	CONCRETE PAVEMENT WITH INTEGRAL CURB (TYPE IIR), REINFORCED 240 mm	m ²	573
7040003	STEEL SHEET PILING, TEMP., LEFT IN PLACE	m ²	409
7060002	CONCRETE, GRADE I	m ³	92
7060007	CONCRETE, GRADE D	m ³	10
7060020	SUBSTRUCTURE CONCRETE	m ³	107
7060030	REINFORCEMENT, STEEL	kg	1748
7060031	REINFORCEMENT, STEEL, EPOXY COATED	kg	768
7060040	CONCRETE, LOW TEMPERATURE PROTECTION	m ³	117
7060250	STRUCTURE NAME PLATE	ea	2
7110004	BRIDGE RAILING, SOLID PARAPET TYPE	m	27
7110007	BRIDGE RAILING, ONE TUBE	m	27
8030002	SIDEWALK, CONCRETE, 100 mm	m ²	33
8120036	BARRICADE, TYPE III, LIGHTED, FURN.	ea	4
8120037	BARRICADE, TYPE III, LIGHTED, OPER.	ea	3
8120041	CONCRETE BARRIER, TEMPORARY, FURNISHED	m	30.5
8120042	CONCRETE BARRIER, TEMPORARY, OPERATED	m	30.5
8120060	SIGN, TYPE B TEMPORARY, PRISMATIC RETRIFLEC SHEETING	m ²	1
8130015	RIPRAP, HEAVY	m ²	66
8160003	WATER	KL	5
8160007	SEEDING, MIXTURE TUF	kg	4
8160020	FERTILIZER, CHEMICAL NUTRIENT, CLASS A	kg	5
8160072	MULCH ANCHORING	m ²	160
8160077	MULCH BLANKET	m ²	160

METRIC

DIMENSIONS ARE IN METERS UNLESS OTHERWISE SHOWN. ELEVATIONS, COORDINATES, CURVE AND ALIGNMENT DATA ARE IN METERS. STATIONS ARE IN KILOMETERS + METERS.

SCALE NOT TO SCALE
PROJECT NO. 9641-5160-01
SHEET NO. RB OF 19

STEEL REINFORCEMENT AND QUANTITIES

RIVERSIDE AVE. OVER CANAL (BW-242)

CITY OF DETROIT MICHIGAN



SNELL ENVIRONMENTAL GROUP, INC. A DLZ Company
151 W. CONGRESS, SUITE 328
DETROIT, MICHIGAN 48226
TELEPHONE (313) 967-4000



DESIGN BY	CDP	12-97
DR'N BY	RJD	5-97
CK'D BY	RGW	5-97
FINAL CK'D BY	MDW	2-99
APP'D BY		

REVISIONS