


# Promenade Rehabilitation Belle Isle Park

## Phase A

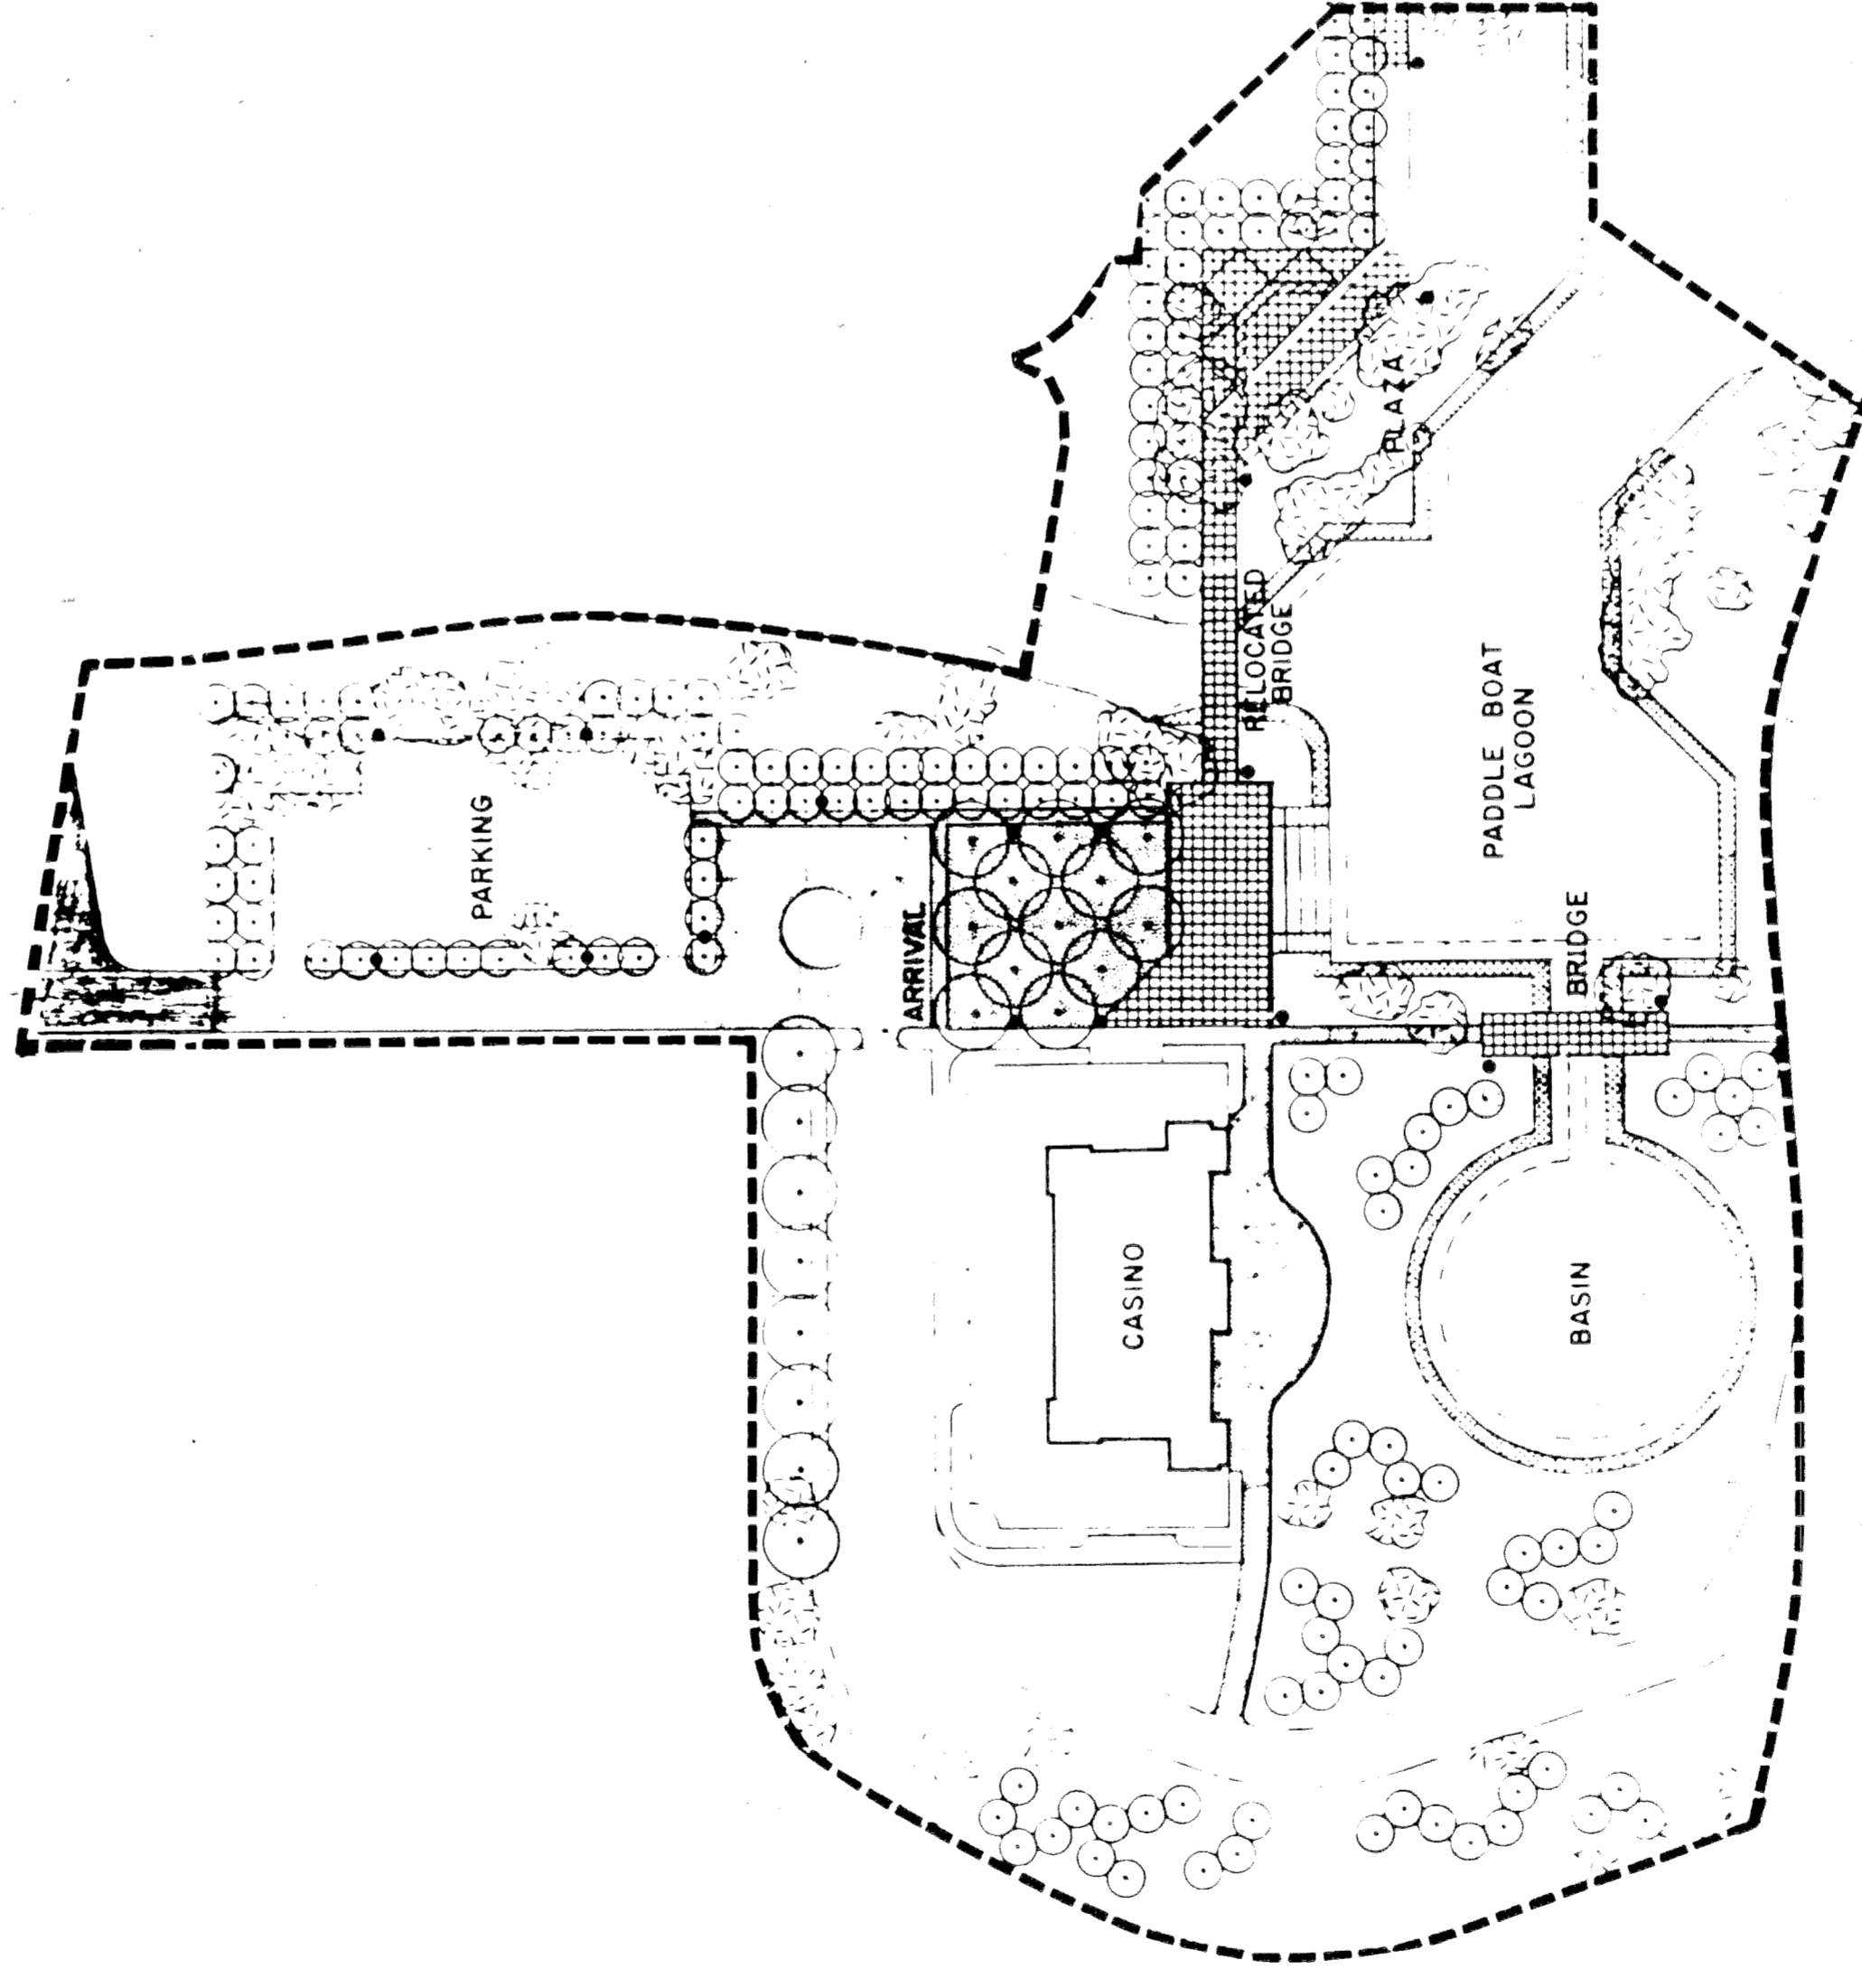

Sheet Schedule	
SHEET NO.	DESCRIPTION
	TITLE SHEET
D-1	DEMOLITION
C-1	SITE PLAN
C-2	PARKING AREA
C-3	PLAN & PROFILE - BRIDGE NO. 2
C-4	PLAN & PROFILE - BRIDGE NO. 1
C-5	PADDLE BOAT LAGOON
C-6	DETAILS
S-1	STEPS DETAILS
S-2	GENERAL DRAWING - BRIDGE NO. 2
S-3	ABUTMENT DETAILS - BRIDGE NO. 2
S-4	GENERAL DRAWING - BRIDGE NO. 1
S-5	ABUTMENT DETAILS - BRIDGE NO. 1
S-6	TRELLIS DETAILS
M-1	MECHANICAL
M-2	MECHANICAL DETAILS
E-1	ELECTRICAL
E-2	ELECTRICAL DETAILS
L-1	PLANTING

Recreation Department  
Coleman A. Young, Mayor


City of Detroit

Kiley-Walker  
Sidney E. Shorter & Assoc.



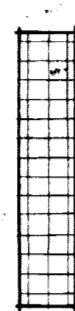

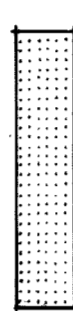

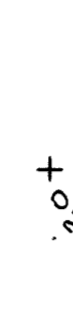
Landscape Architects  
Engineers



SCALE: 1" = 50'

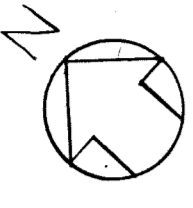


LEGEND

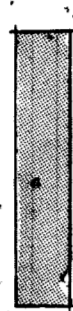-  NEW BITUMINOUS PAVING
-  GRASS PAVING BLOCKS
-  PRECAST CONCRETE PAVERS
-  NEW CONCRETE WALKWAY
-  GRAVEL
-  INTERLOCKING CONCRETE RIPRAP
-  FINISH GRADE ELEVATION

GENERAL NOTES

TOP OF ALL MANHOLES SHALL BE ADJUSTED TO MATCH FINISH GRADE ELEVATIONS.

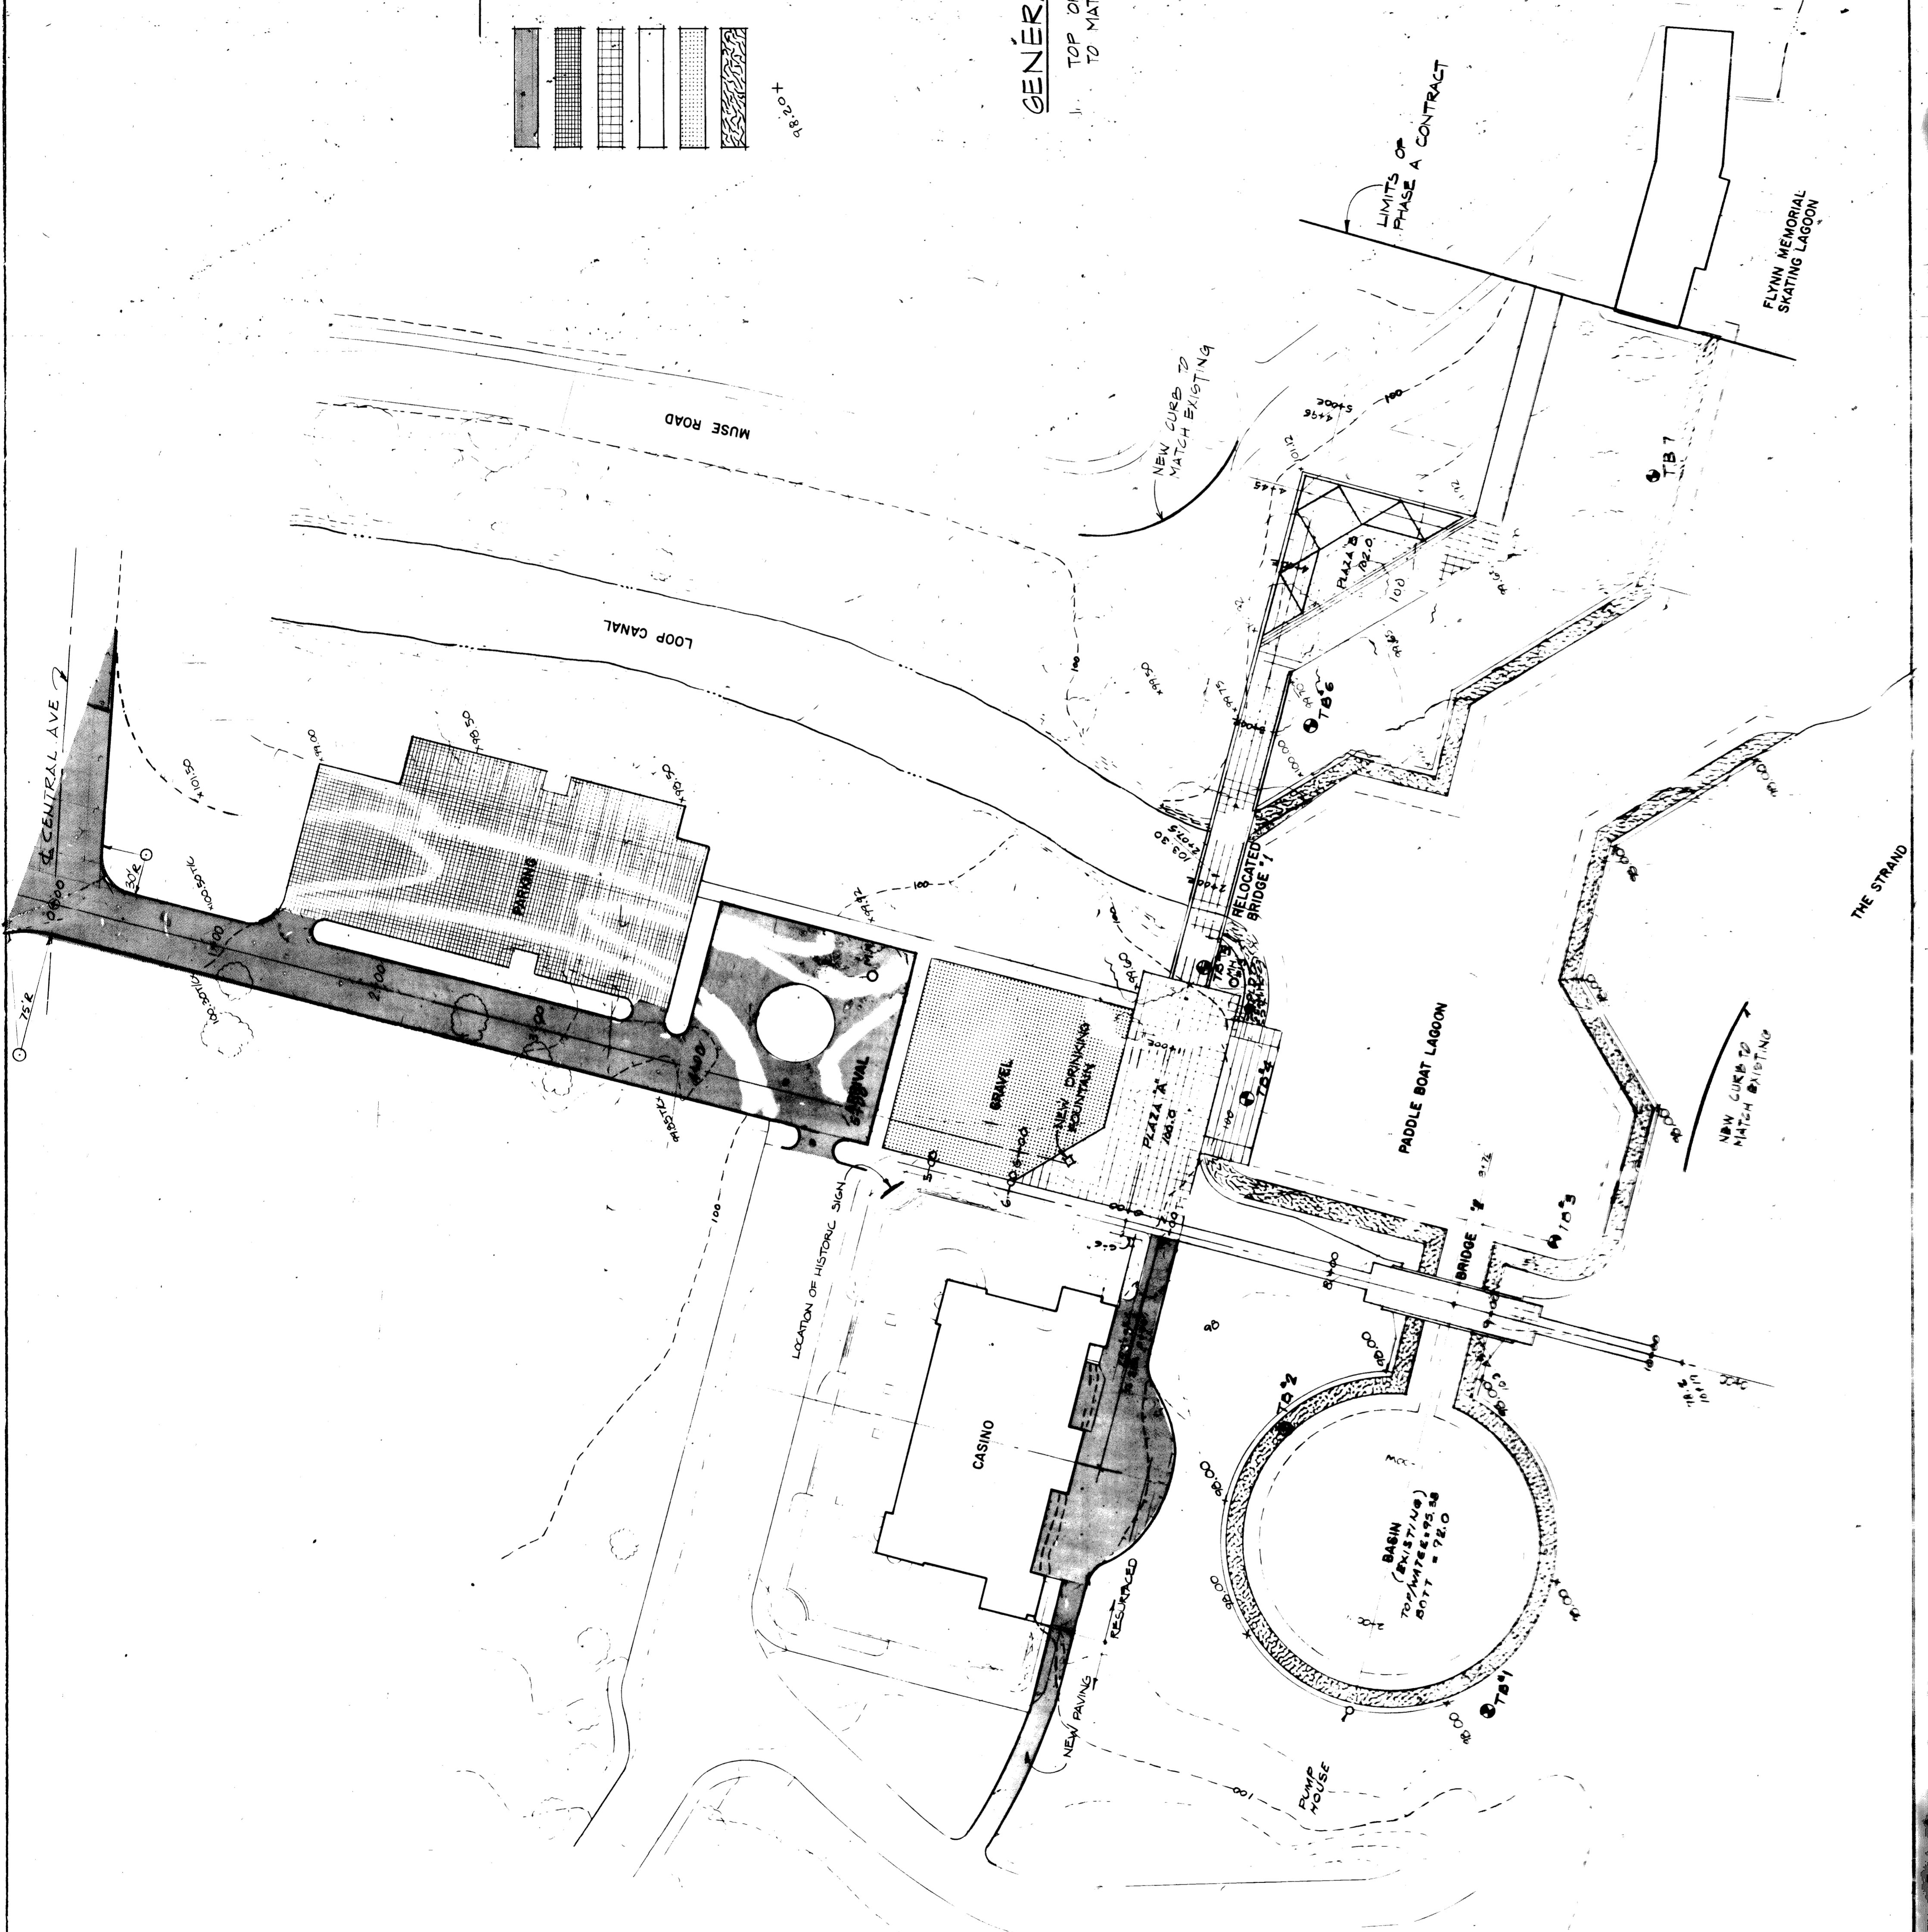













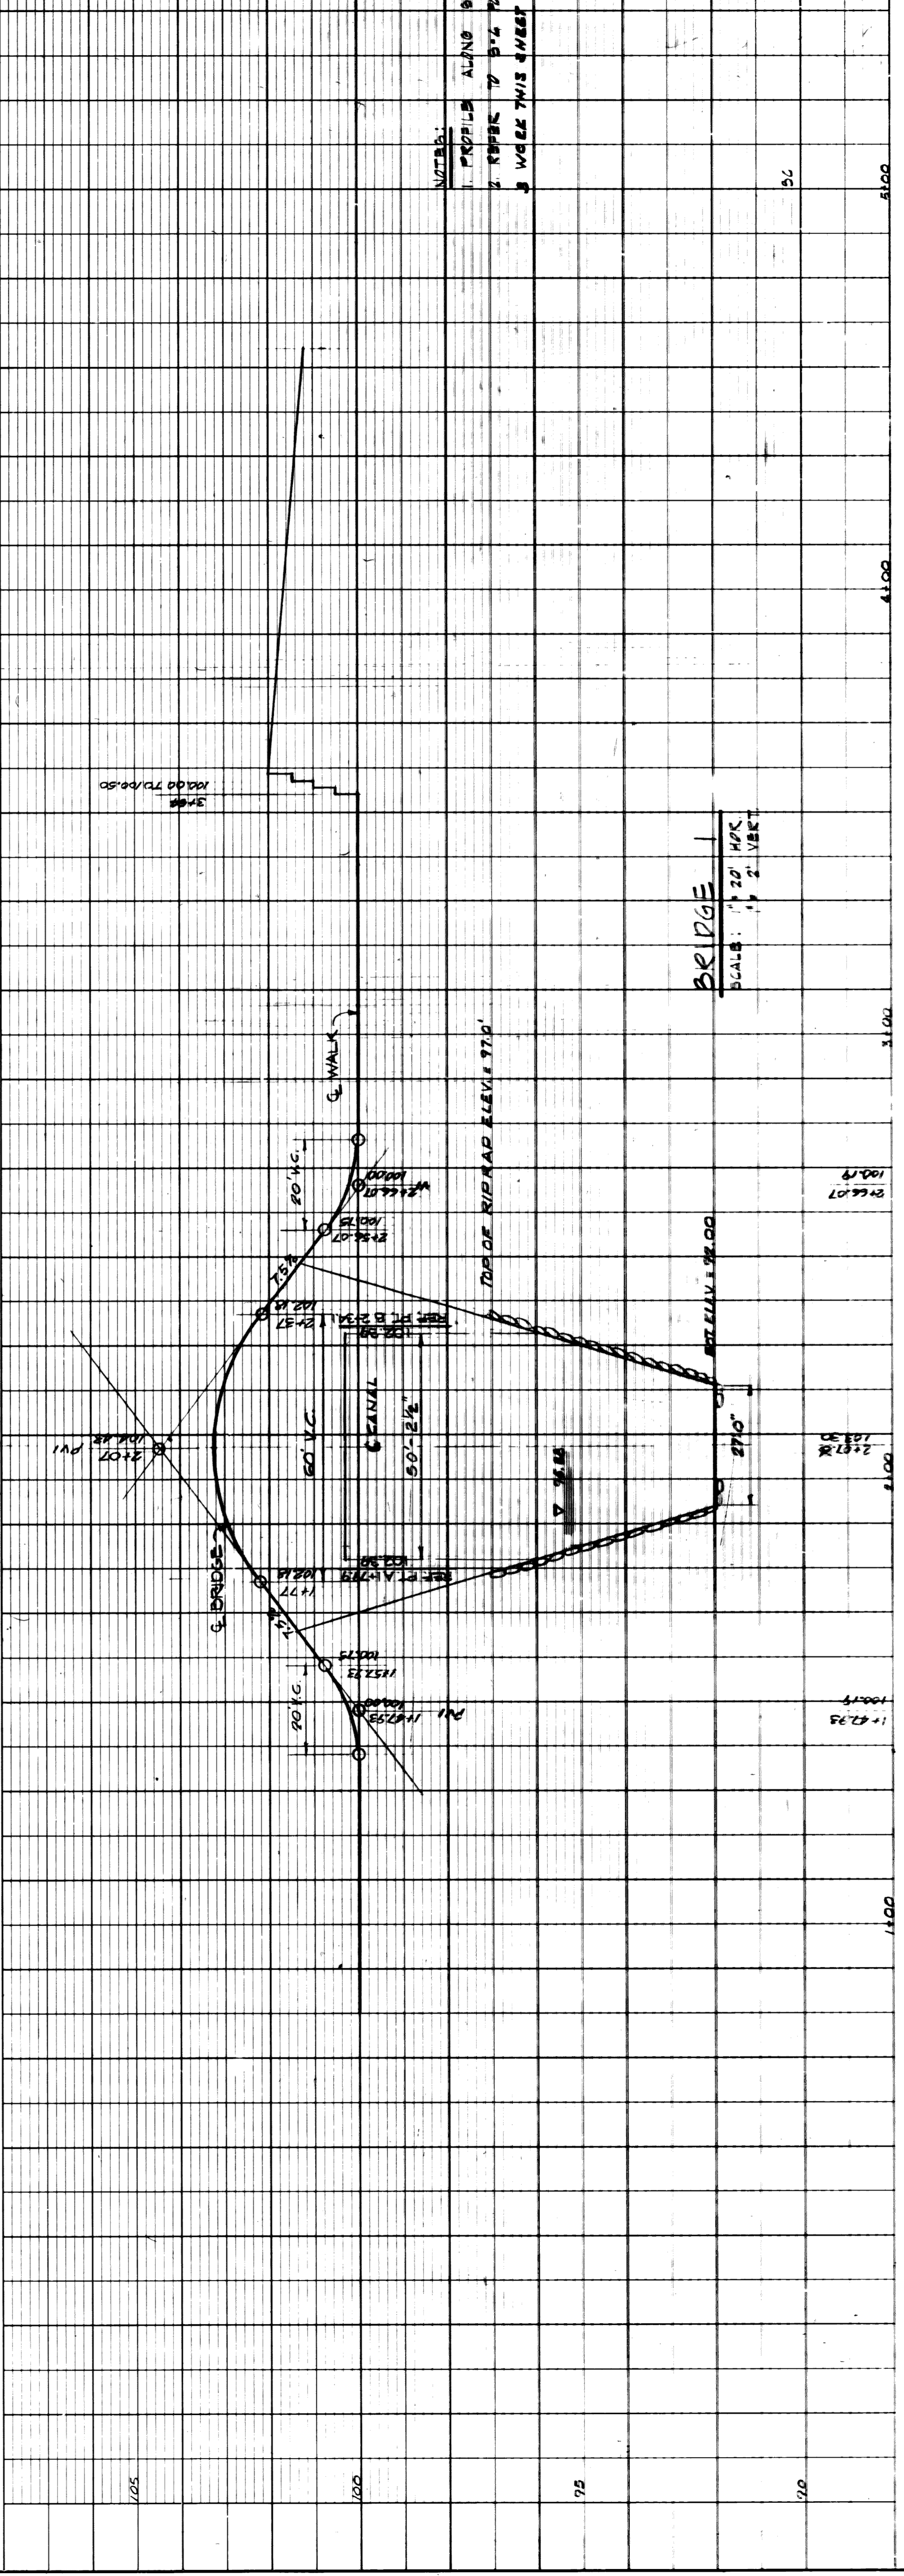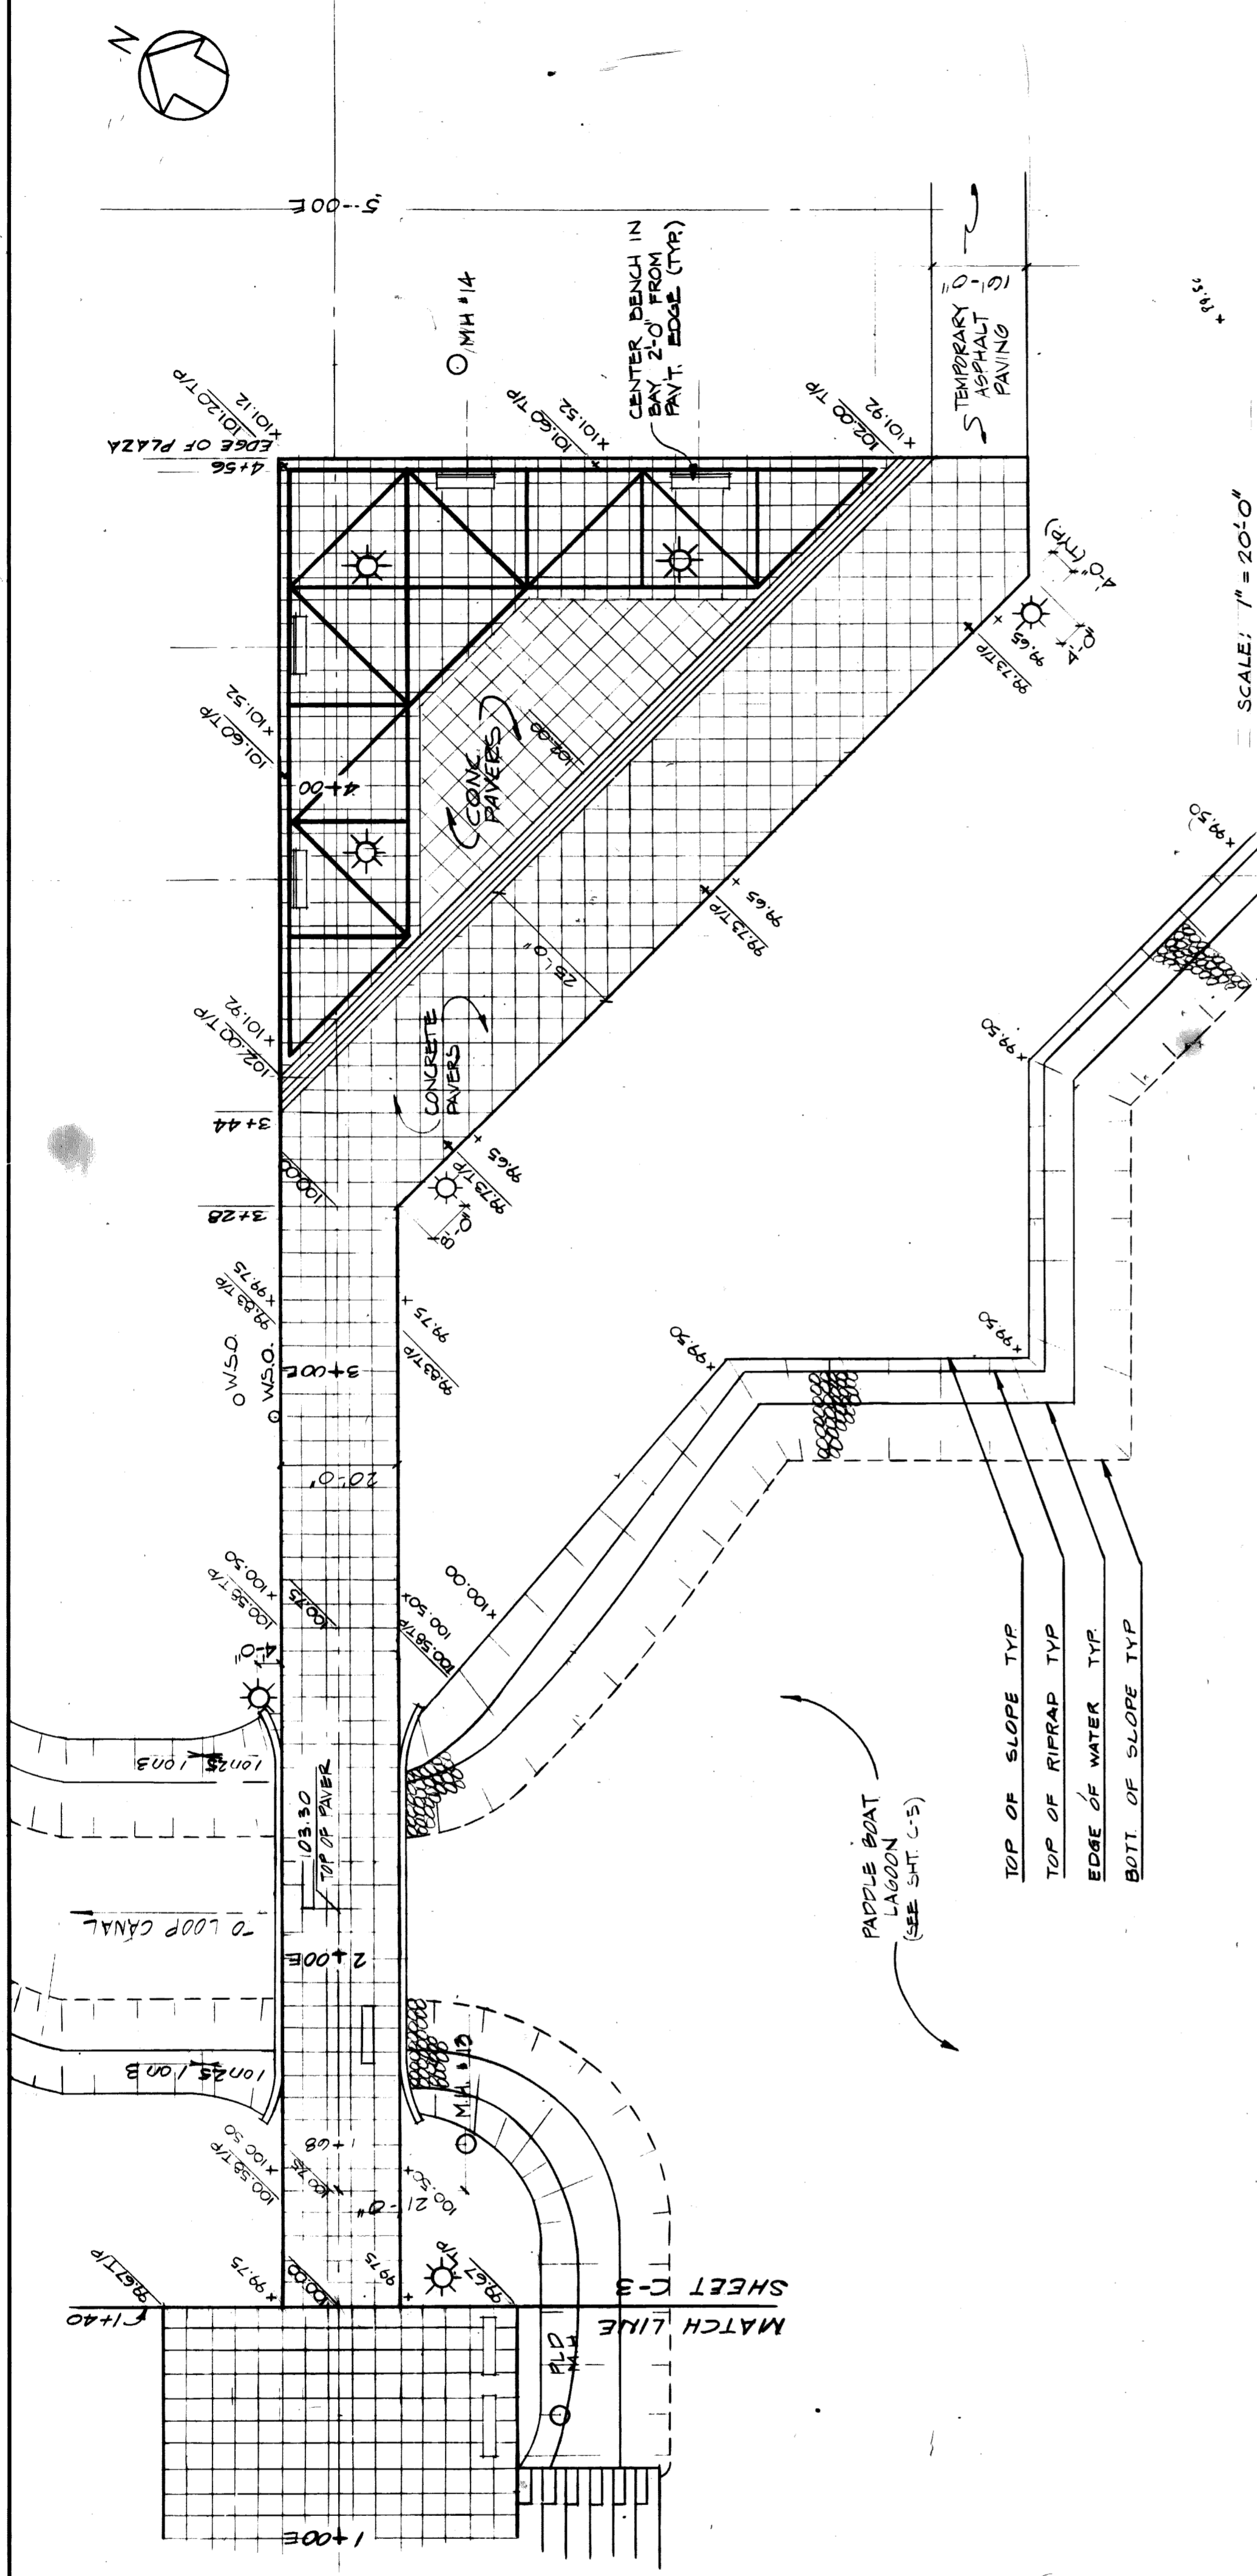

- NOTES:
1. PROFILE ALONG STATION LINE.
  2. REFER TO 5'-6" FOR BRIDGE DETAILS.
  3. WALK THIS SHEET WITH SHEET C-5.

PLAN	
DATE	BY
REVISIONS	
NO. OF WAY CHECKED	
ALIGNMENT CHECKED	
NOTE BOOK	
NO. OF WAY CHECKED	

PROFILE	
DATE	BY
REVISIONS	
STRUCTURE NOTATIONS CHECKED	
NO. OF WAY CHECKED	
ALIGNMENT CHECKED	
NOTE BOOK	
NO. OF WAY CHECKED	




















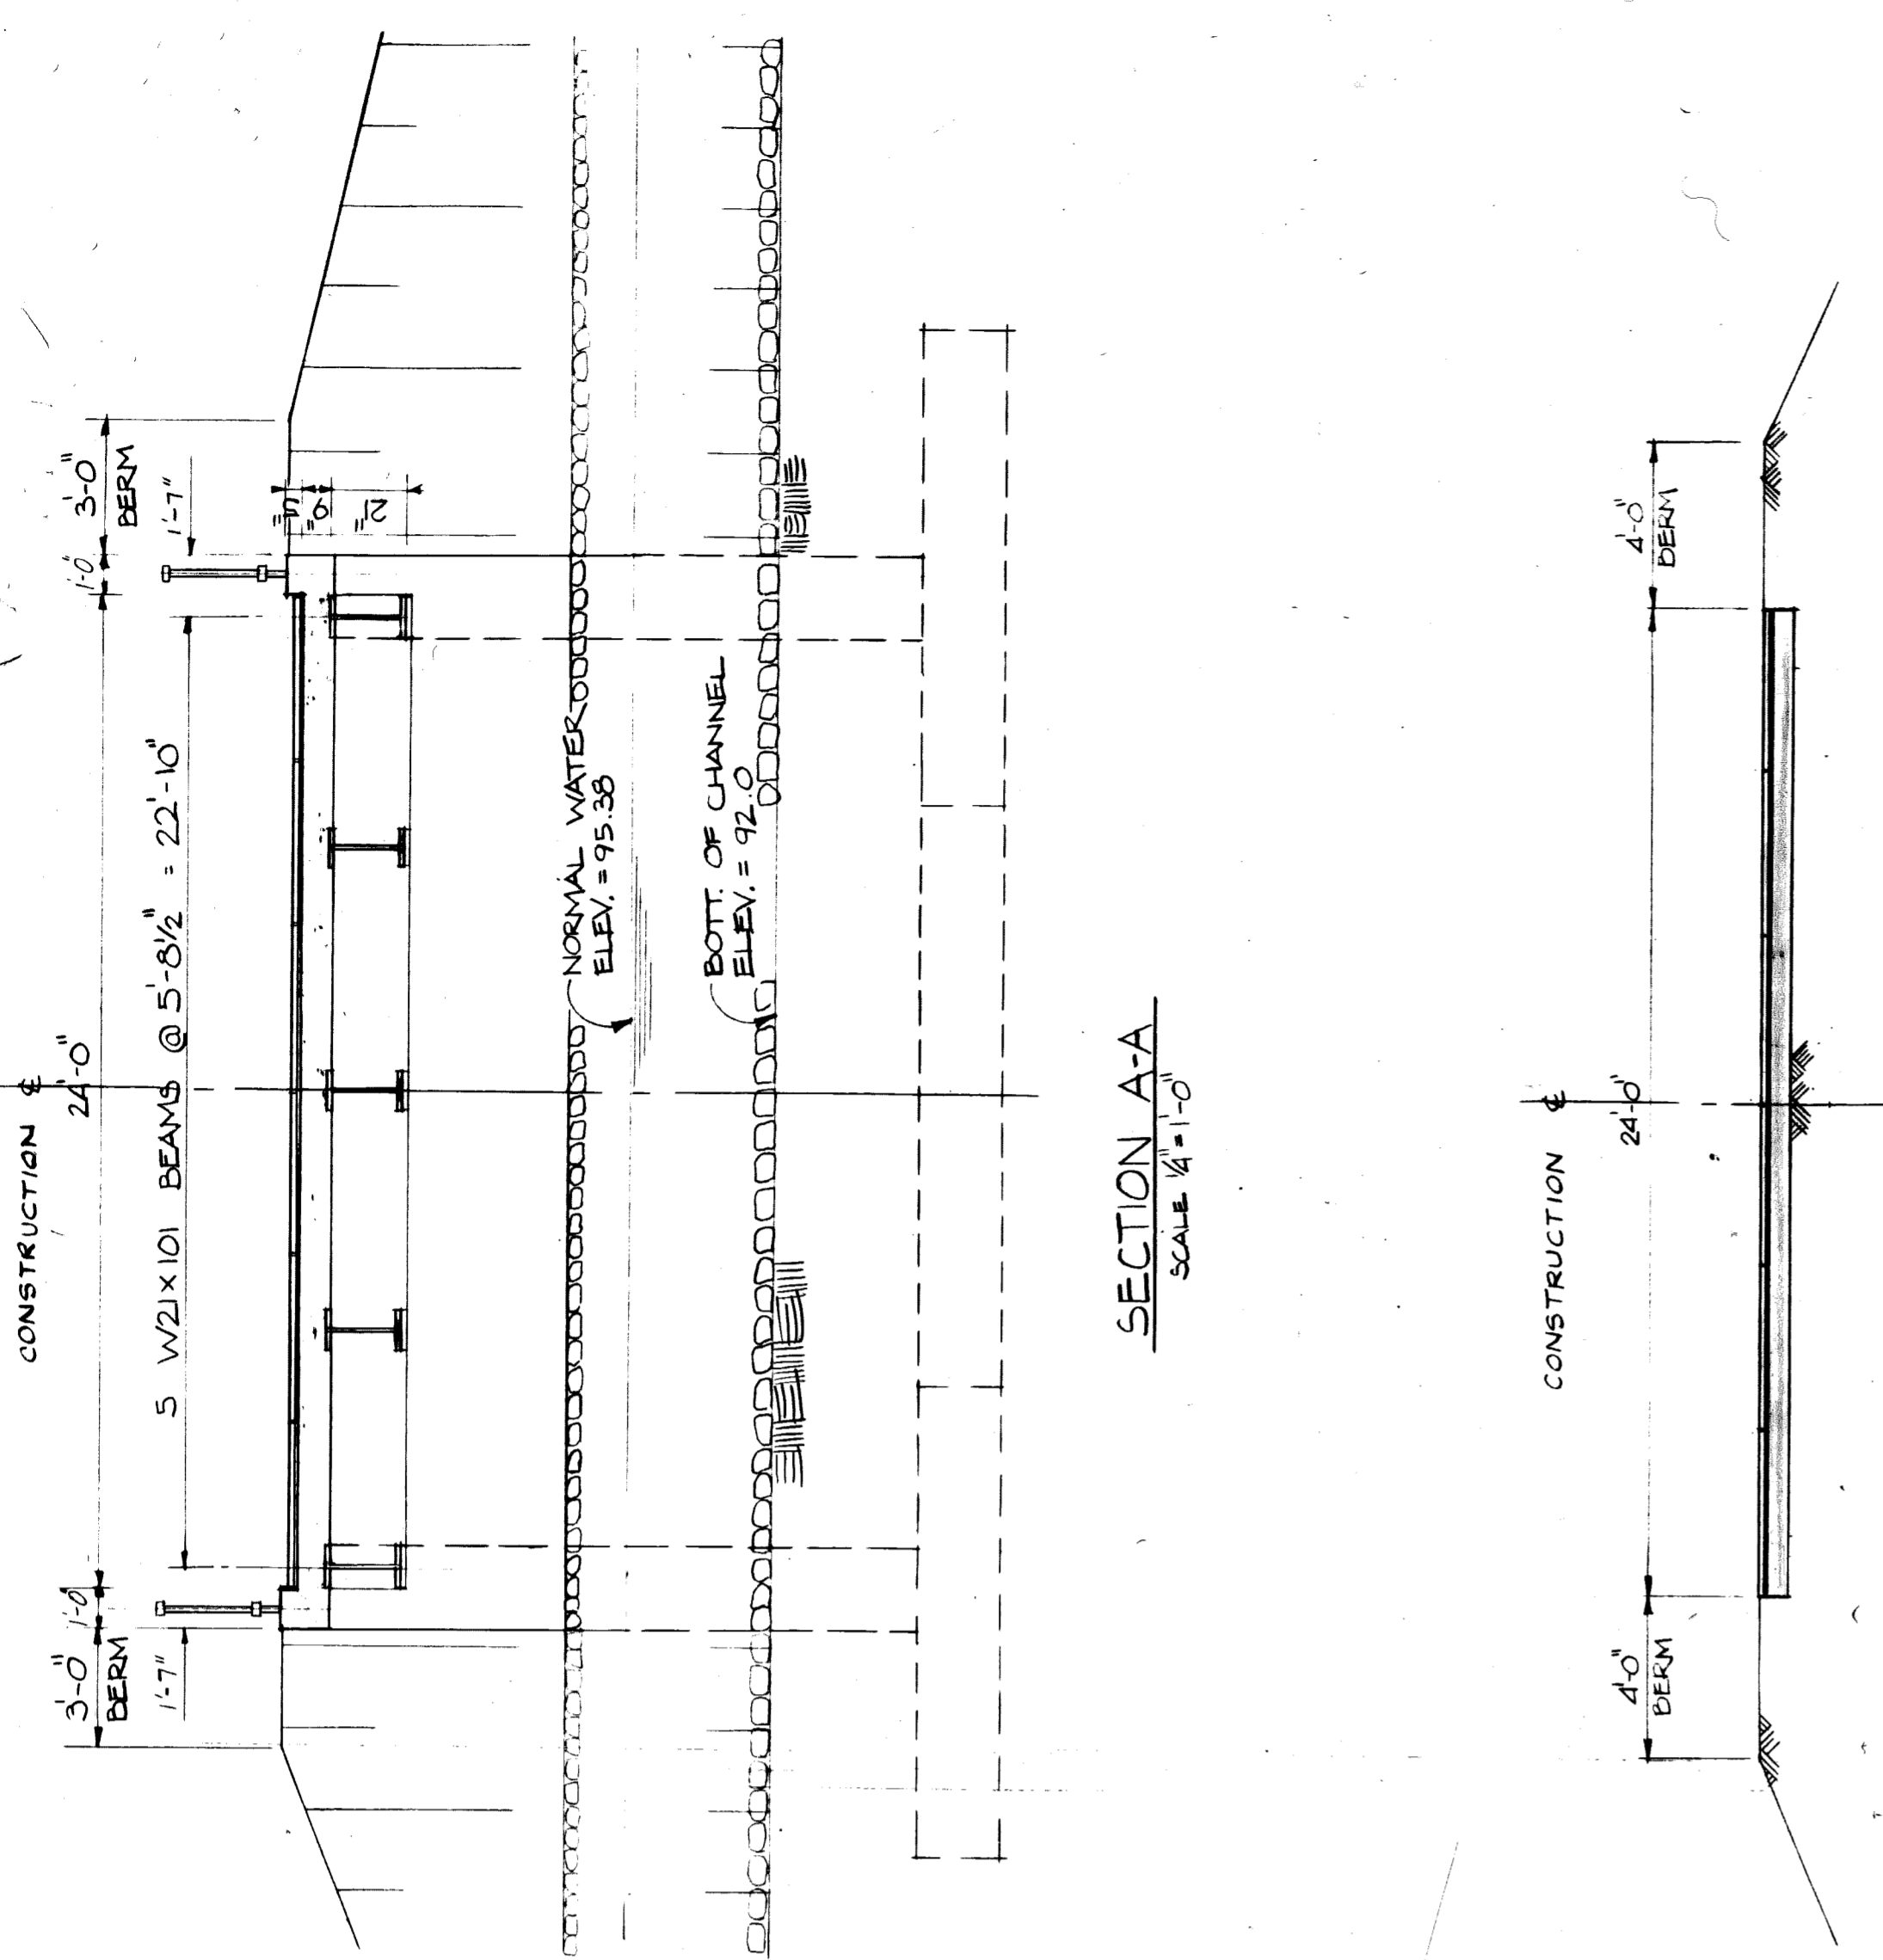


TYPICAL APPROACH SECTION  
SCALE 1/4"=1'-0"  
NOTE:  
SEE PRECAST CONCRETE PAVING SECTION SHT. C-2.

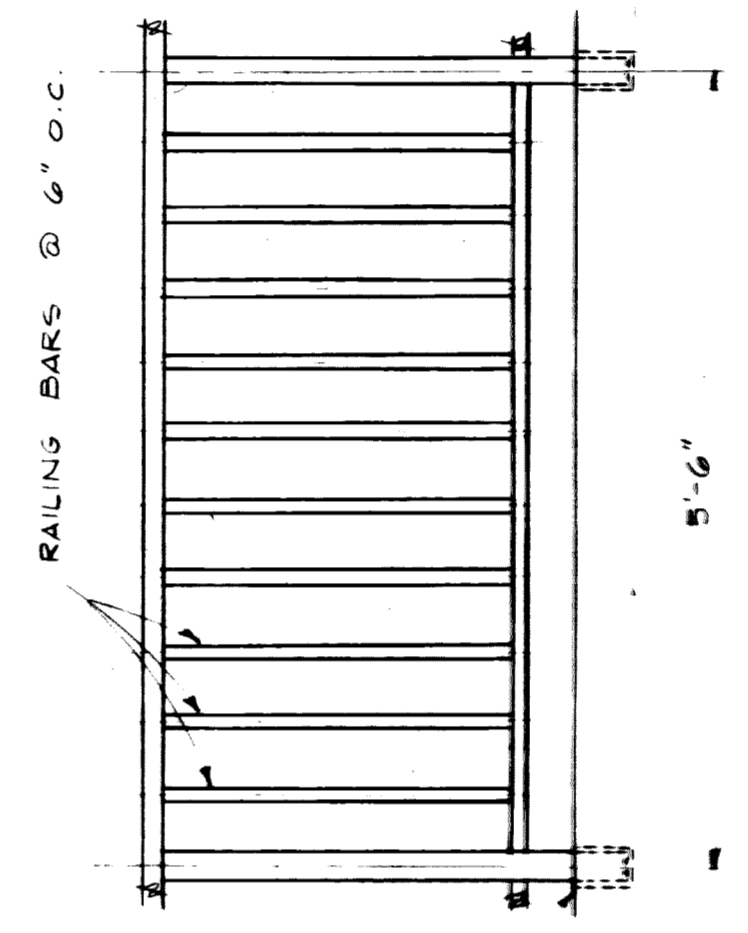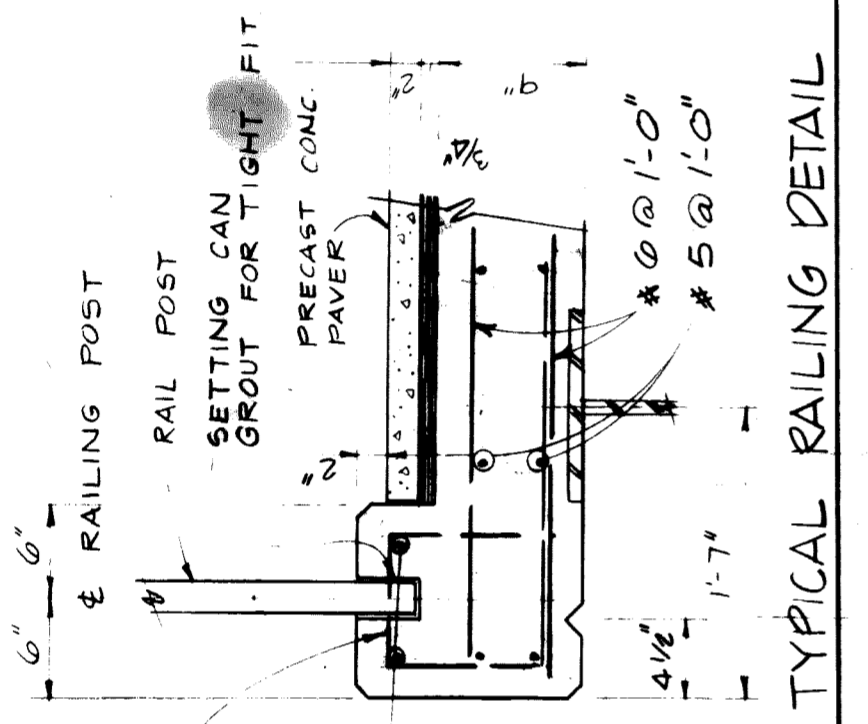

WORK THIS SHEET W/ SHT. C-3

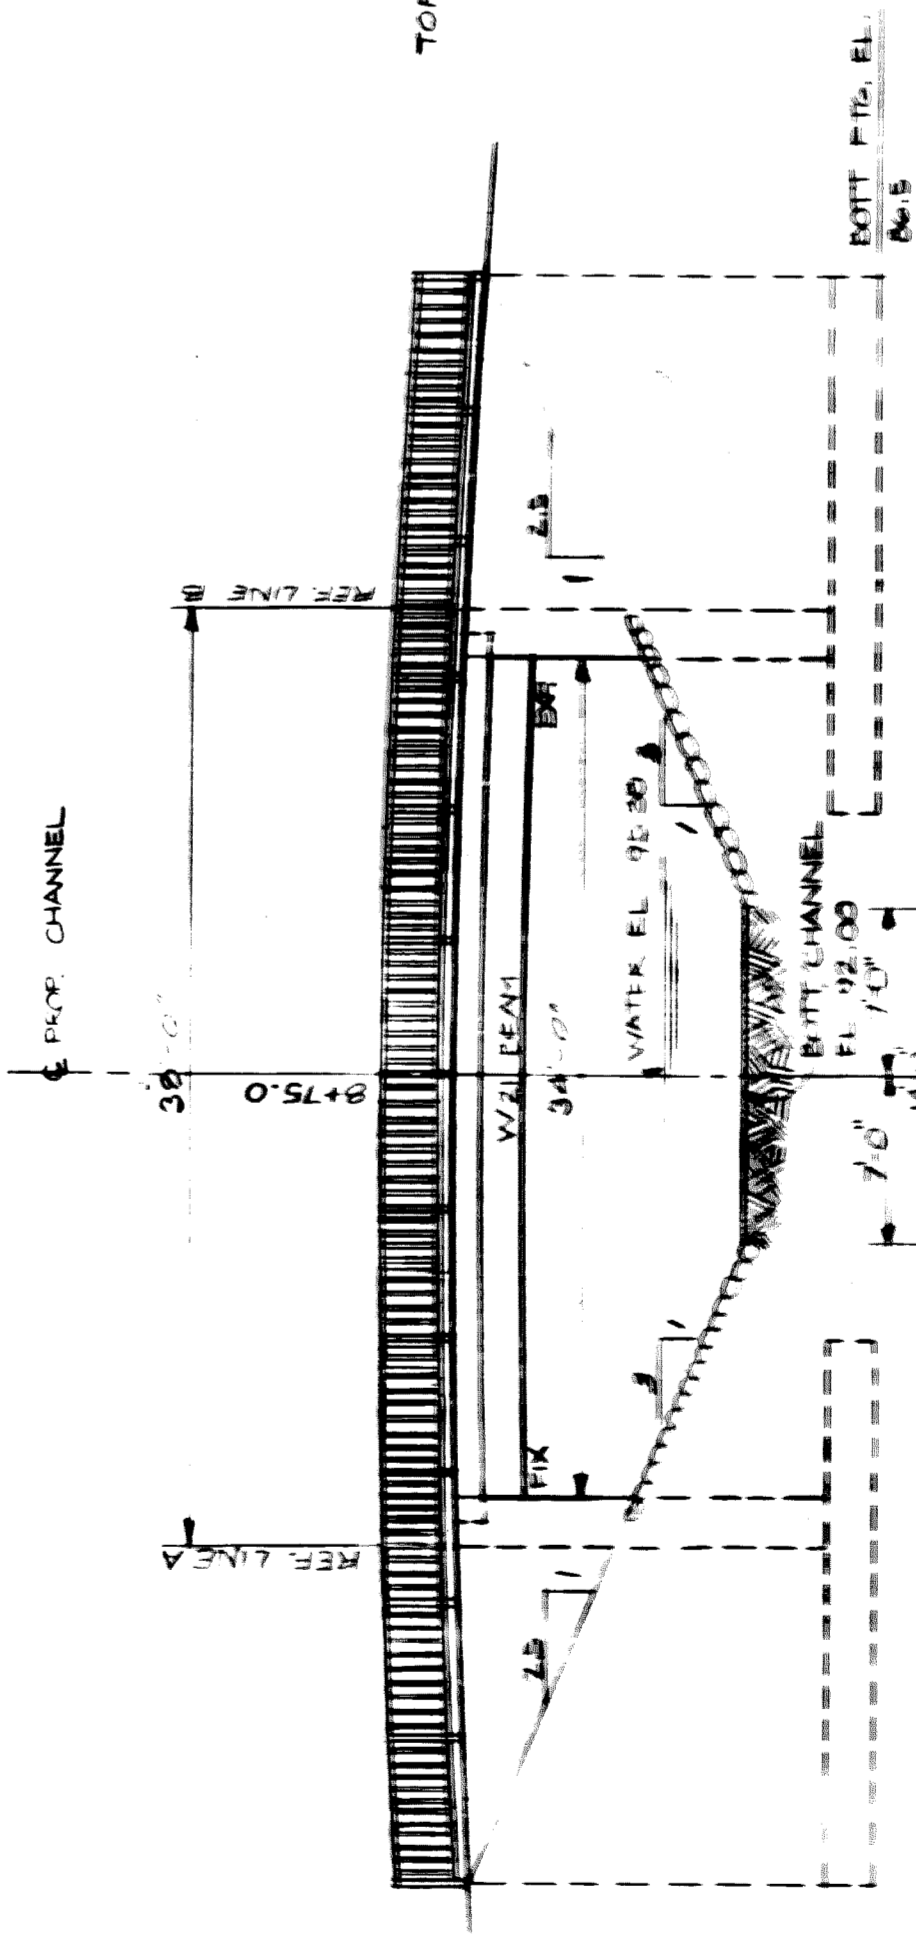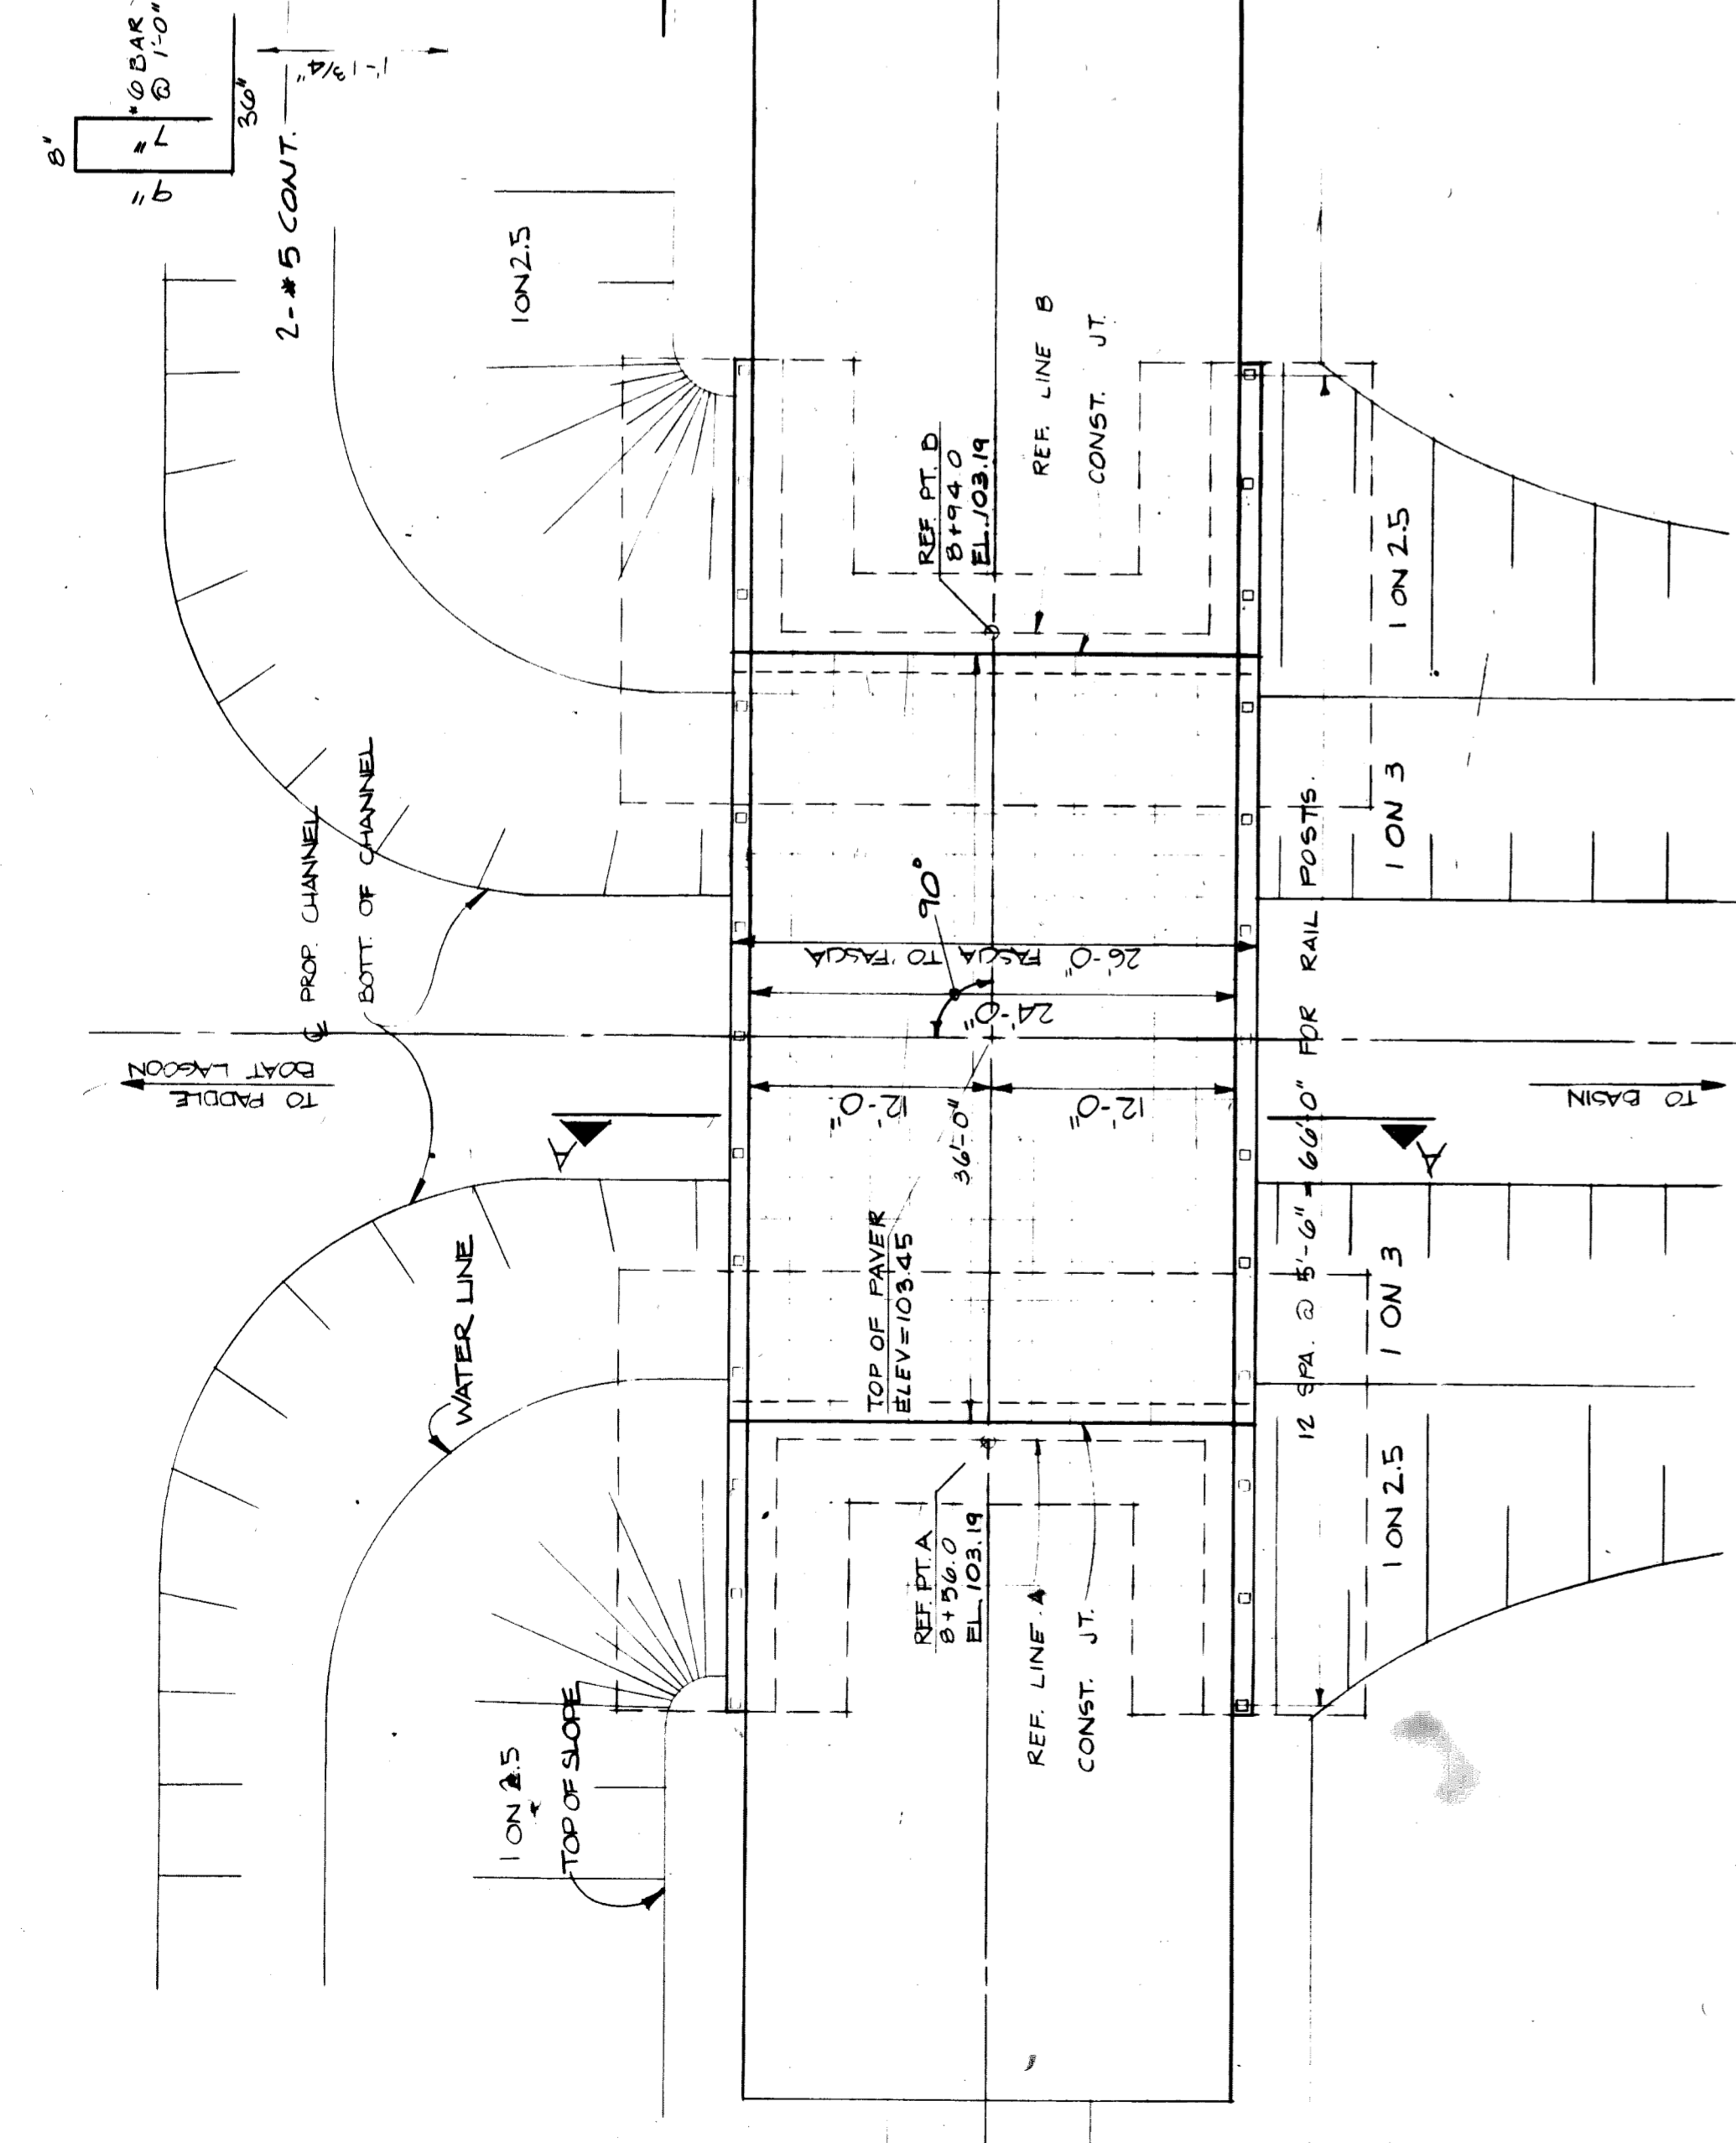

- GENERAL NOTES
- DESIGN LIVE LOAD: DPM VEHICLE  
12,000# 16'-0" 34,000# 16'-0"
  - MINIMUM SOIL BEARING CAPACITY ASSUMED AS 2500 PSF. FOOTING ELEVATIONS SHOWN ARE APPROXIMATE. FOOTINGS SHALL BEAR ON UNDISTURBED SOIL OF THE CAPACITY ASSUMED AND SHALL BE VERIFIED BY THE SOILS ENGINEER.
  - MINIMUM 28 DAY CONCRETE STRENGTH  
f'c = 4000 PSI DECK  
f'c = 3500 PSI ABUTMENTS  
MINIMUM STEEL REINFORCEMENT YIELD STRENGTH Fy = 60000 STRUCTURAL STEEL ASTM A36.
  - ALL BRIDGE CONSTRUCTION SHALL CONFORM TO THE MICHIGAN DEPARTMENT OF STATE HIGHWAYS AND TRANSPORTATION STANDARD SPECIFICATIONS FOR HIGHWAY CONSTRUCTION - 1979 EDITION UNLESS OTHERWISE ALLOWED BY THE ENGINEER.
  - BEAM CAMBER IS TO BE 2" PERMANENT AND OF A PARABOLIC TYPE.
  - THE OLD BRIDGE RAILING AND LOWER GILLAGE ARE OF HISTORIC IMPORTANCE AND THE CONTRACTOR SHALL EXHIBIT EXTREME CARE IN THE REMOVAL, REPAIR AND REINSTALLATION OF SAME. THE REINFORCEMENT OF THE RAILING AND GILLAGE IS OF NECESSITY SUBJECT TO FIELD CONDITIONS.
  - THE CONTRACTOR IS RESPONSIBLE FOR LOCATING AND PROTECTING ALL UNDERGROUND UTILITIES.
  - ADEQUATE TEMPORARY SHORING SHALL BE PROVIDED AT ALL TIMES DURING CONSTRUCTION UNTIL STRUCTURE IS COMPLETE.
  - ALL MATERIAL USED FOR BEARING WITH EXCEPTION OF PORTIONS NEEDED TO BEAR SHALL BE PLANT CLEANED AND GALVANIZED IN ACCORDANCE WITH ASTM A-129, EXCEPT THAT POSITION COWLS AND ANCHOR BOLTS INCLUDING NUTS AND WASHERS, SHALL BE GALVANIZED IN ACCORDANCE WITH ASTM A-155.

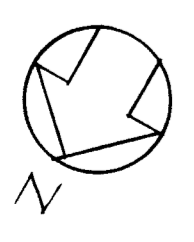





















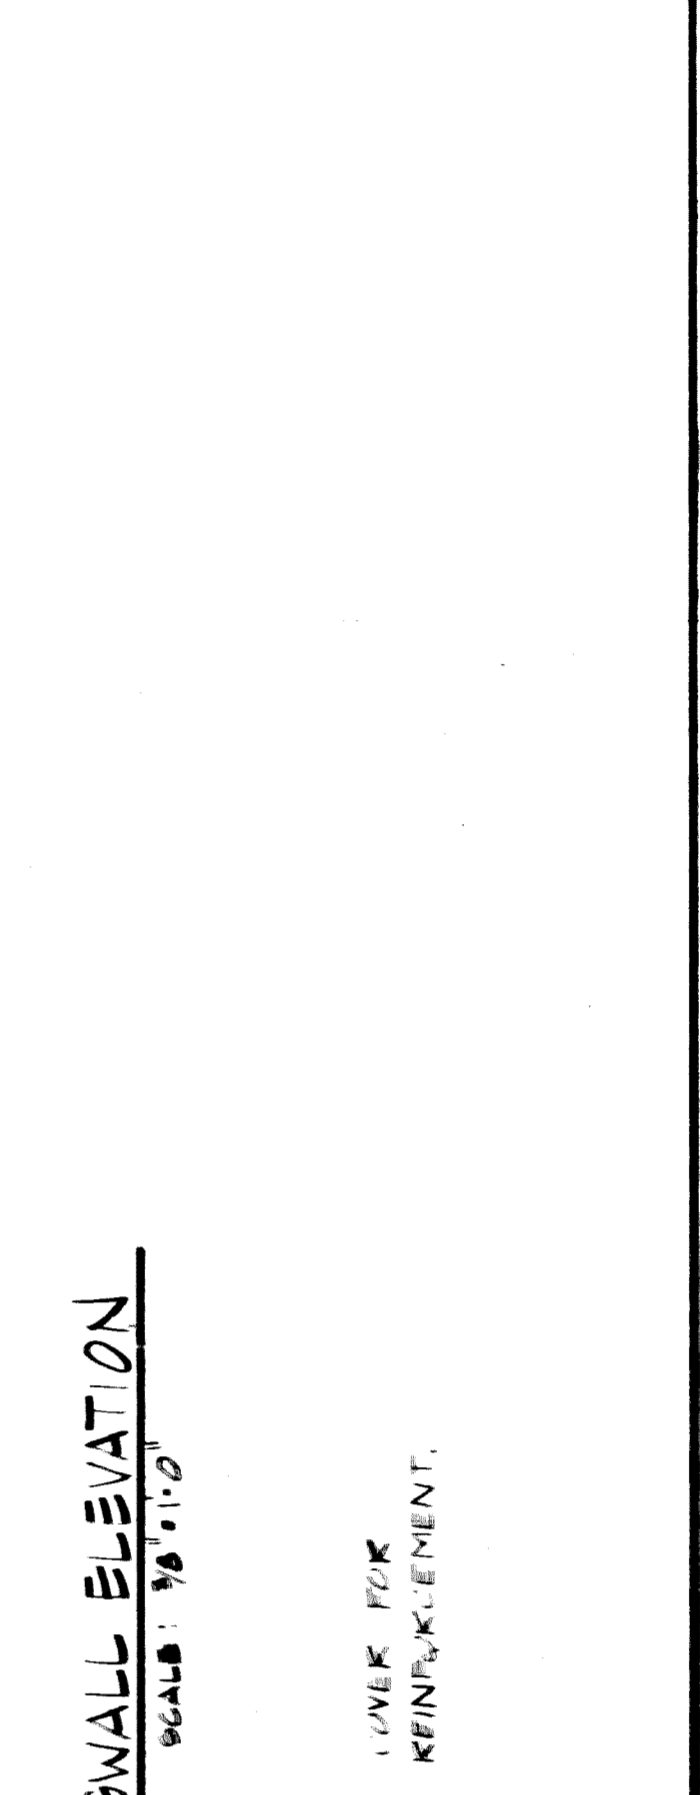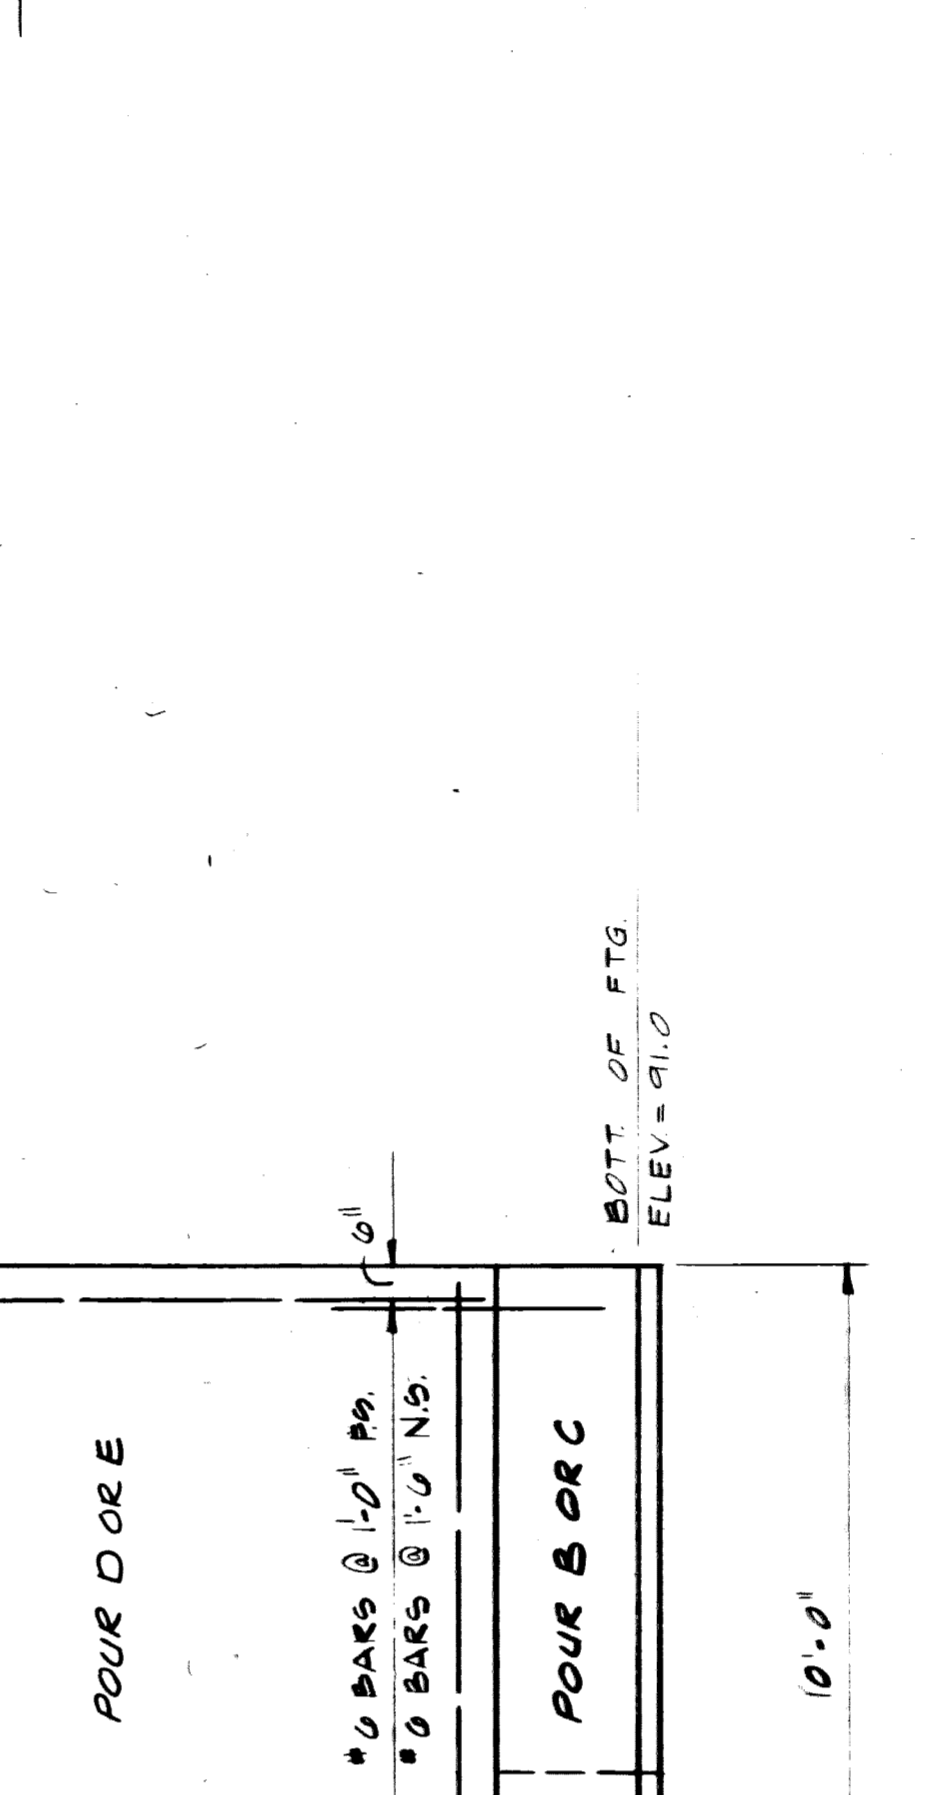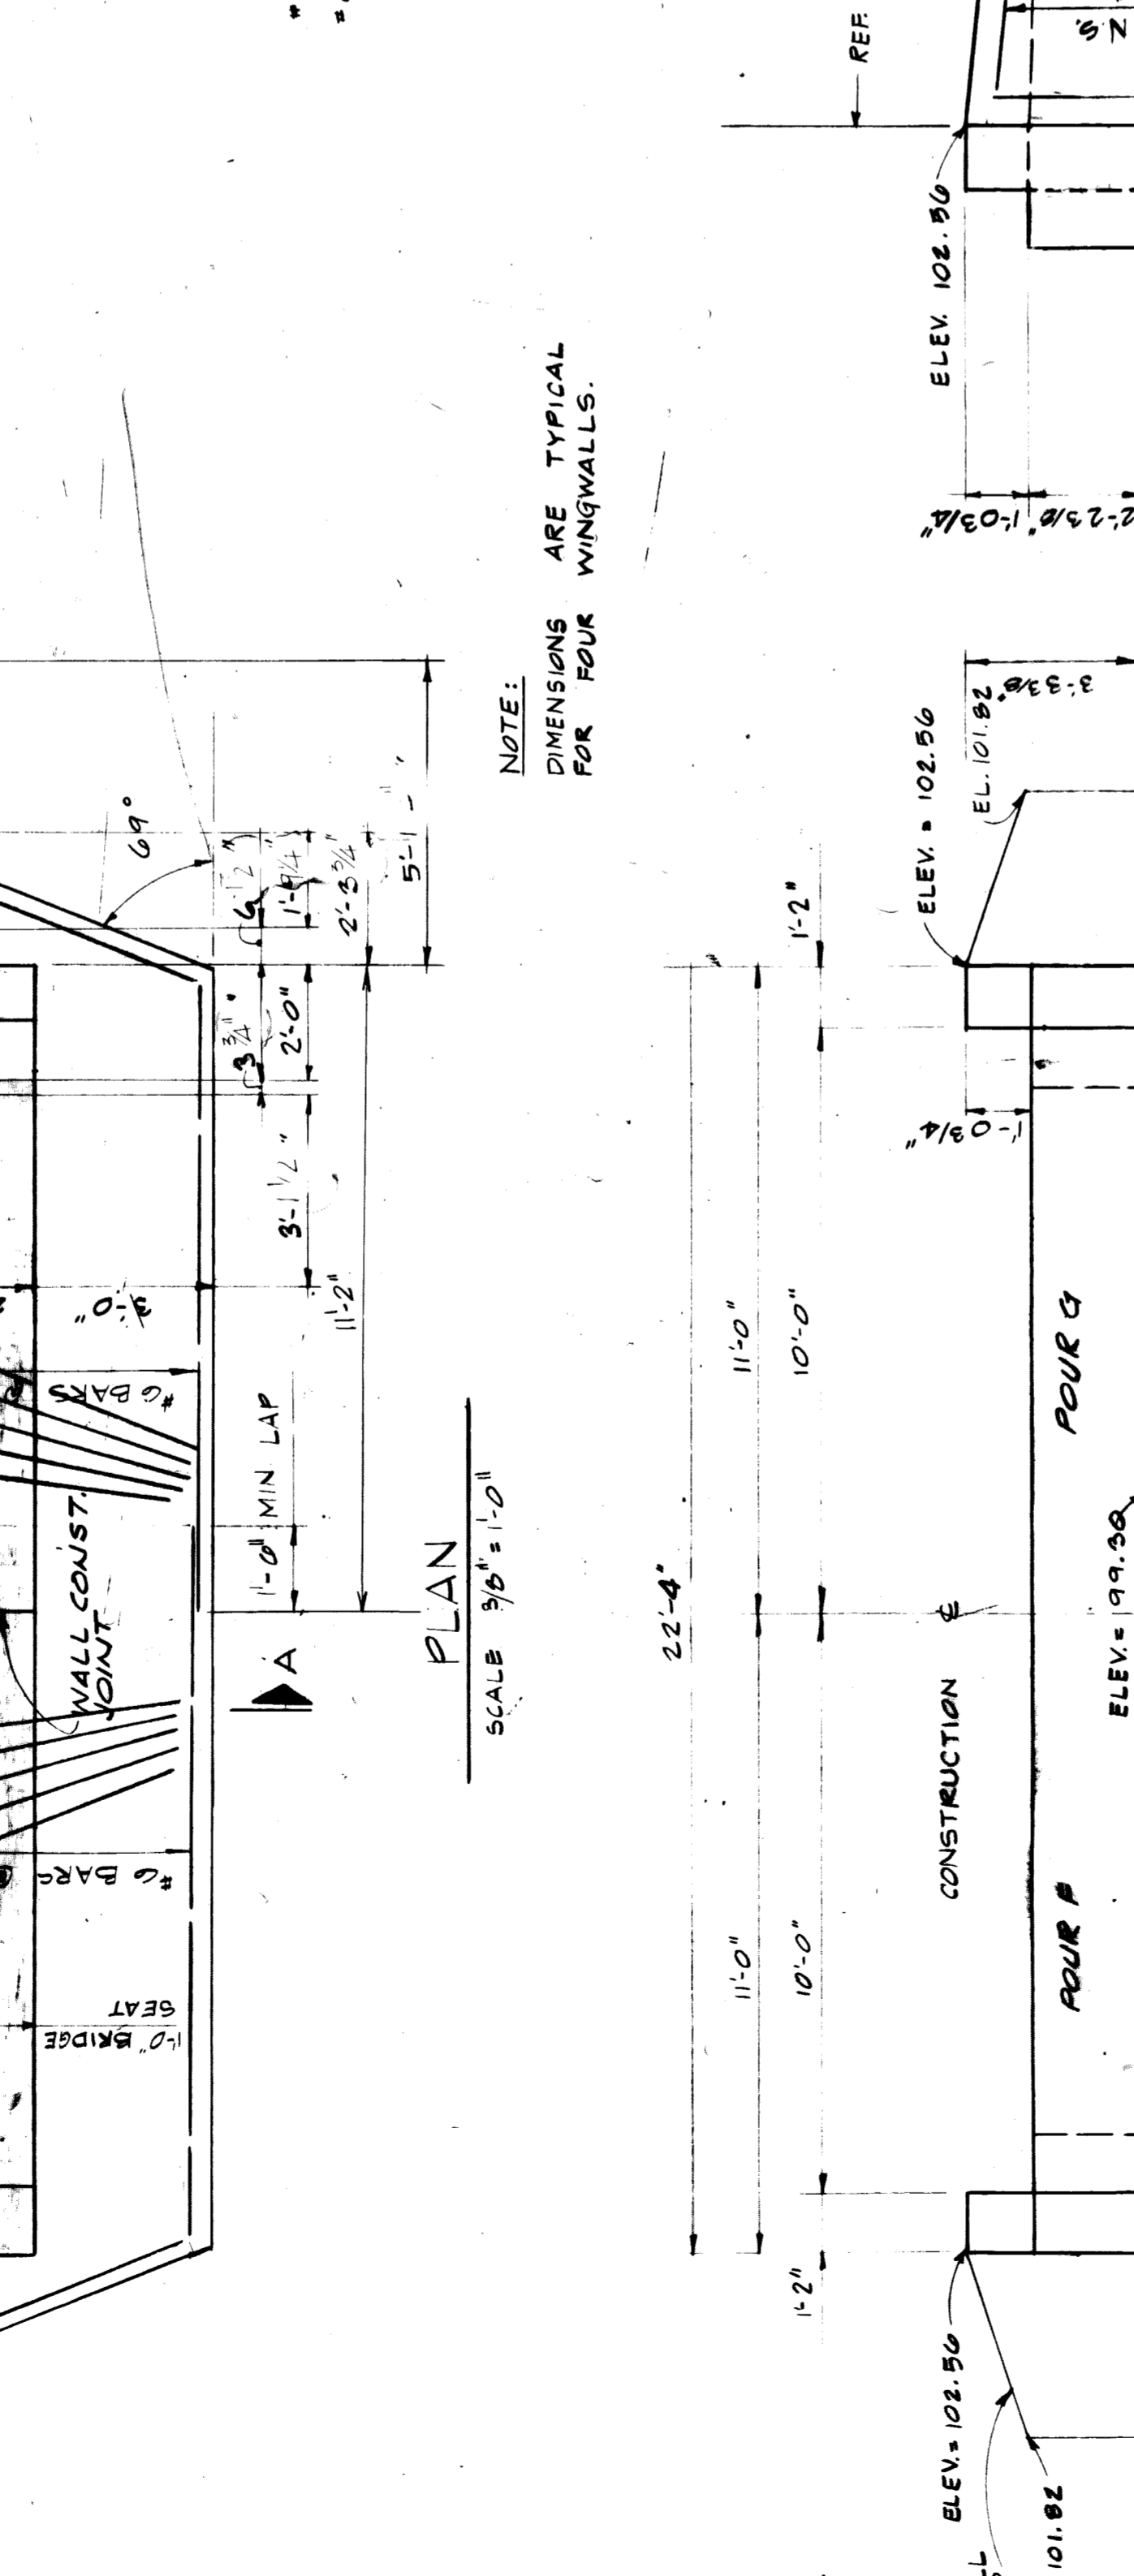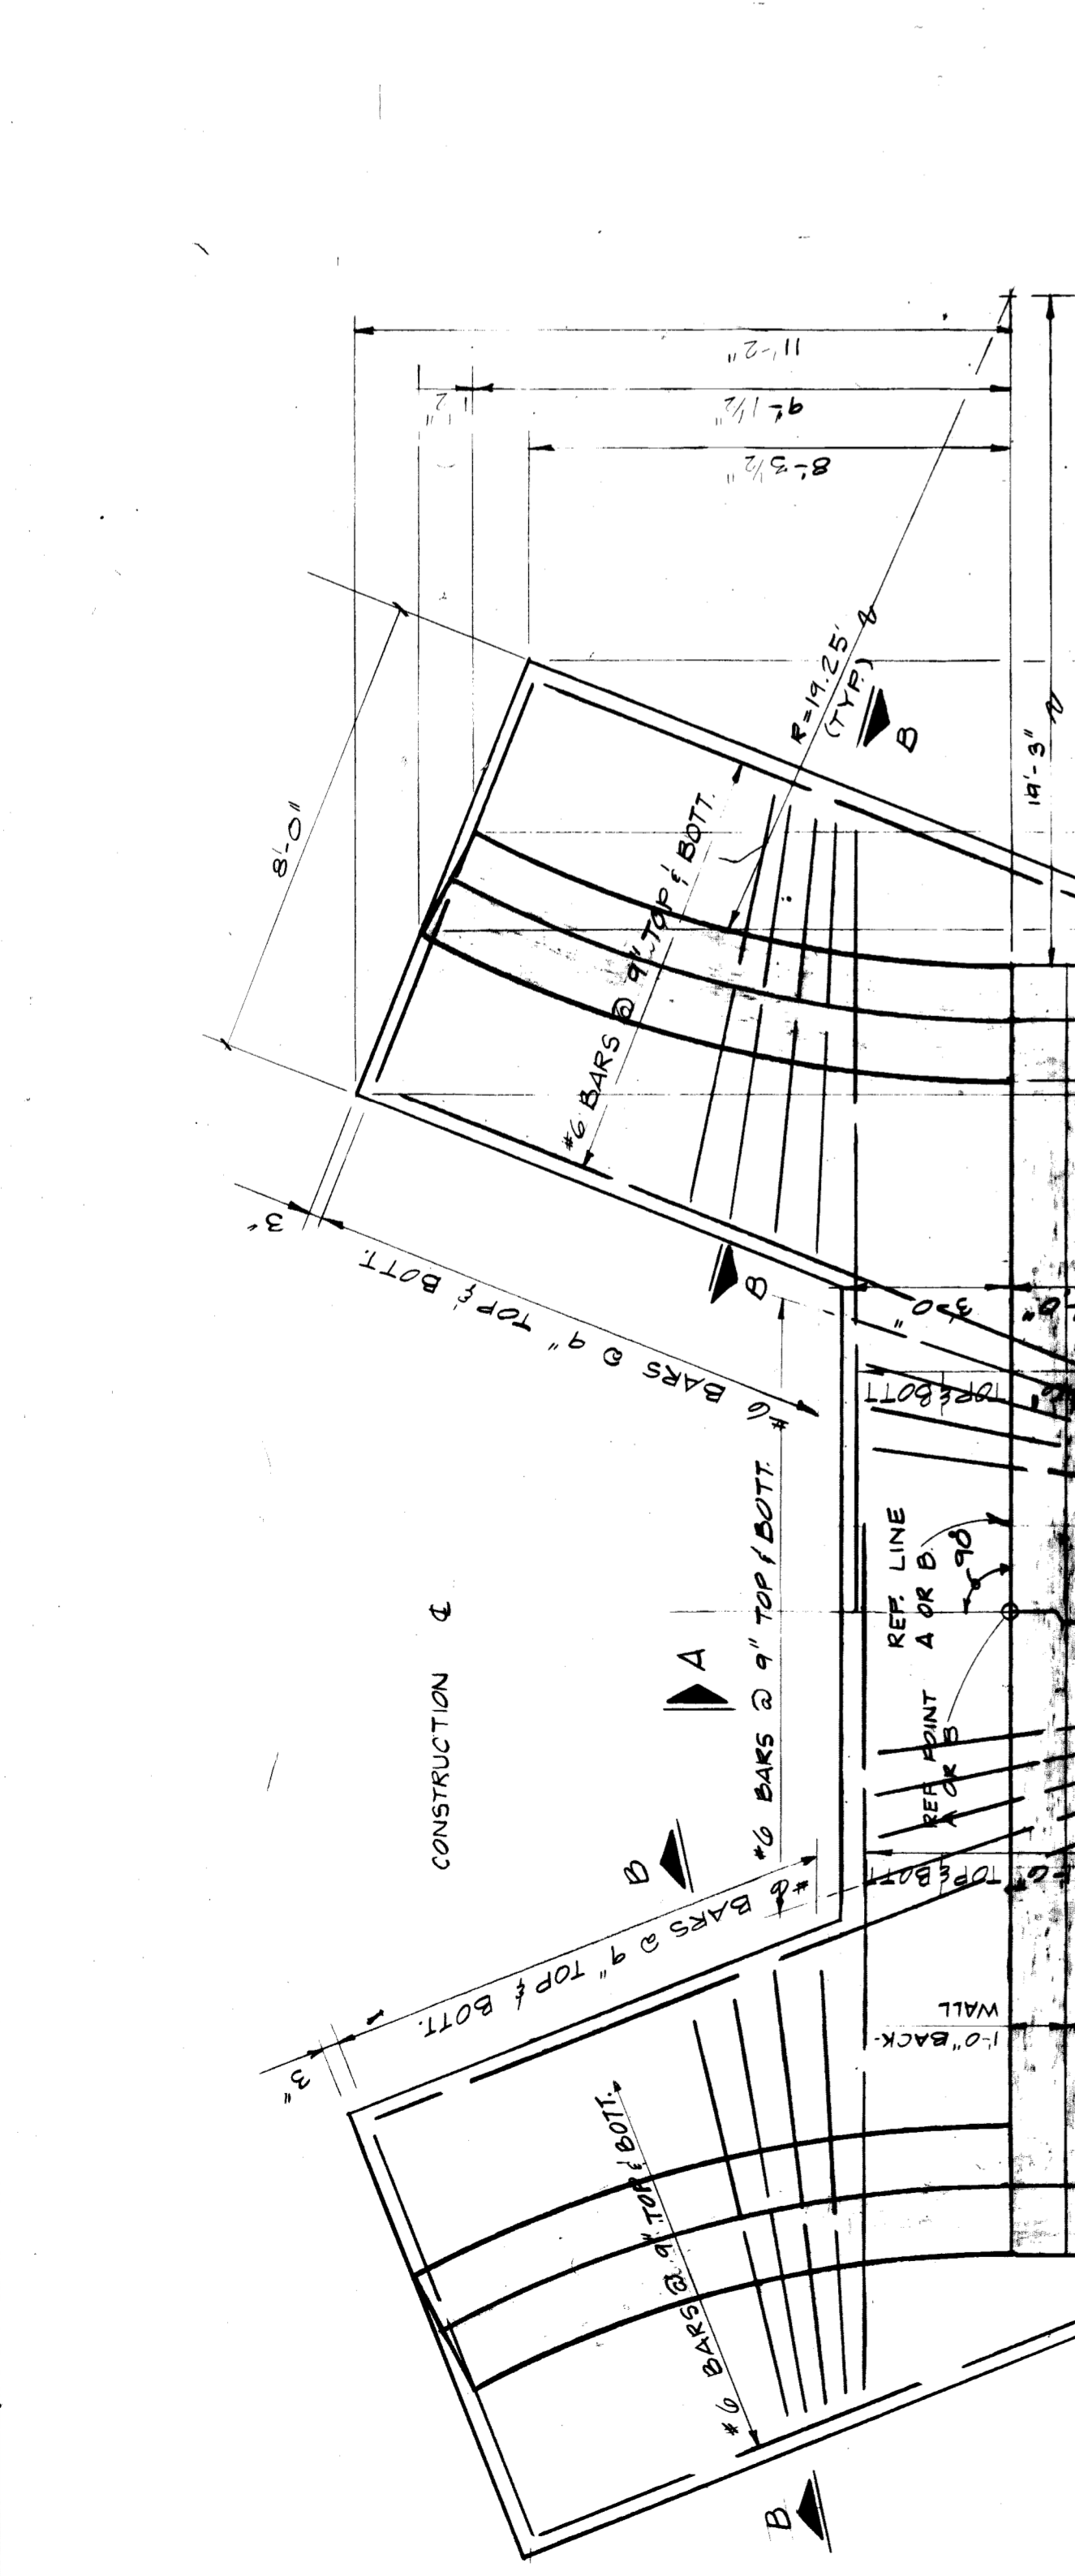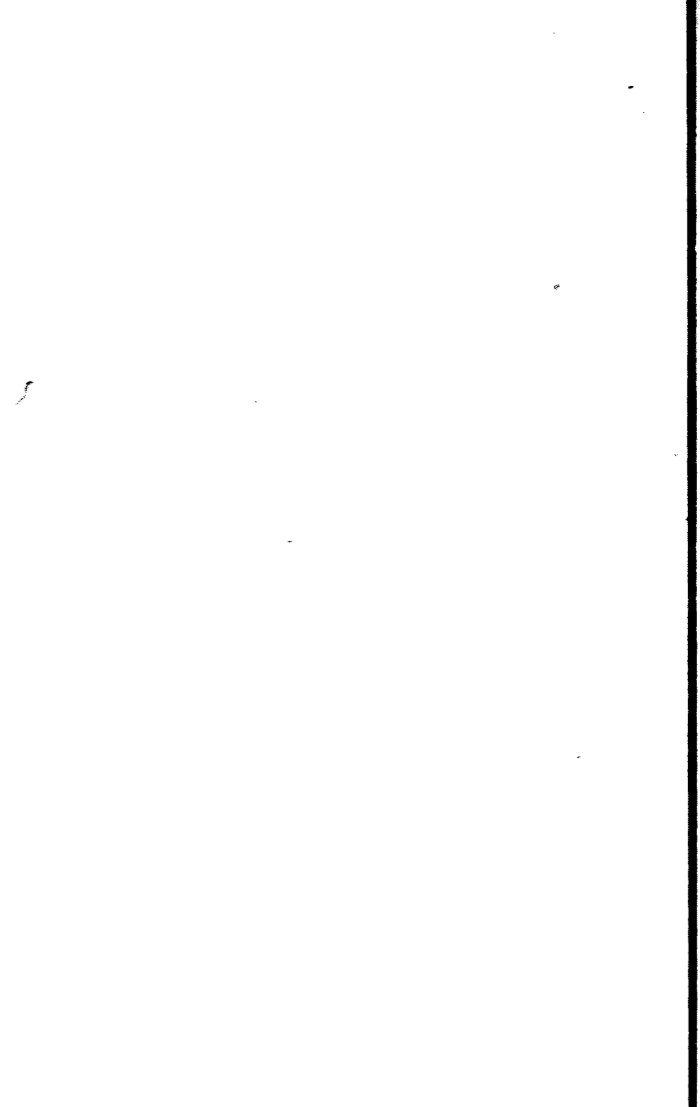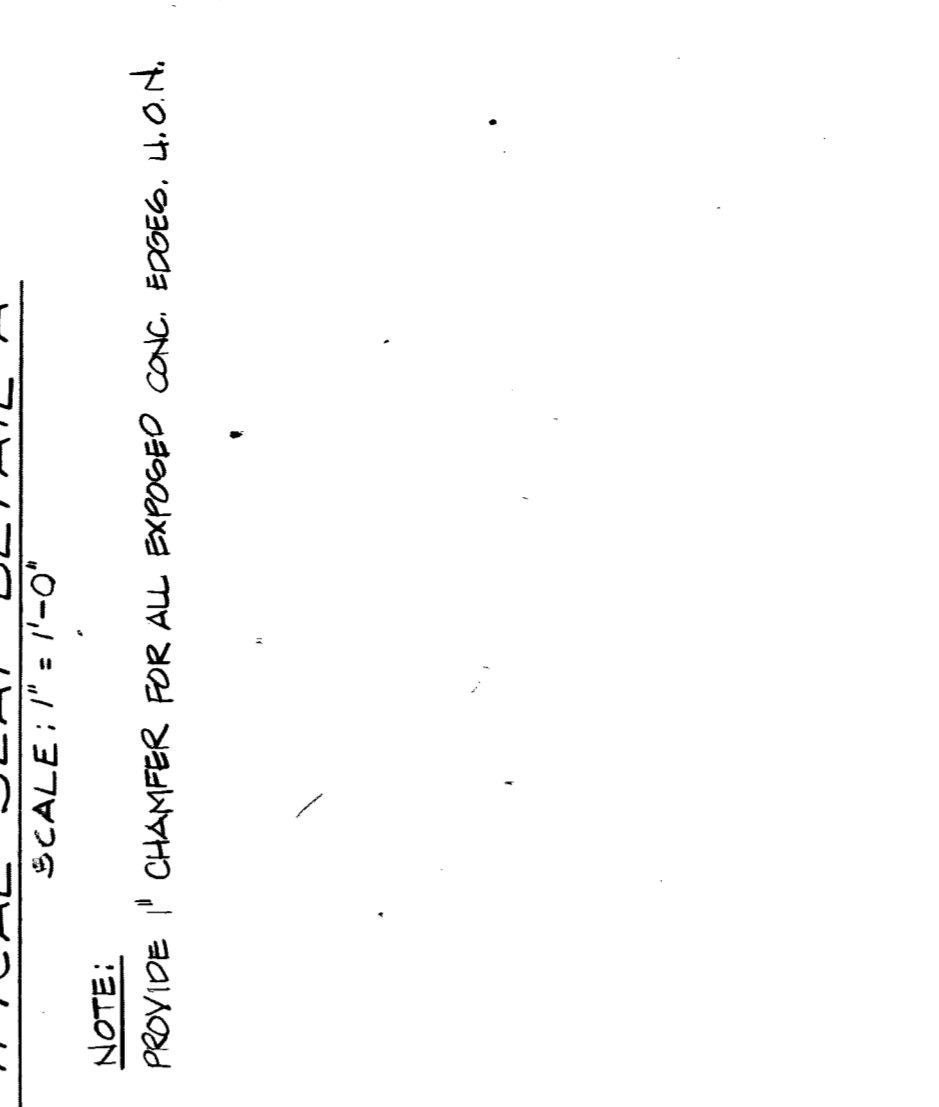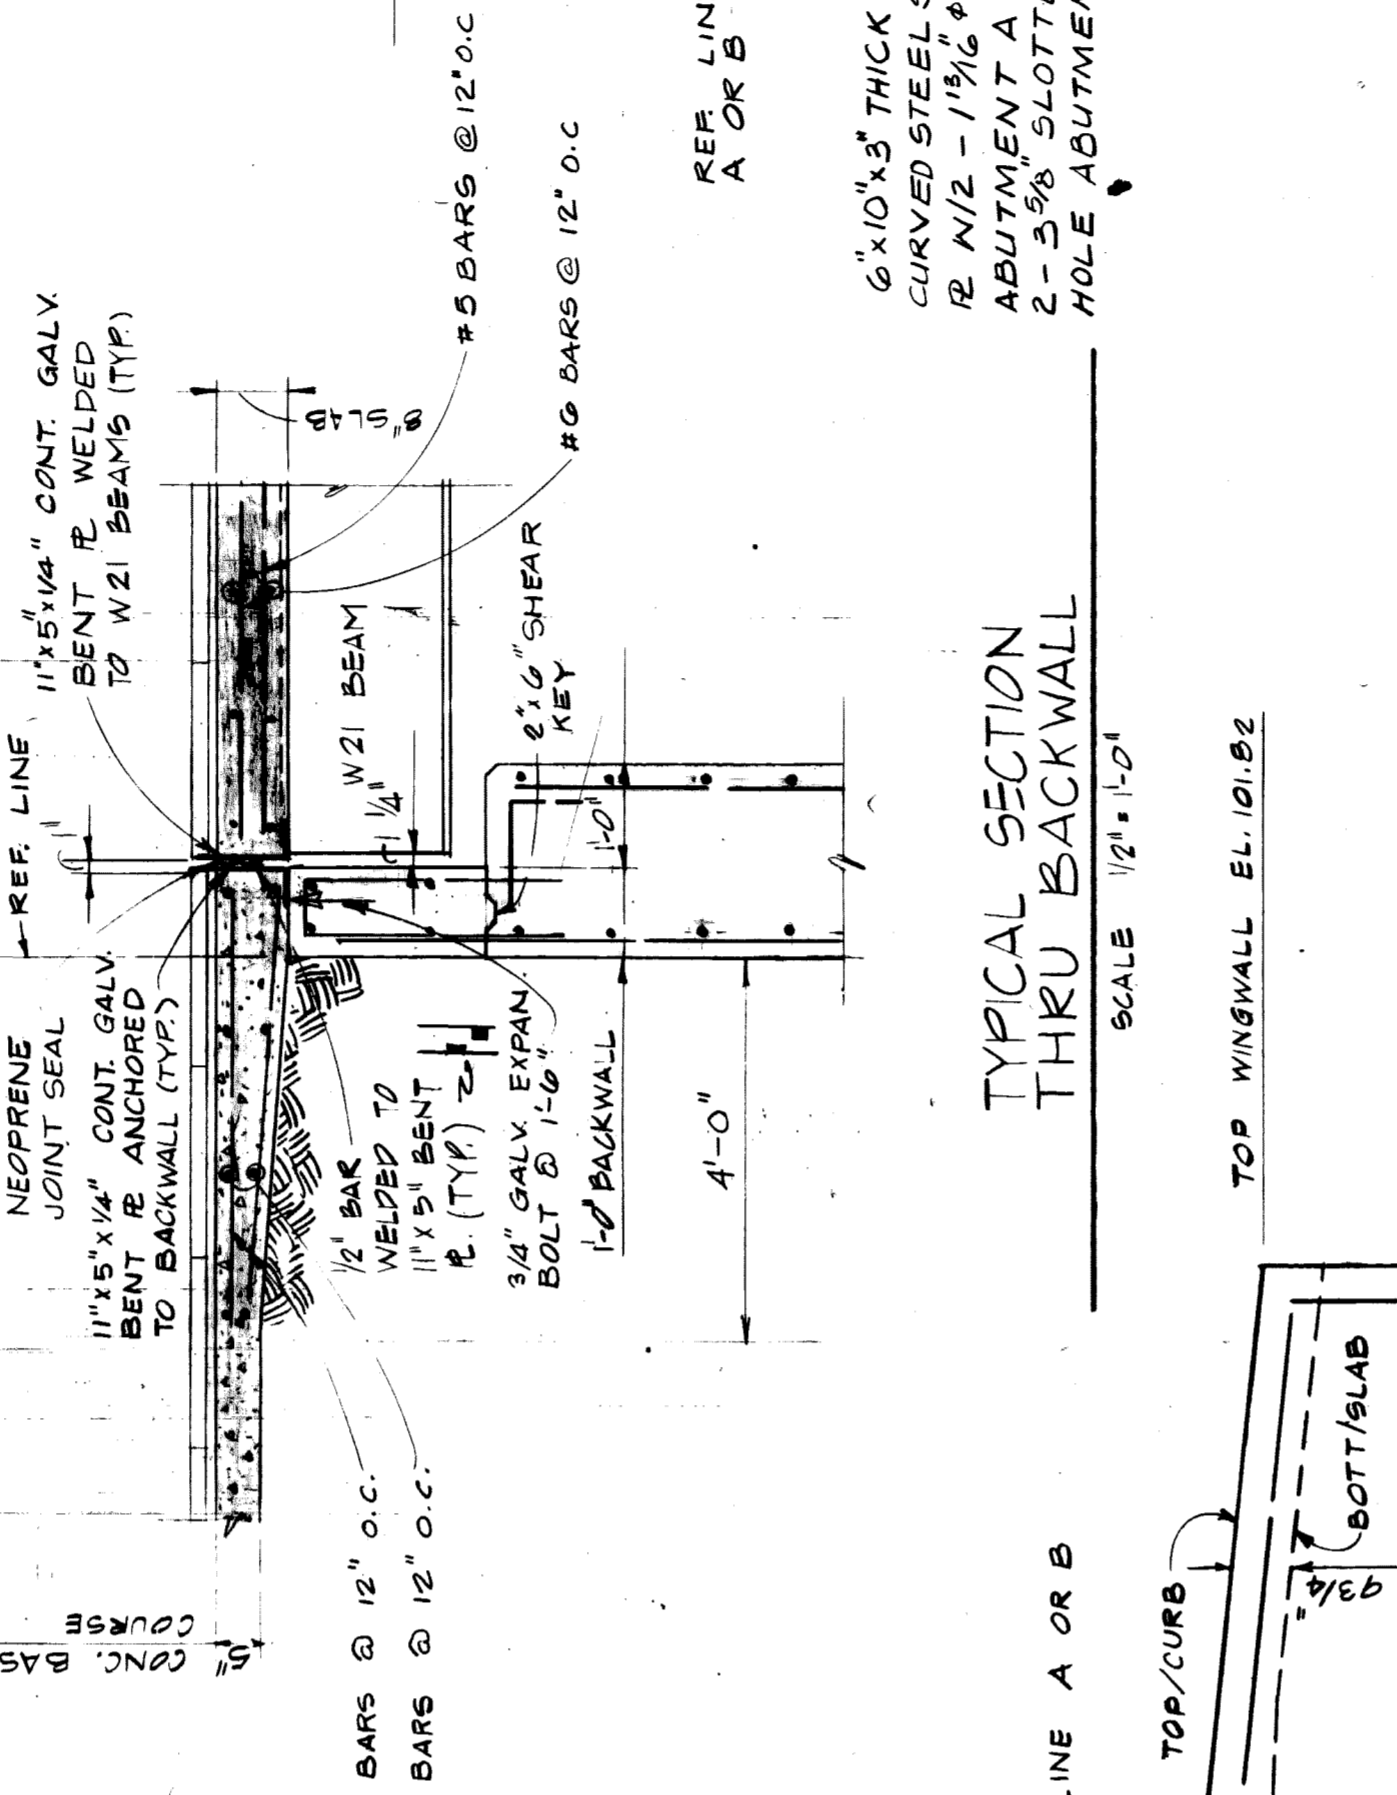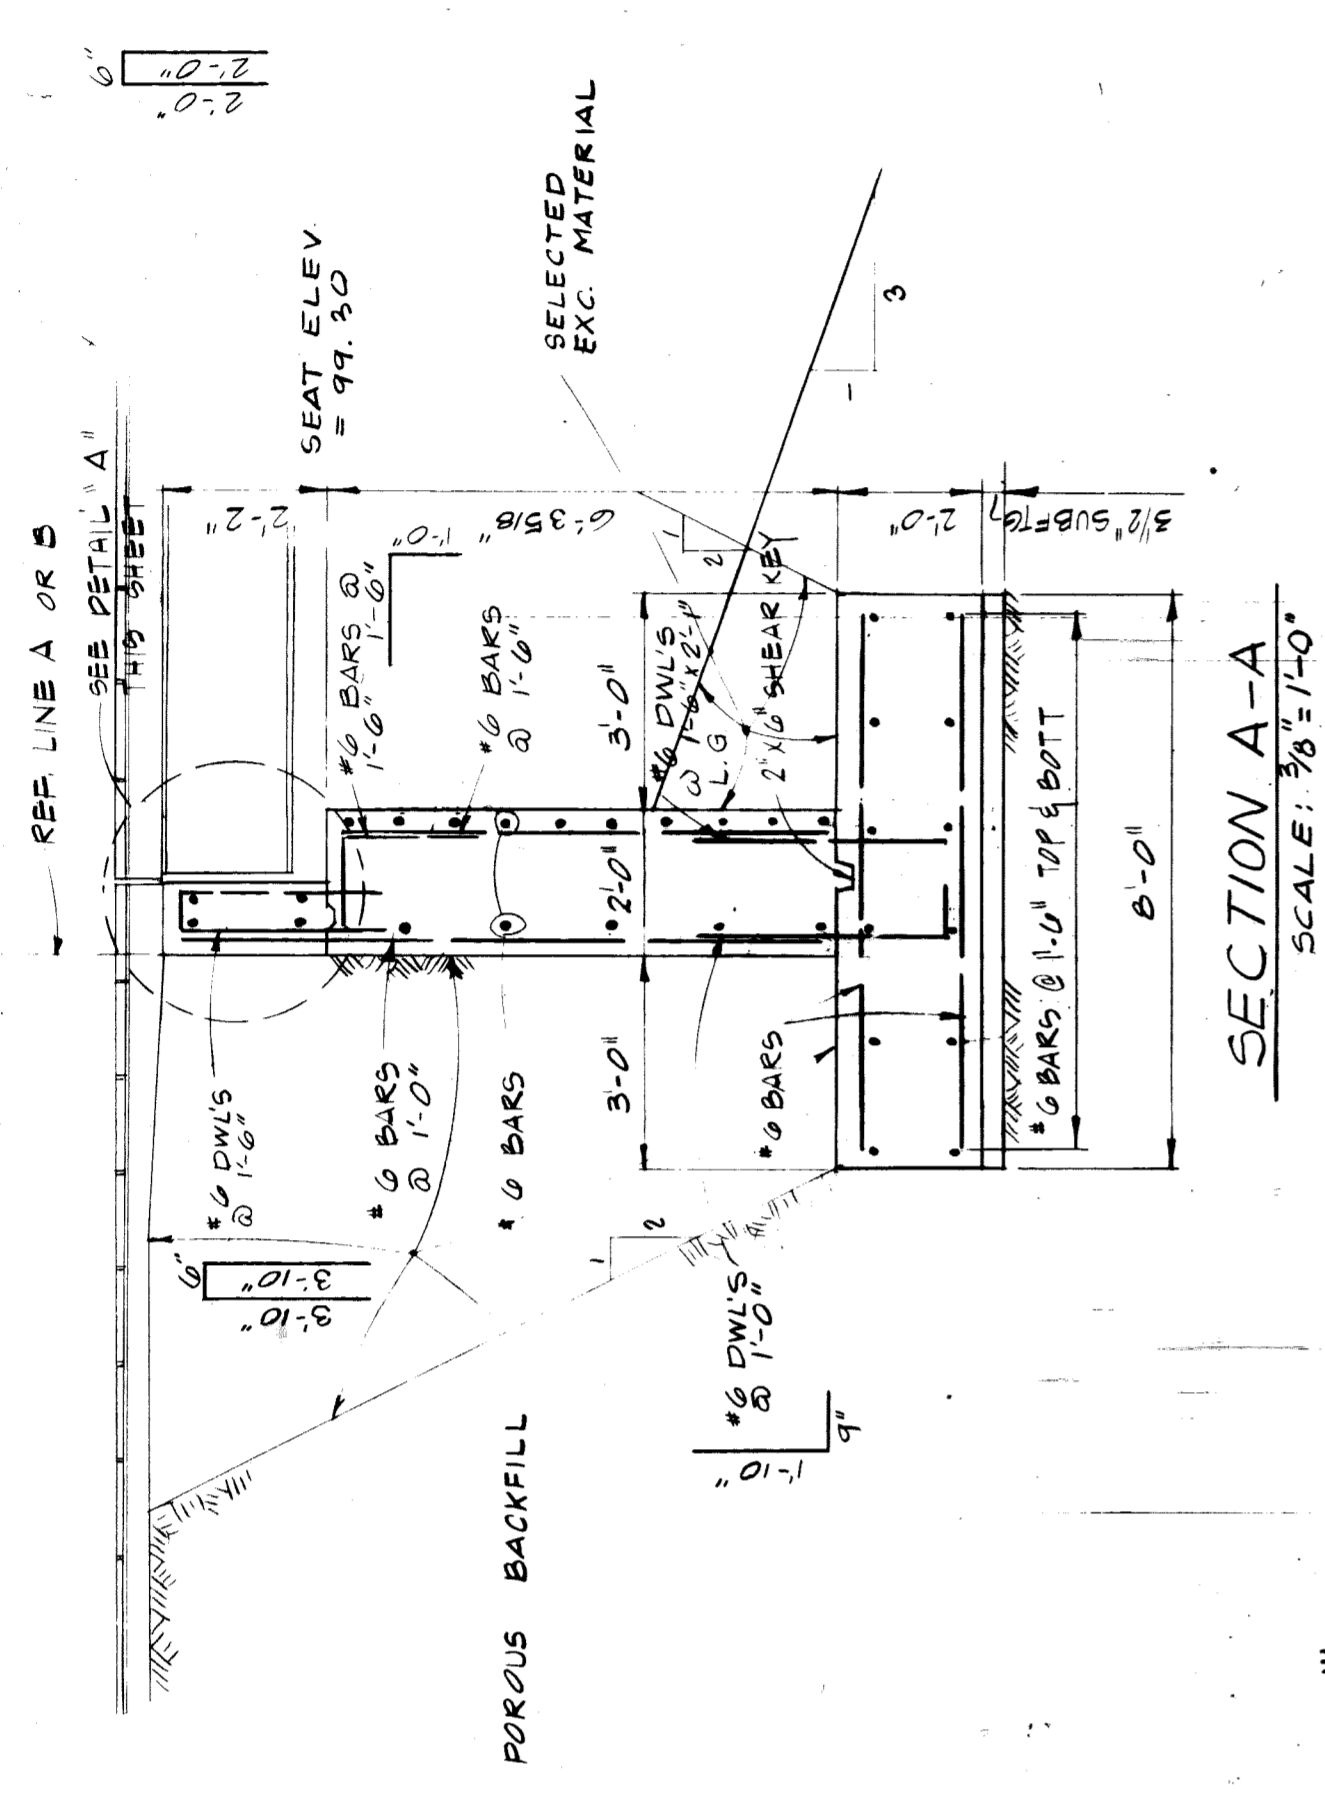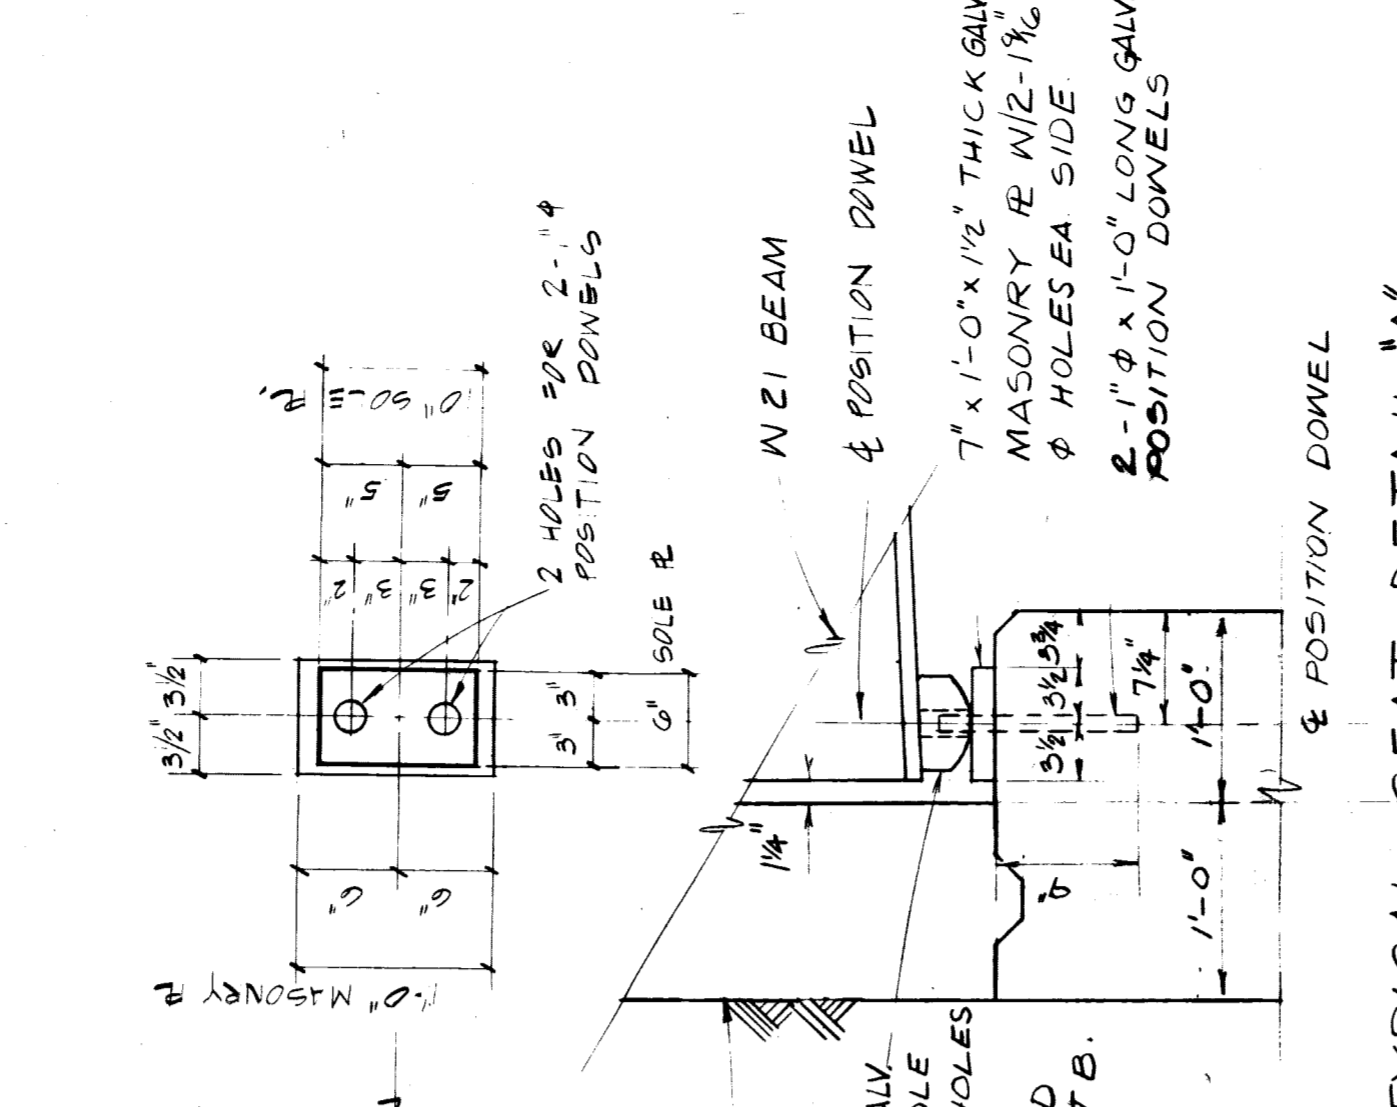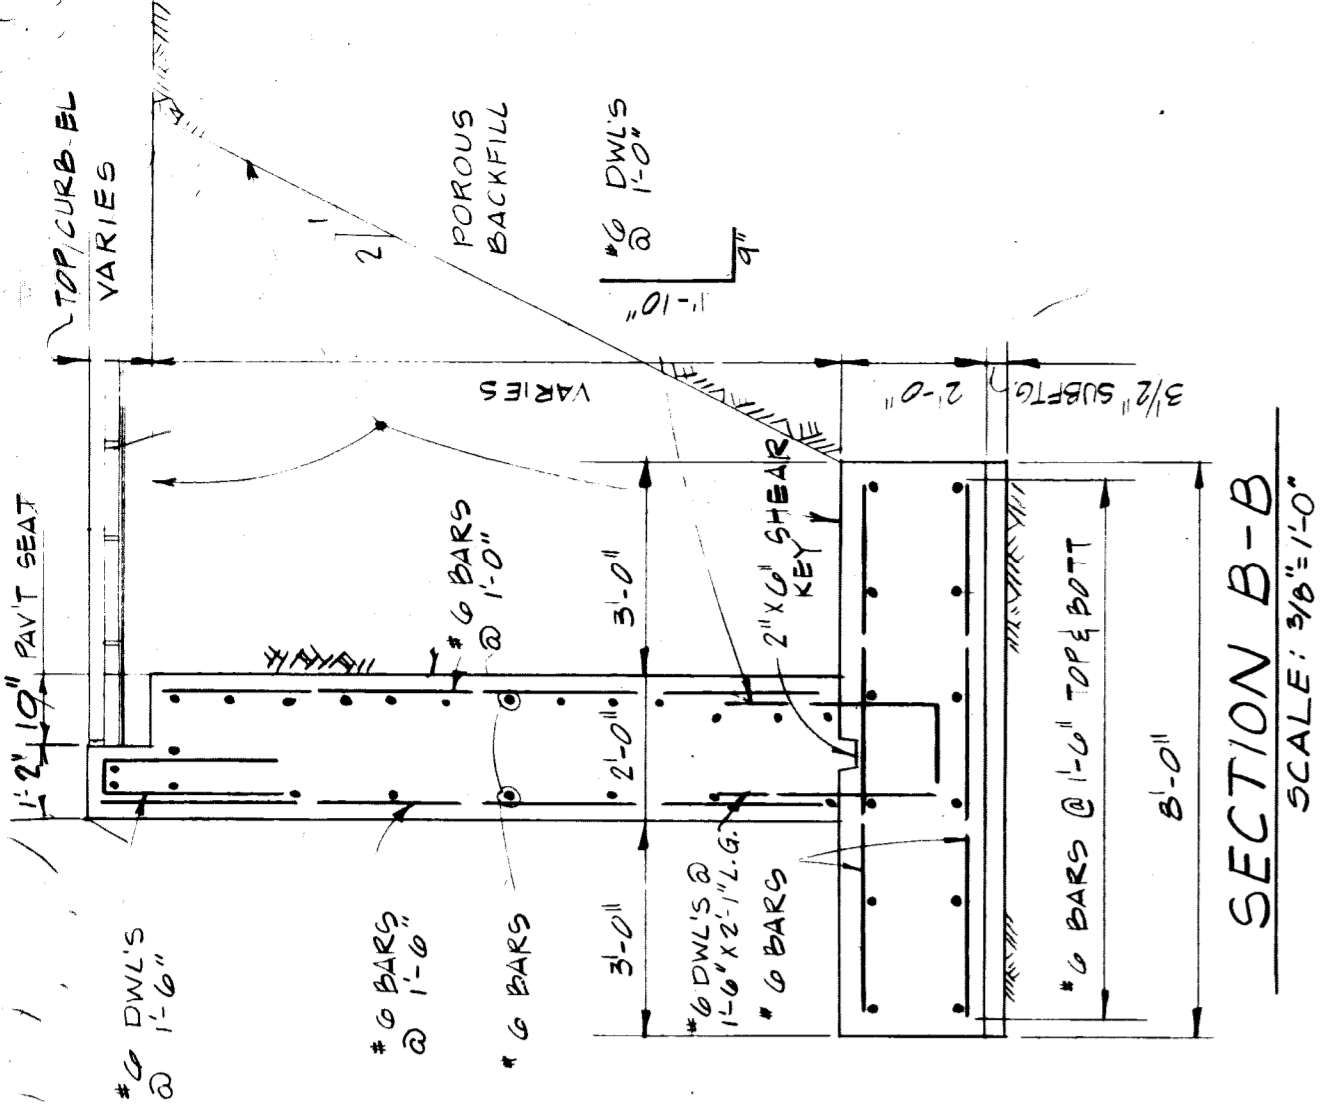

NOTE: DIMENSIONS ARE TYPICAL FOR FOUR WINGWALLS.

NOTE: PROVIDE 1" CHAMFER FOR ALL EXPOSED CONC. EDGES. 4:1:1.

NOTE: PROVIDE 3" MIN CONCRETE COVER FOR ALL SUBSTRUCTURE STEEL REINFORCEMENT.